DADON RESIDENCE

23939 PARK GRANADA, CALABASAS, CA 91302

EXISTING SINGLE-FAMILY RESIDENTIAL - MAJOR REMODEL & ADDITION



CLIENT/DEVELOPER

BARRY DADON

23939 PARK GRANADA, CALABASAS, CA 91302 EMAIL: BARRYDADON@GMAIL.COM TEL: 310.905.9943

ARCHITECT

SAJNI DESIGN & ARCHITECTURE 4195 CHINO HILLS PARKWAY, SUITE 599, CHINO HILLS, CA 91709 CONTACT: KEYUR MARU EMAIL: KMARU@SAJNIDESIGN.COM TEL: 714.390.0525

CIVIL ENGENEER

CHRISTENSEN & PLOUFF LAND SURVEYING 25570 RYE CANYON ROAD, SUITE A, VALENCIA, CA 91355 CONTACT: KACIE PLOUFF TEL: 661.645.9320

TITLE 24

ENERGY CONSULT LLC 1252 W 22ND STREET, #2, SAN PEDRO, CA 90731 CONTACT: IGOR PICHKO EMAIL: PLANS@TITLE24EZ.COM TEL: 424.247.7658

STRUCTURAL ENGINEER

NPSE, INC. 21781 VENTURA BLVD., #28A, WOODLAND HILLS, CA 91364 CONTACT: NALIN PANCHUNURI, P.E. EMAIL: NALIN@NPSEINC.COM TEL: 714.261.1333

PROJECT TITLE

THE FOLLOWING DESCRIPTION OF WORK PROVIDED IN CONJUNCTION WITH ALL CONSTRUCTION AND INSTALLATION SHALL CONFORM TO THE CURRENT EDITIONS OF ALL APPLICABLE FEDERAL, STATE, AND LOCAL REGULATIONS ALL OTHER PROVISIONS OF THE CONSTRUCTION AND CONTRACT INCLUDING BUT NOT LIMITED TO THE AMERICANS WITH DISABILITIES ACT DOCUMENTS. IT SHALL NOT BE CONSIDERED TO DESCRIBE ALL WORK (ADA)(NOTE: SINGLE FAMILY RESIDENCE EXEMPT) AND THE FOLLOWING:

- 2019 CALIFORNIA BUILDING CODE
- 2019 CALIFORNIA RESIDENTIAL CODE
- 2019 CALIFORNIA GREEN BUILDING STANDARDS CODE
- 2019 CALIFORNIA MECHANICAL CODE
- 2019 CALIFORNIA PLUMBING CODE
- 2019 CALIFORNIA ELECTRICAL CODE
- 2020 COUNTY OF LOS ANGELES FIRE CODE
- 2019 CALIFORNIA BUILDING ENERGY EFFICIENCY STANDARDS CODE
- AND THE CITY OF CALABASAS ORDINANCES

APPLICABLE CODES

DETAIL #
SHEET #

INTERIOR ELEVATION

NORTH ARROW

OPENING SYMBOL

WINDOW SYMBOL


DRAWING SYMBOLS

DOOR SYMBOL

— DETAIL #

SHEET#

AREA DETAIL

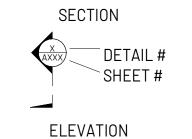

DETAIL #
SHEET #

- ROOM NAME 101 R00M# 150 SF Occupant Load Occupancy Classification

ROOM TAG

---- ROOM NAME - ROOM# Length X Width ——L X W

NECESSARY AS THAT IS ONLY DEFINED BY THE ENTIRETY OF THE DOCUMENTS. THEREFORE THE BID PRESENTED HERE-IN SHALL INCLUDE BUT NOT BE LIMITED TO THE FOLLOWING WORK: RESIDENTIAL ADDITION & MAJOR REMODEL OF EXISTING SINGLE-

- **FAMILY 2-STORY RESIDENCE:**
- a. NEW 3-CAR GARAGE
- ADDITION OF LIVING SPACE AT FIRST FLOOR,
- ADDITION OF LIVING SPACE AT SECOND FLOOR
- NEW COVERED ENTRY PORCH
- e. NEW OPEN COURTYARD AT FRONT YARD
- TWO OUTDOOR BALCONY DECKS AT SECOND FLOOR
- NEW COVERED PATIO AT REAR YARD
- h. MAJOR INTERIOR REMODEL, RECONFIGURATION OF NON-STRUCTURAL WALLS, NEW FINISHES, LEVELING FLOOR, ETC.
- SITEWORK:
 - a. NEW RETAINING OF WALL OF APPROX. 90 FEET, MAX. 3 FEET
 - NEW LANDSCAPING AND FLOORING AT FRONT YARD.

SCOPE OF WORK

DEFERRED SUBMITTALS

SUBMITTAL DOCUMENTS FOR DEFERRED SUBMITTAL ITEMS SHALL BE SUBMITTED AND APPROVED BY THE BUILDING DEPARTMENT PRIOR TO INSTALLATION. DEFERRED SUBMITTALS ARE LISTED BELOW:

PROJECT DIRECTORY

EXISTING LOT AREA:	24,960 SQ.FT (0.57 ACRES)
EXISTING RESIDENTIAL FLOOR	2,892 SQ.FT. (FIRST FLOOR AREA)
AREA (CONDITIONED):	1,578 SQ.FT. (SECOND FLOOR AREA)
	4,470 SQ.FT. (TOTAL FLOOR AREA)
EXISTING NON-RES. FLOOR AREA	446 SQ.FT. (2-CAR GARAGE)
PROPOSED RESIDENTIAL FLOOR AREA (CONDITIONED): FIRST FLOOR RES. ADDITION: 715.5 SF	446 SQ.FT. (2-CAR GARAGE)
	892 SQ.FT. (TOTAL FLOOR AREA)
	4,499.5 SQ.FT. (FIRST FLOOR AREA)
	2,132 SQ.FT. (SECOND FLOOR AREA)
(E) FIRST FLOOR GARAGE CONVERSION INTO RESIDENTIAL FLOOR AREA: 892 SF SECOND FLOOR RES. ADDITION: 554 SF	6,631.5 SQ.FT. (TOTAL RES. FLOOR AREA)
TOTAL RES. FLOOR AREA ADDITION: 2,161.5 SF	
PROPOSED NON-RES. FLOOR AREA (UNCONDITIONED): TOTAL NON-RESIDENTIAL UNCONDITIONED FLOOR AREA ADDITION: 848 SF	624 SQ.FT. (3-CAR GARAGE)
	446 SQ.FT. (COVERED FRONT PORCH)
	495 SO ET (COVERED REAR PATIO)

(UNICONDITIONED)		
(UNCONDITIONED): TOTAL NON-RESIDENTIAL UNCONDITIONED FLOOR AREA ADDITION: 848 SF	446 SQ.FT. (COVERED FRONT PORCH)	
	495 SQ.FT. (COVERED REAR PATIO)	
	175 SQ.FT. (SECOND FLOOR DECKS)	
	1,740 SQ.FT. (TOTAL FLOOR AREA)	
MAXIMUM LOT COVERAGE:	= 35 % = 8,736 SQ. FT.	
PROPOSED LOT COVERAGE:	= 5,727 SQ. FT. / 24,960 SF	
	= 23 % < 35 % OK	
REQUIRED YARDS:	= 20' - 0" (FRONT)	
	= 20' - 0"(REAR)	
	= 10' - 0" (INTERIOR SIDE)	
	= 15' - 0" (STREET SIDE)	

GE:	= 5,727 SQ. FT. / 24,960 SF	Z
	= 23 % < 35 % OK	0
	= 20' - 0"(FRONT)	F
	= 20' - 0"(REAR)	F S
	= 10' - 0" (INTERIOR SIDE)	ა
		H

REQUIRED PARKING SPACES: 2 COVERED 3 (COVERED IN GARAGE) **PROPOSED PARKING SPACES:**

27 - 6 1/2" < 35'-0"

35'-0"

MAXIMUM HEIGHT LIMIT:

PROPOSED MAXIMUM HEIGHT:

PROJECT DATA

LEGAL INFORMATION

ARCHITECTURAL

INSULATION

LAVATORY

MAXIMUM

MINIMUM

MOUNTED

METAL

MECHANICAL

MANUFACTURER

MISCELLANEOUS

NOT TO SCALE

ON CENTER

OPENING

OPPOSITE

PLYWOOD

RADIUS

ROOF DRAIN

REFRIGERATOR

RECESSED

REQUIRED

SCHEDULE

SQUARE FEET

SPECIFICATION

SECTION

SHEET

SIMILAR

SOUARE

STEEL

STANDARD

STORAGE

STRUCTURAL

TOP OF CURB;

TELEPHONE

TEMPERED TEMPERED

TOP OF PLATE

TOP OF WALL

UNLESS OTHERWISE

TYPICAL

VERTICAL

WASHER

WOOD

WITHOUT

VERIFY IN FIELD

WATER CLOSET

OR TOP OF CONCRETE

LIN.

NO. OR #

OPNG.

STL.

T.W.

AIR CONDITIONING UNIT

ACCESS PANEL

BLOCK

CODE

CEILING

CLEAR

CONCRETE

CORRIDOR

DOUBLE

DETAIL

DIAMETER

DISPENSER

DRAWER

DRAWING

ELEVATION

EQUIPMENT

FINIGH FLOOR

FLASHING

FIREPLACE

FOOTING

GAUGE

GRADE

GYPSUM

HOSE BIB

HORIZONTAL

HEIGHT

HOLLOW METAL

GALVANIZED

GARBAGE DISPOSER

EXTERIOR

EQUAL

DEPARTMENT

CONCRETE MASONRY

BLOCKING

A.P.

BLK.

CAB.

CBC

CLR.

COL.

CONC.

CONT

CORR.

C.M.U.

DBL.

DEPT

DET.

DN.

DW

DWG.

EQPT.

F.F.

FIN.

FTG.

GALV

GYP.

DWR.

A001	COVER SHEET
A002	GENERAL NOTES
A003	EXTERIOR 3D VIEWS
A004	EXISTING IMAGES
A005	SITE COMPARISON
A006	CALGREEN BLDG STDS CODES
A007	CALGREEN BLDG STDS CODES
A008	CONSTRUCTION LOGISTICS
A009	EXISTING RECORDS
A100	EXISTING SITE PLAN
A101	PROPOSED SITE PLAN
A200	EXISTING FIRST LEVEL PLAN
A201	EXISTING SECOND LVL PLAN
A202	EXISTING ROOF PLAN
A203	FIRST FLOOR DEMOLITION PLAN
A204	SECOND FLOOR DEMOLITION PLAN
A205	PROPOSED FIRST LEVEL PLAN
A206	PROPOSED SECOND LVL PLAN
A207	PROPOSED ROOF PLAN
A208	PROPOSED FIRST FLOOR RCP
A209	PROPOSED SECOND FLOOR RCP
A300	EXISTING ELEVATIONS
A301	EXISTING ELEVATIONS
A302	PROPOSED ELEVATIONS
A303	PROPOSED ELEVATIONS
A400	PROPOSED SECTIONS
A401	PROPOSED SECTIONS
A402	PROPOSED SECTIONS
A403	PROPOSED SECTIONS
A500	INTERIOR ELEVATION
A501	INTERIOR ELEVATION
A600	DOOR SCHEDULE
A601	WINDOW SCHEDULE
A700	DETAILS
A701	DETAILS
A800	COLOR AND MATERIAL BOARD

<u>CIVIL</u>


CIVIL SURVEY

ABBREVIATIONS

APN NUMBER:	2069-036-068
TRACT/LOT:	LOT 22 OF TRACT 34015
ZONING CODE:	RS (SINGLE RESIDENTIAL)
OCCUPANCY:	R-3 / U
FIRE ZONE: FLOOD ZONE: SCENIC CORRIDOR:	4 NO NO
НОА:	WESTRIDGE
CONSTRUCTION TYPE:	TYPE V-B
SPRINKLERED:	NO

EXISTING LOT AREA: 24,960 SF (0.57 ACRES)

DRAWING INDEX

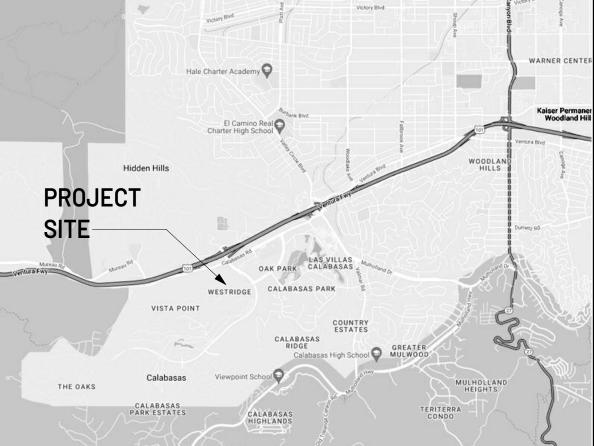

RETURNED UPON THE WRITTEN REQUEST OF sda. © COPYRIGHT 2022 SAJNI DESIGN & ARCHITECTURE

BILAWING BATA.	
PROJECT NO	220625
ISSUE DATE	04.01.2022
SCALE	1/4" = 1'-0"
DRAWN BY	Author
SHEET SIZE	24" x 36"

COVER SHEET



4195 CHINO HILLS PKWY, SUITE 599 CHINO HILLS, CA 91709

CONTACT: KEYUR MARU KMARU@SAJNIDESIGN.COM

BARRY DADON

EMAIL: BARRYDADON@GMAIL.COM


23939 PARK GRANADA, CALABASAS, CA 91302

TEL: 310.905.9943

DADON RESIDENCE

23939 PARK GRANADA, CALABASAS, CA 91302


STAMP:

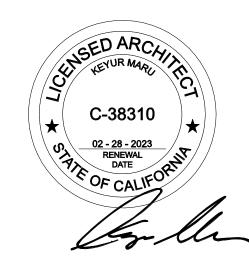

REPRODUCED IN WHOLE OR IN PART. IT IS TO BE USED FOR THE PROJECT AND SITE SPECIFICALLY IDENTIFIED HEREIN AND IS NOT


DRAWING DATA:

IF SHEET IS LESS THAN SIZE INDICATED ABOVE, THIS IS A REDUCED

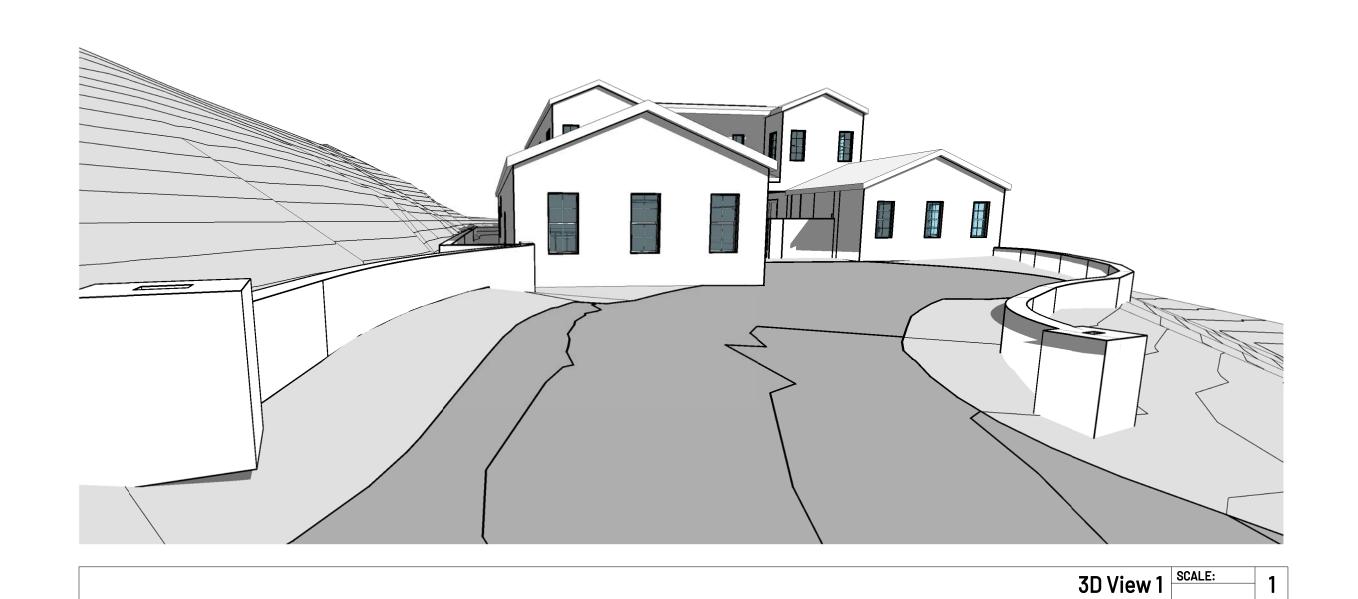





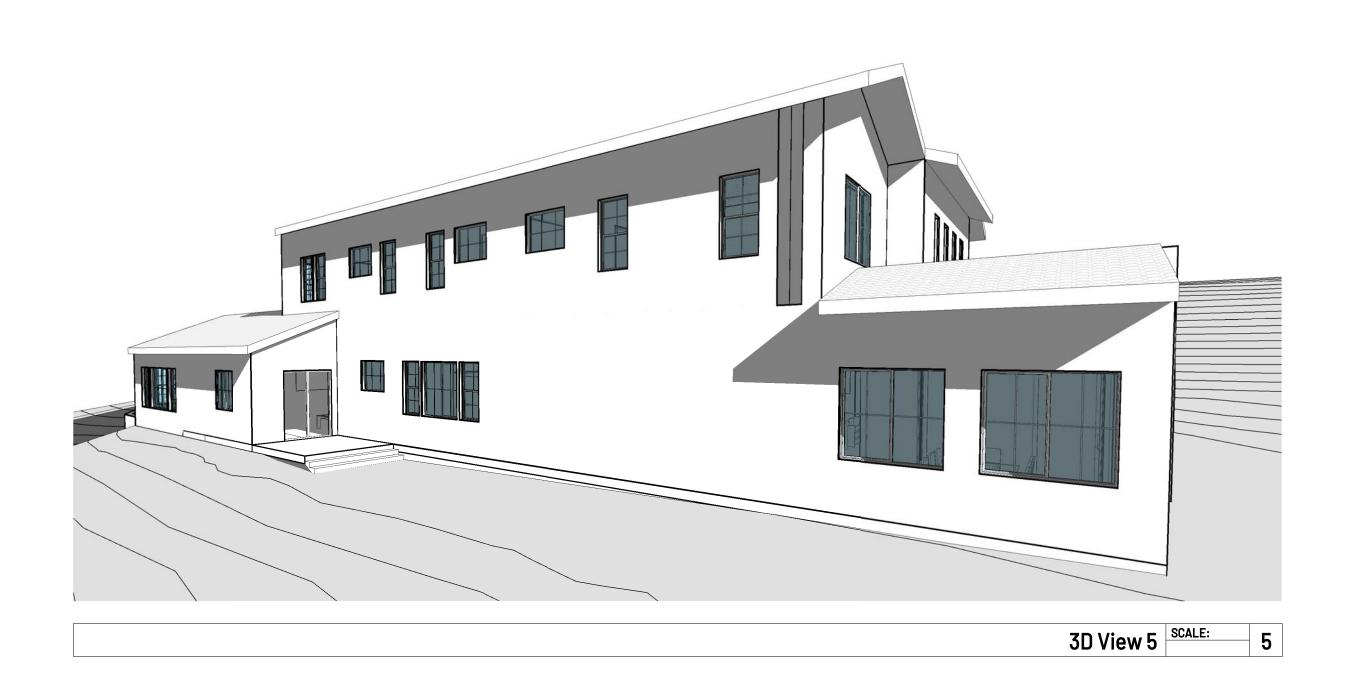





SCIA

CREATIVE STUDIO

4195 CHINO HILLS PKWY, SUITE 599 CHINO HILLS, CA 91709

CONTACT: KEYUR MARU 714.390.0525 KMARU@SAJNIDESIGN.COM

CLIENT

BARRY DADON

23939 PARK GRANADA, CALABASAS, CA 91302

TEL: 310.905.9943 EMAIL: BARRYDADON@GMAIL.COM

DDN IECT.

DADON RESIDENCE

23939 PARK GRANADA, CALABASAS, CA 91302

MARK	DESCRIPTION	DAT

STAM



THIS DRAWING IS THE PROPERTY OF **sda** AND IS NOT TO BE REPRODUCED IN WHOLE OR IN PART. IT IS TO BE USED FOR THE PROJECT AND SITE SPECIFICALLY IDENTIFIED HEREIN AND IS NOT TO BE USED ON ANY OTHER PROJECT. THIS DRAWING IS TO BE RETURNED UPON THE WRITTEN REQUEST OF **sda**.

© COPYRIGHT 2022 SAJNI DESIGN & ARCHITECTURE ALL RIGHTS RESERVED.

DRAWING DATA:	
PROJECT NO	220625
ISSUE DATE	04.01.2022
SCALE	
DRAWN BY	Author
SHEET SIZE	24" x 36"

IF SHEET IS LESS THAN SIZE INDICATED ABOVE, THIS IS A REDUCED PRINT. REDUCE SCALE ACCORDINGLY.

Sheet:

EXTERIOR 3D VIEWS














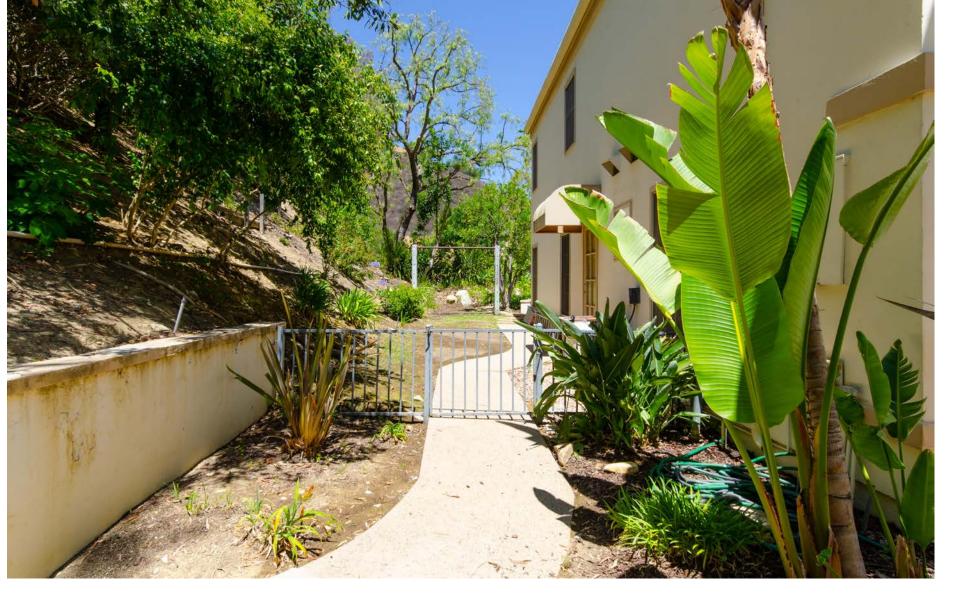

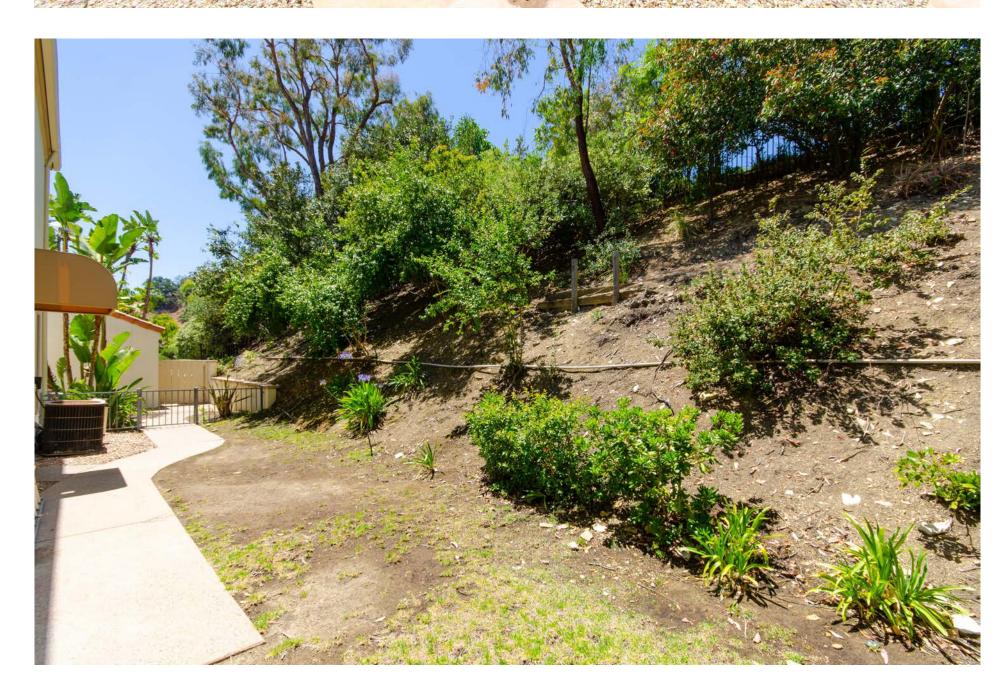

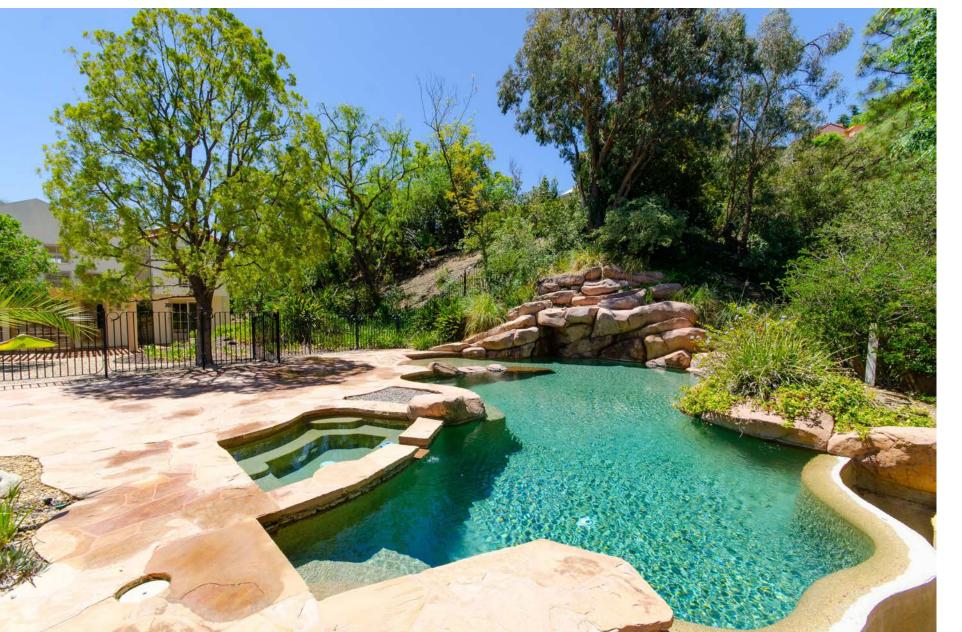



SCIA CREATIVE STUDIO

4195 CHINO HILLS PKWY, SUITE 599 CHINO HILLS, CA 91709

CONTACT: KEYUR MARU 714.390.0525 KMARU@SAJNIDESIGN.COM

CLIENT.

BARRY DADON

23939 PARK GRANADA, CALABASAS, CA 91302

TEL: 310.905.9943 EMAIL: BARRYDADON@GMAIL.COM

PROJECT:

DADON RESIDENCE

23939 PARK GRANADA, CALABASAS, CA 91302

MARK	DESCRIPTION	DATE
TIANK	BEGOINI HON	DAIL

STAM



THIS DRAWING IS THE PROPERTY OF **sda** AND IS NOT TO BE REPRODUCED IN WHOLE OR IN PART. IT IS TO BE USED FOR THE PROJECT AND SITE SPECIFICALLY IDENTIFIED HEREIN AND IS NOT TO BE USED ON ANY OTHER PROJECT. THIS DRAWING IS TO BE RETURNED UPON THE WRITTEN REQUEST OF **sda**.

© COPYRIGHT 2022 SAJNI DESIGN & ARCHITECTURE ALL RIGHTS RESERVED.

DRAWING DATA:

PROJECT NO	220625
ISSUE DATE	04.01.2022
SCALE	
DRAWN BY	Author
SHEET SIZE	24" x 36"
IF SHEET IS LESS THAN SIZE	INDICATED ABOVE, THIS IS A REDUCE

IF SHEET IS LESS THAN SIZE INDICATED ABOVE, THIS I PRINT. REDUCE SCALE ACCORDINGLY.

Sheet:

EXISTING IMAGES





4195 CHINO HILLS PKWY, SUITE 599 CHINO HILLS, CA 91709

CONTACT: KEYUR MARU 714.390.0525 KMARU@SAJNIDESIGN.COM

CLIENT

BARRY DADON

23939 PARK GRANADA, CALABASAS, CA 91302

TEL: 310.905.9943 EMAIL: BARRYDADON@GMAIL.COM

PROJEC

DADON RESIDENCE

23939 PARK GRANADA, CALABASAS, CA 91302

MARK	DESCRIPTION	DAT
HANK	DECOMI TION	DAT



THIS DRAWING IS THE PROPERTY OF **sda** AND IS NOT TO BE REPRODUCED IN WHOLE OR IN PART. IT IS TO BE USED FOR THE PROJECT AND SITE SPECIFICALLY IDENTIFIED HEREIN AND IS NOT TO BE USED ON ANY OTHER PROJECT. THIS DRAWING IS TO BE RETURNED UPON THE WRITTEN REQUEST OF **sda**.

© COPYRIGHT 2022 SAJNI DESIGN & ARCHITECTURE ALL RIGHTS RESERVED.


DRAWING DATA:

PROJECT NO	220625
ISSUE DATE	04.01.2022
SCALE	
DRAWN BY	Author
SHEET SIZE	24" x 36"

IF SHEET IS LESS THAN SIZE INDICATED ABOVE, THIS IS A REDUCED PRINT. REDUCE SCALE ACCORDINGLY.

Shee

SITE COMPARISON

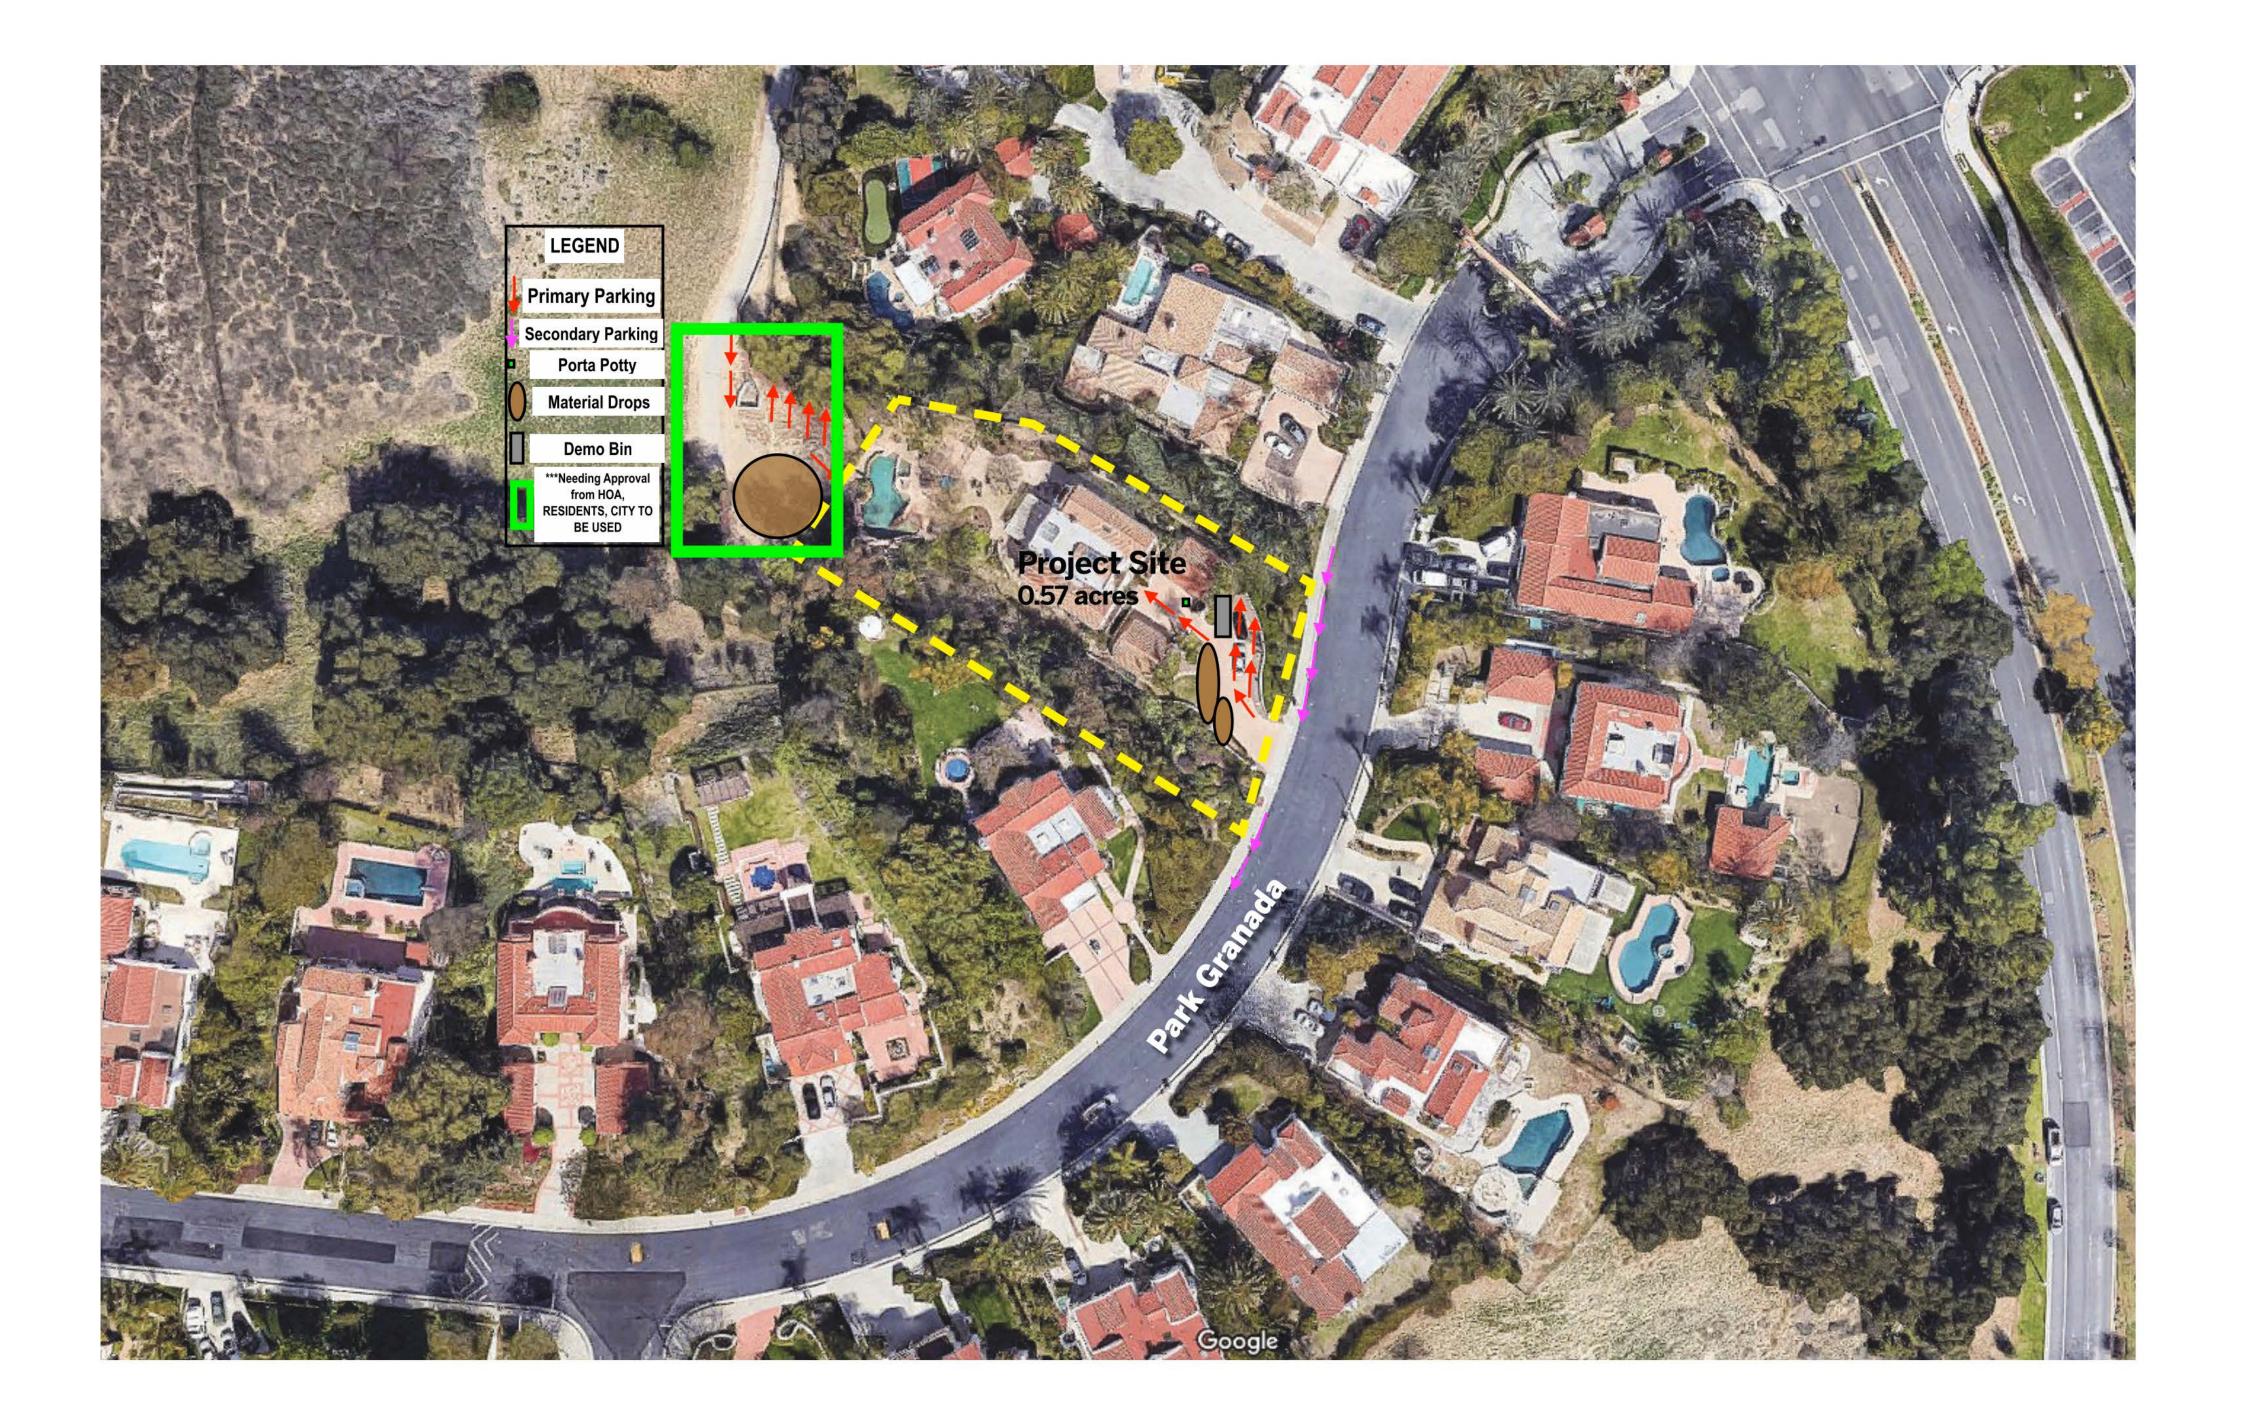

CONSTRUCTION AGREEMENT

9/27/2022

The following Construction Agreement (Agreement) between Westridge Homeowners Association (Westridge) and the Owners of the home located at 23939 Park Granada (Owners) is for the purpose of establishing a reasonable and mutually agreeable duration for the proposed remodel project at 23939 Park Granada and defining requirements that, during the construction process, will be implemented by the Owners to assure that a safe environment for the Westridge Community is maintained during construction. The location of 23939 Park Granada is unique in that almost every resident must drive past that house to enter or exit the community. The street is extraordinarily steep and curved at this location. The parties want to ensure utmost safety for both residents and construction workers.

The following, mutually agreed, conditions, will be implemented during the Construction

Schedule

- a. The duration of the project will be no more than 18 months from the date of mobilization on the project unless an extension of this period is necessary due to factors or issues which are beyond the control of Owners or Owners' contractor. In the event Owner believes that the 18month duration cannot be met, Owner shall submit a request to Westridge which specifies in detail the reasons why the 18-month time period cannot be met, provide supporting documentation for same as well as a revised CPM construction schedule depicting the extended schedule. Westridge shall not unreasonably withhold approval for an extension which is properly documented. (Mobilization is defined as the first date the Contractor has workers on the project site post city permit approval.)
- b. Owners to provide to Westridge, through their Contractor, a milestone schedule of activities to be met to assure completion of the project within the 18 month or shorter duration.

2. Conditions to be maintained during Construction:

a. When the number of vehicles parking on the street, Infront of the site, exceeds 6, the Owners will assure that their contractor has their additional workers park at an offsite location to avoid congestion on the steep grade of Park Granada in front of the project. If the rear of the property can be used for vehicle parking, the owners will utilize that area when permitted

as the primary parking area if approved by the city and supported by

- b. Dumpsters must always be kept in the driveway and never in the street
- c. No material for the project may be stored on the street or sidewalk or on Common Area.
- d. The Owners must assure that their contractor is prepared to provide traffic control when trucks, larger than 30 ft, are entering or exiting from the site onto Park Granada.
- e. The Owners must assure that their contractor and subcontractors maintain adequate property damage and liability insurance, in case of accidents caused by trucks entering or leaving the site. Westridge must be named as an additional insured under these policies and a copy of the policies provided to Westridge before construction begins.
- f. Porta-toilets for the workers will be placed on the project site out of view of passing motorists.
- g. The Owners shall accompany Westridge on a site visit, when requested, to observe that progress is being maintained in accordance with the plans & schedule provided. Each of these site visits must be approved by the owners and are at the owner's discretion as this request is outside the CCR's.

Failure to Comply

Westridge will follow these steps if there is a Failure to Comply on how it will communicate with the owner.

- 1. Text or email the owner if there is an issue
- 2. Will call the owners phone if issue still not resolved in a reasonable amount of
- 3. Request the Owner inform them in writing via email what has been done to resolve the issue
- 4. Will give you a certain number of warnings
- 5. A fine is imposed if the issue remains unresolved after 72 hours if it is correctable within that period or if the same issue occurs over and over and over without substantial effort on your part to ensure compliance

CREATIVE STUDIO

4195 CHINO HILLS PKWY, SUITE 599 CHINO HILLS, CA 91709

CONTACT: KEYUR MARU KMARU@SAJNIDESIGN.COM

CLIENT:

BARRY DADON

23939 PARK GRANADA, CALABASAS, CA 91302

TEL: 310.905.9943 EMAIL: BARRYDADON@GMAIL.COM

PROJECT:

DADON RESIDENCE

23939 PARK GRANADA, CALABASAS, CA 91302

MARK	DESCRIPTION	DATE
TIANK	BEGOINI HON	DAIL




REPRODUCED IN WHOLE OR IN PART. IT IS TO BE USED FOR THE PROJECT AND SITE SPECIFICALLY IDENTIFIED HEREIN AND IS NOT TO BE USED ON ANY OTHER PROJECT. THIS DRAWING IS TO BE RETURNED UPON THE WRITTEN REQUEST OF **sda**. © COPYRIGHT 2022 SAJNI DESIGN & ARCHITECTURE ALL RIGHTS RESERVED.

DRAWING DATA:	
PROJECT NO	220625
ISSUE DATE	04.01.2022
SCALE	
DDAWN BV	Author

IF SHEET IS LESS THAN SIZE INDICATED ABOVE, THIS IS A REDUCED PRINT. REDUCE SCALE ACCORDINGLY

SHEET SIZE

CONSTRUCTION LOGISTICS

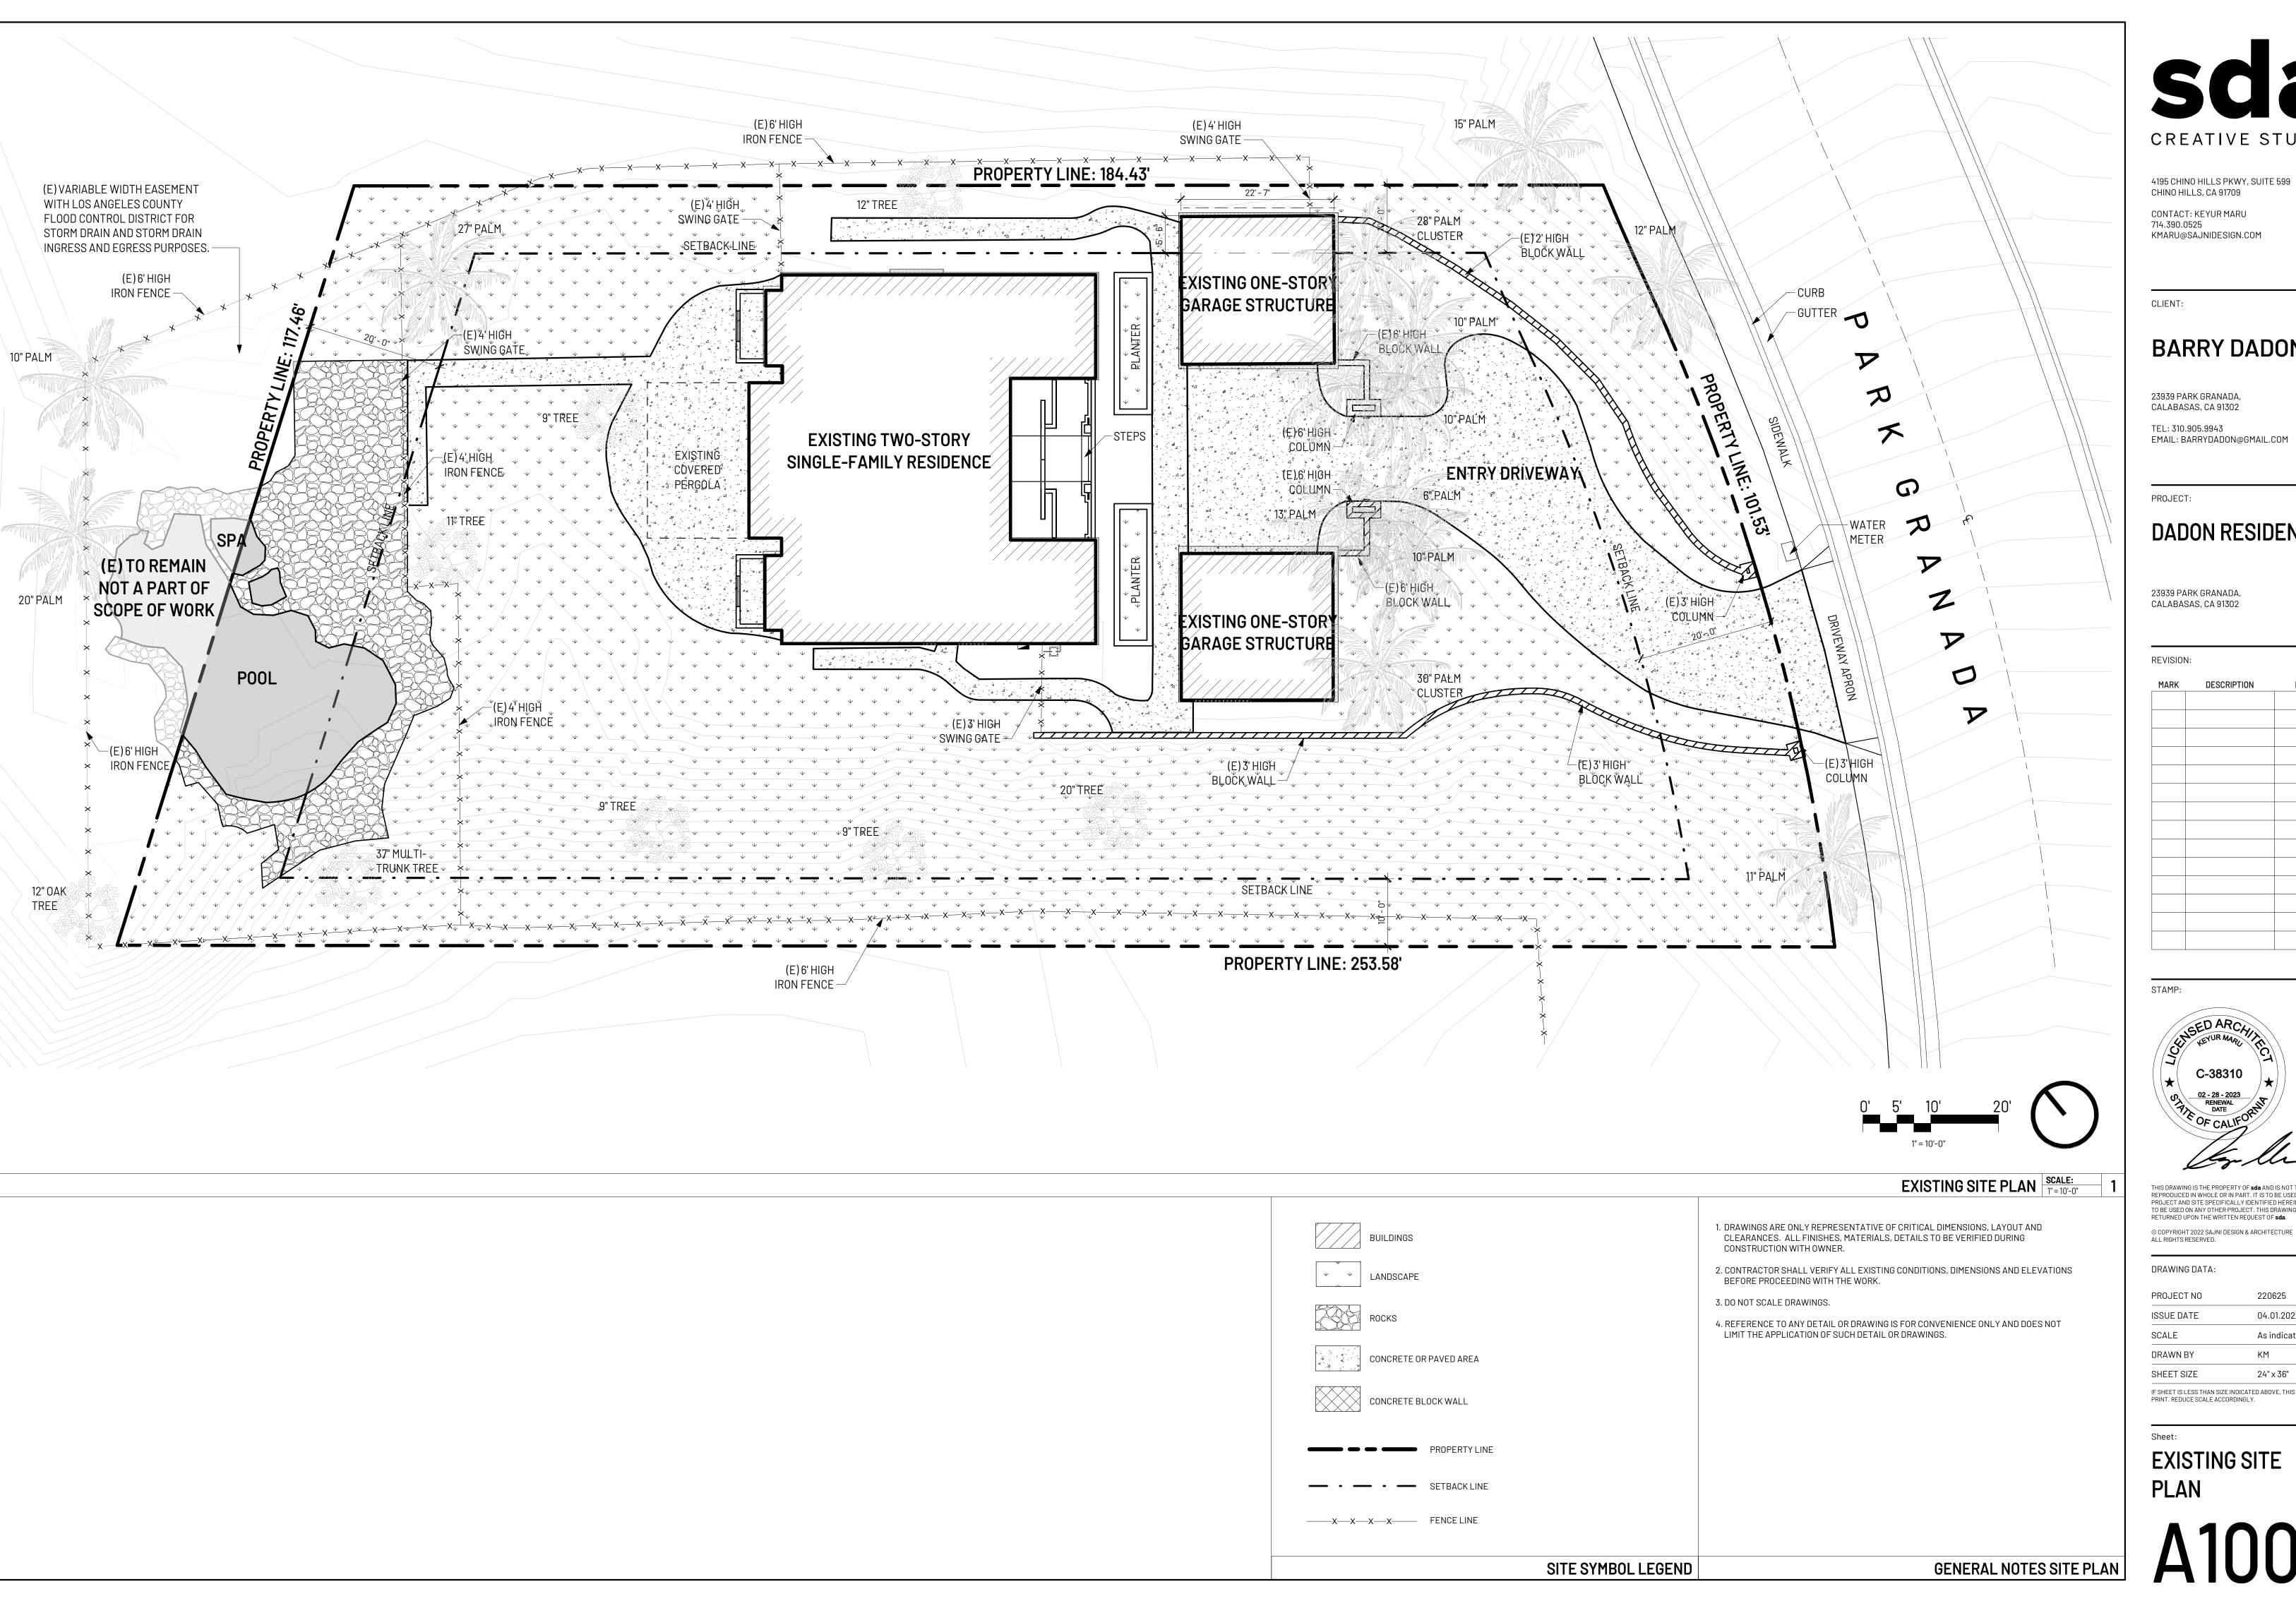

4195 CHINO HILLS PKWY, SUITE 599 CHINO HILLS, CA 91709

CONTACT: KEYUR MARU 714.390.0525 KMARU@SAJNIDESIGN.COM

CLIENT:

BARRY DADON

23939 PARK GRANADA, CALABASAS, CA 91302

TEL: 310.905.9943 EMAIL: BARRYDADON@GMAIL.COM

DADON RESIDENCE

23939 PARK GRANADA, CALABASAS, CA 91302

MARK	DESCRIPTION	DAT




REPRODUCED IN WHOLE OR IN PART. IT IS TO BE USED FOR THE PROJECT AND SITE SPECIFICALLY IDENTIFIED HEREIN AND IS NOT TO BE USED ON ANY OTHER PROJECT. THIS DRAWING IS TO BE RETURNED UPON THE WRITTEN REQUEST OF **sda**.

DRAWING DATA:	
---------------	--

PROJECT NO	220625
ISSUE DATE	04.01.2022
SCALE	As indicated
DRAWN BY	KM
SHEET SIZE	24" x 36"

IF SHEET IS LESS THAN SIZE INDICATED ABOVE, THIS IS A REDUCED PRINT. REDUCE SCALE ACCORDINGLY.

EXISTING SITE PLAN

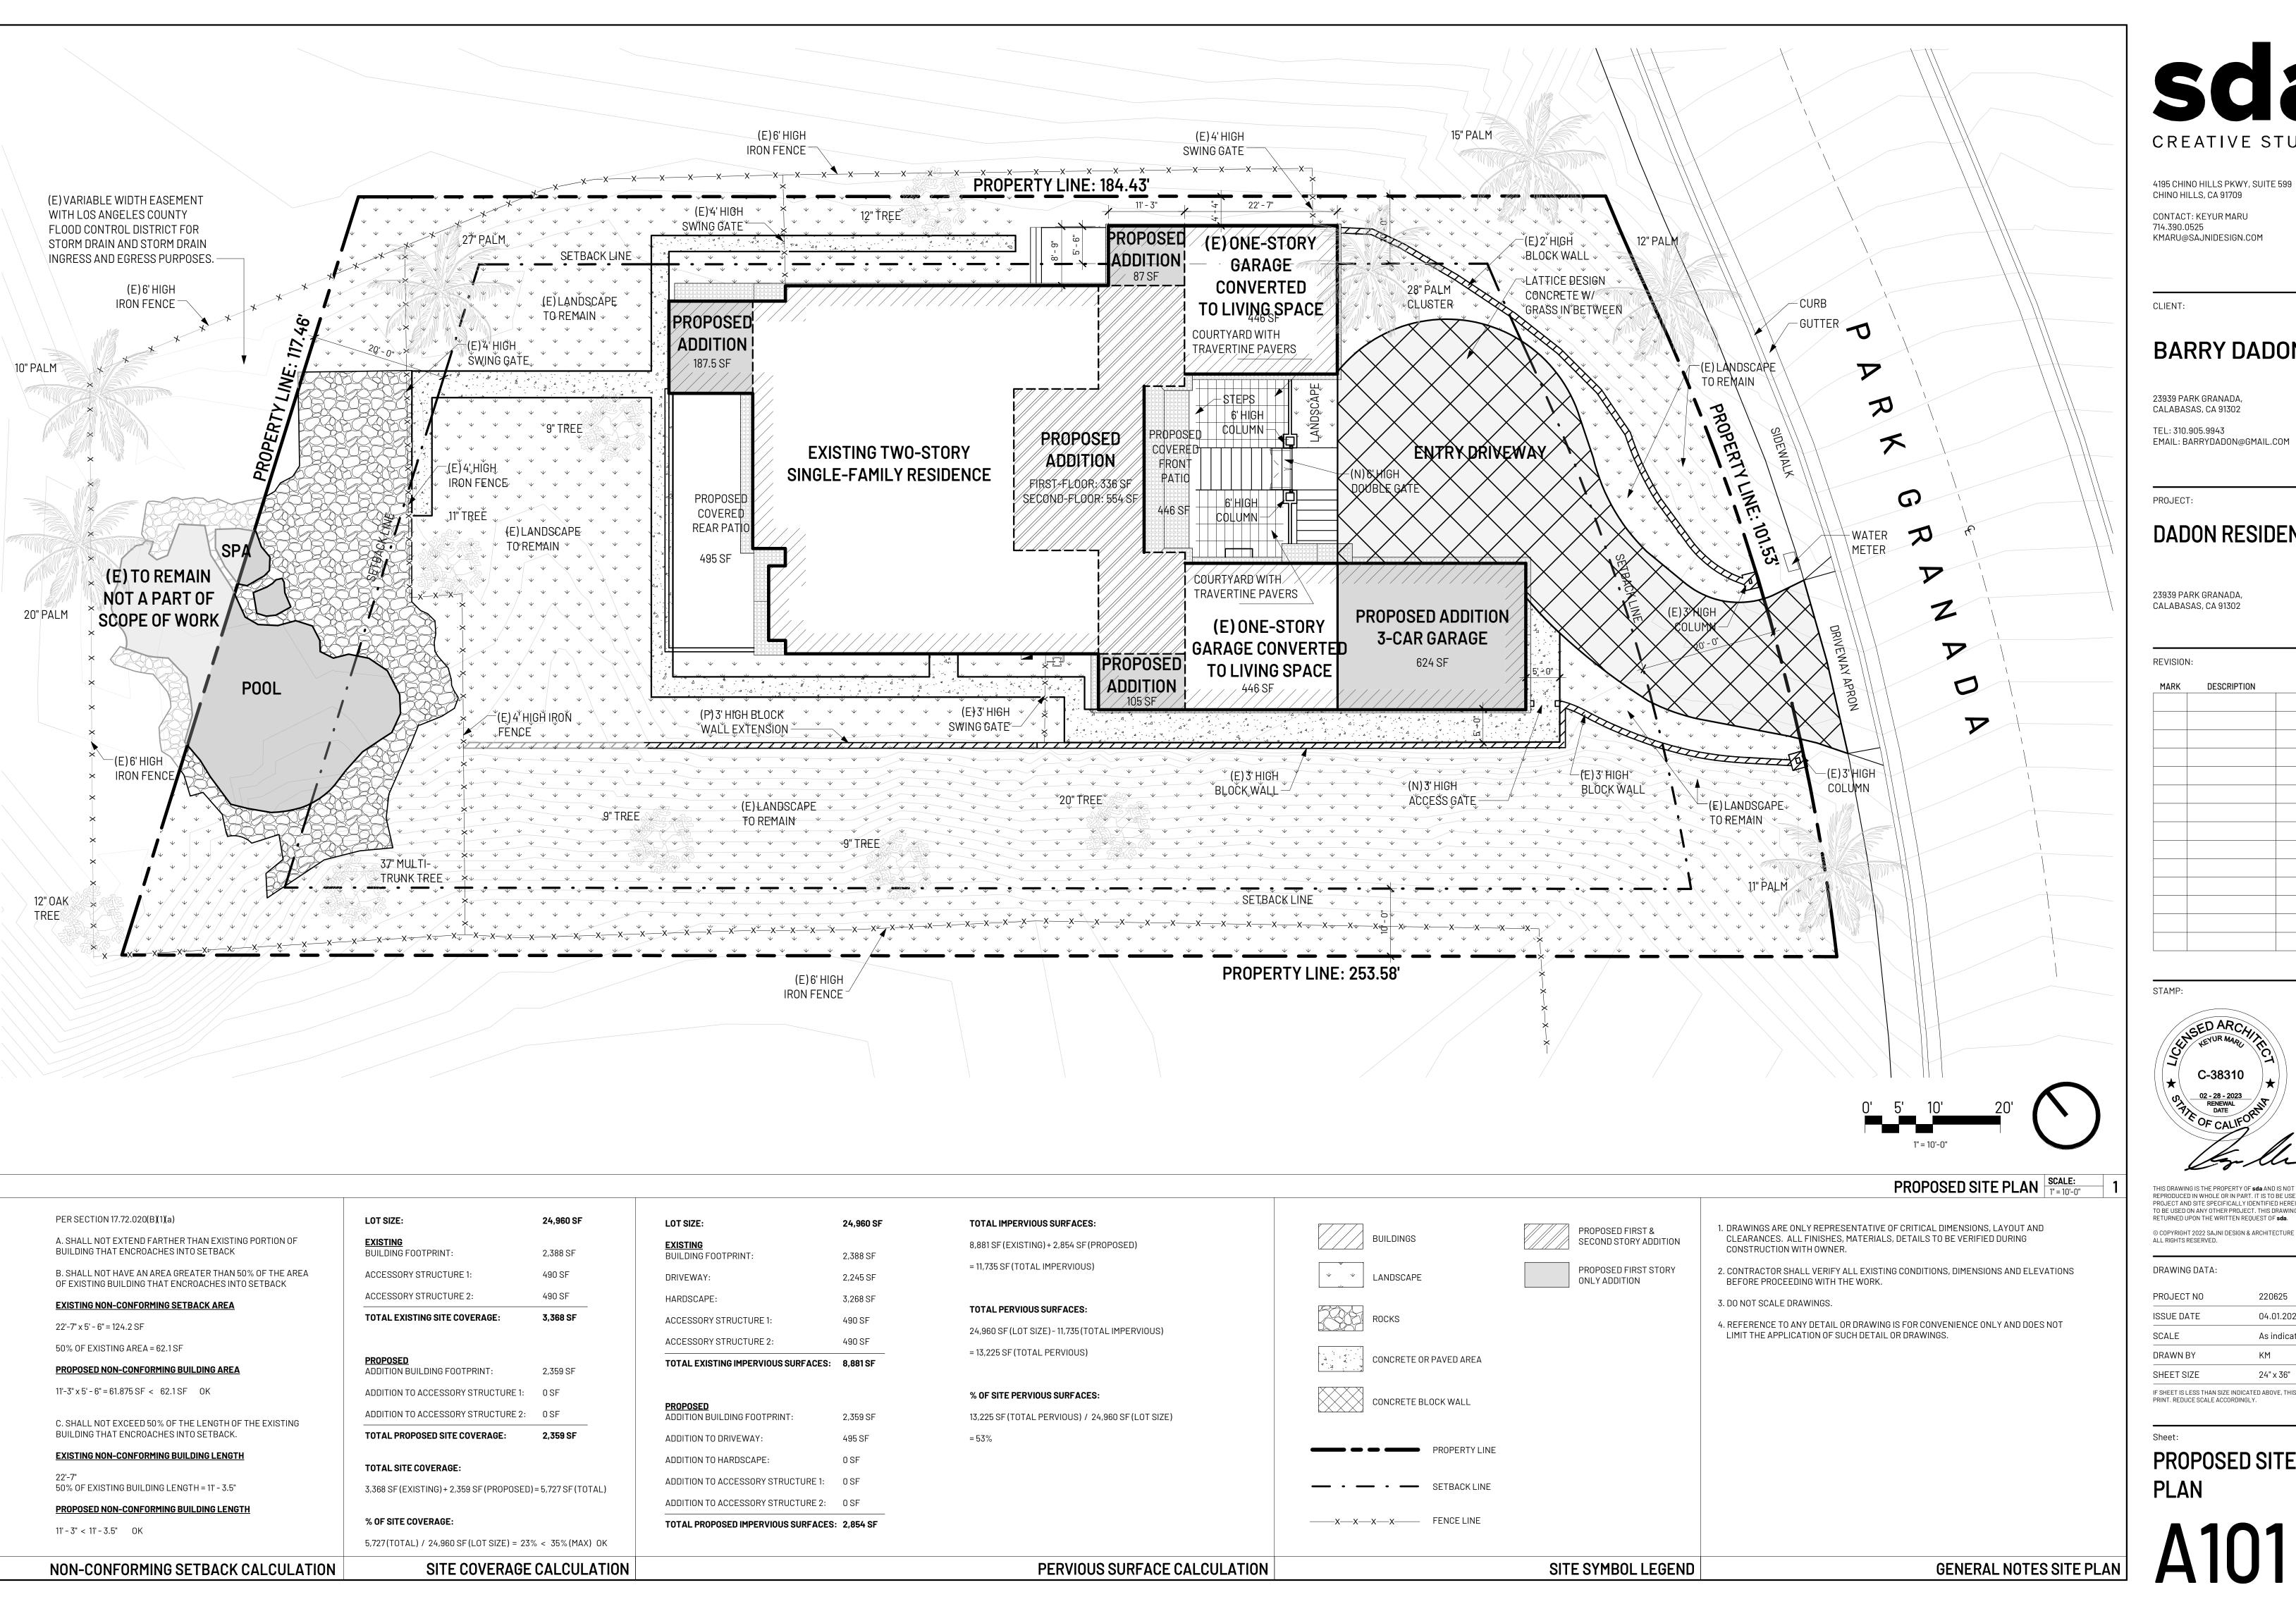

4195 CHINO HILLS PKWY, SUITE 599 CHINO HILLS, CA 91709

CONTACT: KEYUR MARU KMARU@SAJNIDESIGN.COM

BARRY DADON

23939 PARK GRANADA, CALABASAS, CA 91302

TEL: 310.905.9943 EMAIL: BARRYDADON@GMAIL.COM

DADON RESIDENCE

23939 PARK GRANADA, CALABASAS, CA 91302

REVISION: MARK DESCRIPTION




REPRODUCED IN WHOLE OR IN PART. IT IS TO BE USED FOR THE PROJECT AND SITE SPECIFICALLY IDENTIFIED HEREIN AND IS NOT RETURNED UPON THE WRITTEN REQUEST OF **sda**.

DRAWING DATA:	
PROJECT NO	2206
ISSUE DATE	04.0

PROJECT NO	220625
ISSUE DATE	04.01.2022
SCALE	As indicated
DRAWN BY	KM
SHEET SIZE	24" x 36"
	ATER AROUE THIS IS A REPUISER

IF SHEET IS LESS THAN SIZE INDICATED ABOVE, THIS IS A REDUCED PRINT. REDUCE SCALE ACCORDINGLY.

PROPOSED SITE **PLAN**

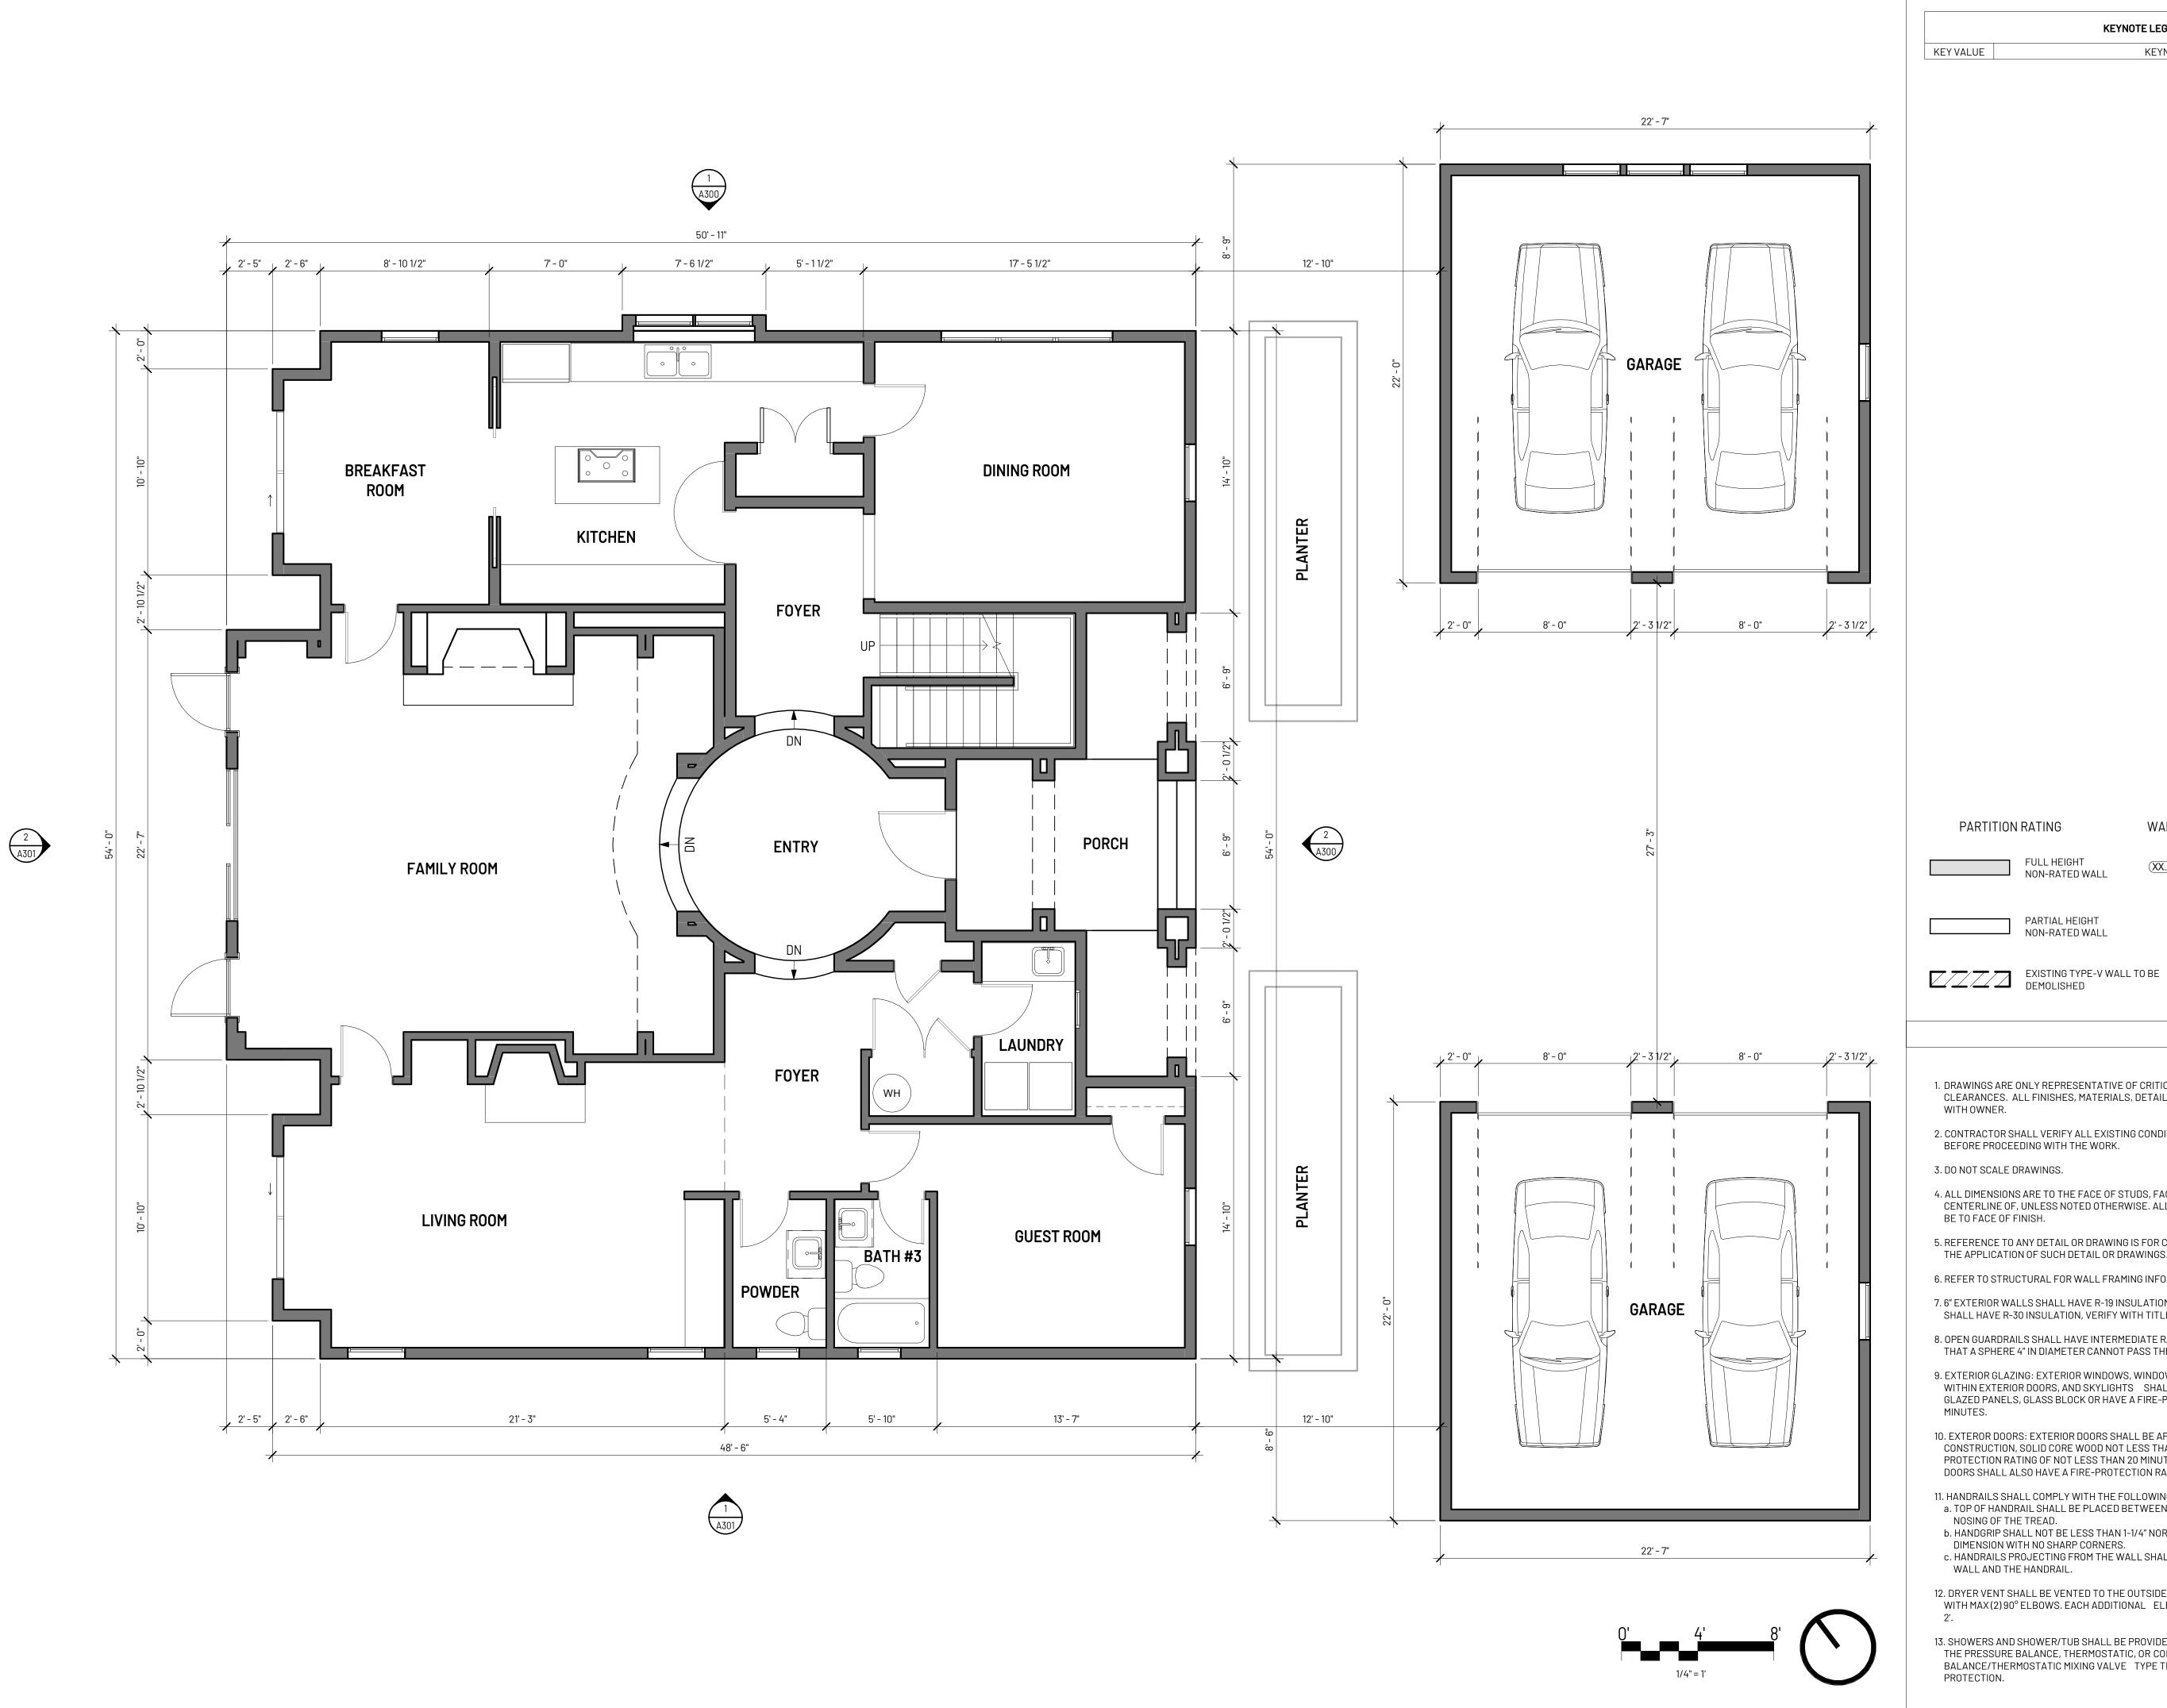

KEYNOTE LEGEND

KEYNOTE TEXT

BARRY DADON

CREATIVE STUDIO

4195 CHINO HILLS PKWY, SUITE 599

CHINO HILLS, CA 91709

CONTACT: KEYUR MARU

KMARU@SAJNIDESIGN.COM

23939 PARK GRANADA, CALABASAS, CA 91302

TEL: 310.905.9943 EMAIL: BARRYDADON@GMAIL.COM

PROJECT:

DADON RESIDENCE

23939 PARK GRANADA, CALABASAS, CA 91302

REVISION: DESCRIPTION

WALL LEGEND

STAMP:

SCALE

1. DRAWINGS ARE ONLY REPRESENTATIVE OF CRITICAL DIMENSIONS, LAYOUT AND CLEARANCES. ALL FINISHES, MATERIALS, DETAILS TO BE VERIFIED DURING CONSTRUCTION

WALL ASSEMBLY LEGEND

(XX.X) WALL ASSEMBLY TYPE

SEE SHEET A801 FOR

INTERIOR & EXTERIOR ASSEMBLY DETAIL

- 2. CONTRACTOR SHALL VERIFY ALL EXISTING CONDITIONS, DIMENSIONS AND ELEVATIONS BEFORE PROCEEDING WITH THE WORK.
- 3. DO NOT SCALE DRAWINGS.

EXISTING FIRST LEVEL PLAN SCALE: 1/4" = 1'-0" 1

FULL HEIGHT

NON-RATED WALL

PARTIAL HEIGHT NON-RATED WALL

- 4. ALL DIMENSIONS ARE TO THE FACE OF STUDS, FACE OF CONCRETE OR MASONRY, AND CENTERLINE OF, UNLESS NOTED OTHERWISE. ALL DIMENSIONS NOTED AS "CLEAR" SHALL BE TO FACE OF FINISH.
- 5. REFERENCE TO ANY DETAIL OR DRAWING IS FOR CONVENIENCE ONLY AND DOES NOT LIMIT THE APPLICATION OF SUCH DETAIL OR DRAWINGS.
- 6. REFER TO STRUCTURAL FOR WALL FRAMING INFORMATION, U.N.O.
- 7. 6" EXTERIOR WALLS SHALL HAVE R-19 INSULATION (4" WALLS SHALL HAVE R-13). ROOFS SHALL HAVE R-30 INSULATION, VERIFY WITH TITLE 24 REPORT.
- 8. OPEN GUARDRAILS SHALL HAVE INTERMEDIATE RAILS, OR AN ORNAMENTAL PATTERN SUCH THAT A SPHERE 4" IN DIAMETER CANNOT PASS THROUGH.
- 9. EXTERIOR GLAZING: EXTERIOR WINDOWS, WINDOW WALLS AND GLAZED DOORS, WINDOWS WITHIN EXTERIOR DOORS, AND SKYLIGHTS SHALL BE TEMPERED GLASS, MULTI LAYERED GLAZED PANELS, GLASS BLOCK OR HAVE A FIRE-PROTECTION RATING OF NOT LESS THAN 20
- 10. EXTEROR DOORS: EXTERIOR DOORS SHALL BE APPROVED NON-COMBUSTIBLE CONSTRUCTION, SOLID CORE WOOD NOT LESS THAN 1-3/4" THICK, OR HAVE A FIRE PROTECTION RATING OF NOT LESS THAN 20 MINUTES. WINDOWS WITHIN DOORS AND GLAZED DOORS SHALL ALSO HAVE A FIRE-PROTECTION RATING OF NOT LESS THAN 20 MINUTES.
- 11. HANDRAILS SHALL COMPLY WITH THE FOLLOWING: a. TOP OF HANDRAIL SHALL BE PLACED BETWEEN 34" & 38" ABOVE LANDINGS AND THE
- NOSING OF THE TREAD. b. HANDGRIP SHALL NOT BE LESS THAN 1-1/4" NOR MORE THAN 2" IN CROSS-SECTIONAL
- DIMENSION WITH NO SHARP CORNERS.
- c. HANDRAILS PROJECTING FROM THE WALL SHALL NOT HAVE LESS THAN 1-1/2" BETWEEN WALL AND THE HANDRAIL.
- 12. DRYER VENT SHALL BE VENTED TO THE OUTSIDE AND SHALL NOT EXCEED 14' DISTANCE WITH MAX (2) 90° ELBOWS. EACH ADDITIONAL ELBOW SHALL REDUCE THE MAX LENGTH BY
- 13. SHOWERS AND SHOWER/TUB SHALL BE PROVIDED WITH INDIVIDUAL CONTROL VALVES OF THE PRESSURE BALANCE, THERMOSTATIC, OR COMBINATION PRESSURE BALANCE/THERMOSTATIC MIXING VALVE TYPE THAT PROVIDE SCALD AND THERMAL SHOCK


REPRODUCED IN WHOLE OR IN PART. IT IS TO BE USED FOR THE PROJECT AND SITE SPECIFICALLY IDENTIFIED HEREIN AND IS NOT TO BE USED ON ANY OTHER PROJECT. THIS DRAWING IS TO BE RETURNED UPON THE WRITTEN REQUEST OF sda. © COPYRIGHT 2022 SAJNI DESIGN & ARCHITECTURE ALL RIGHTS RESERVED. DRAWING DATA: PROJECT NO 220625 ISSUE DATE 04.01.2022

As indicated

DRAWN BY Author SHEET SIZE 24" x 36" IF SHEET IS LESS THAN SIZE INDICATED ABOVE, THIS IS A REDUCED PRINT. REDUCE SCALE ACCORDINGLY.

EXISTING FIRST

LEVEL PLAN

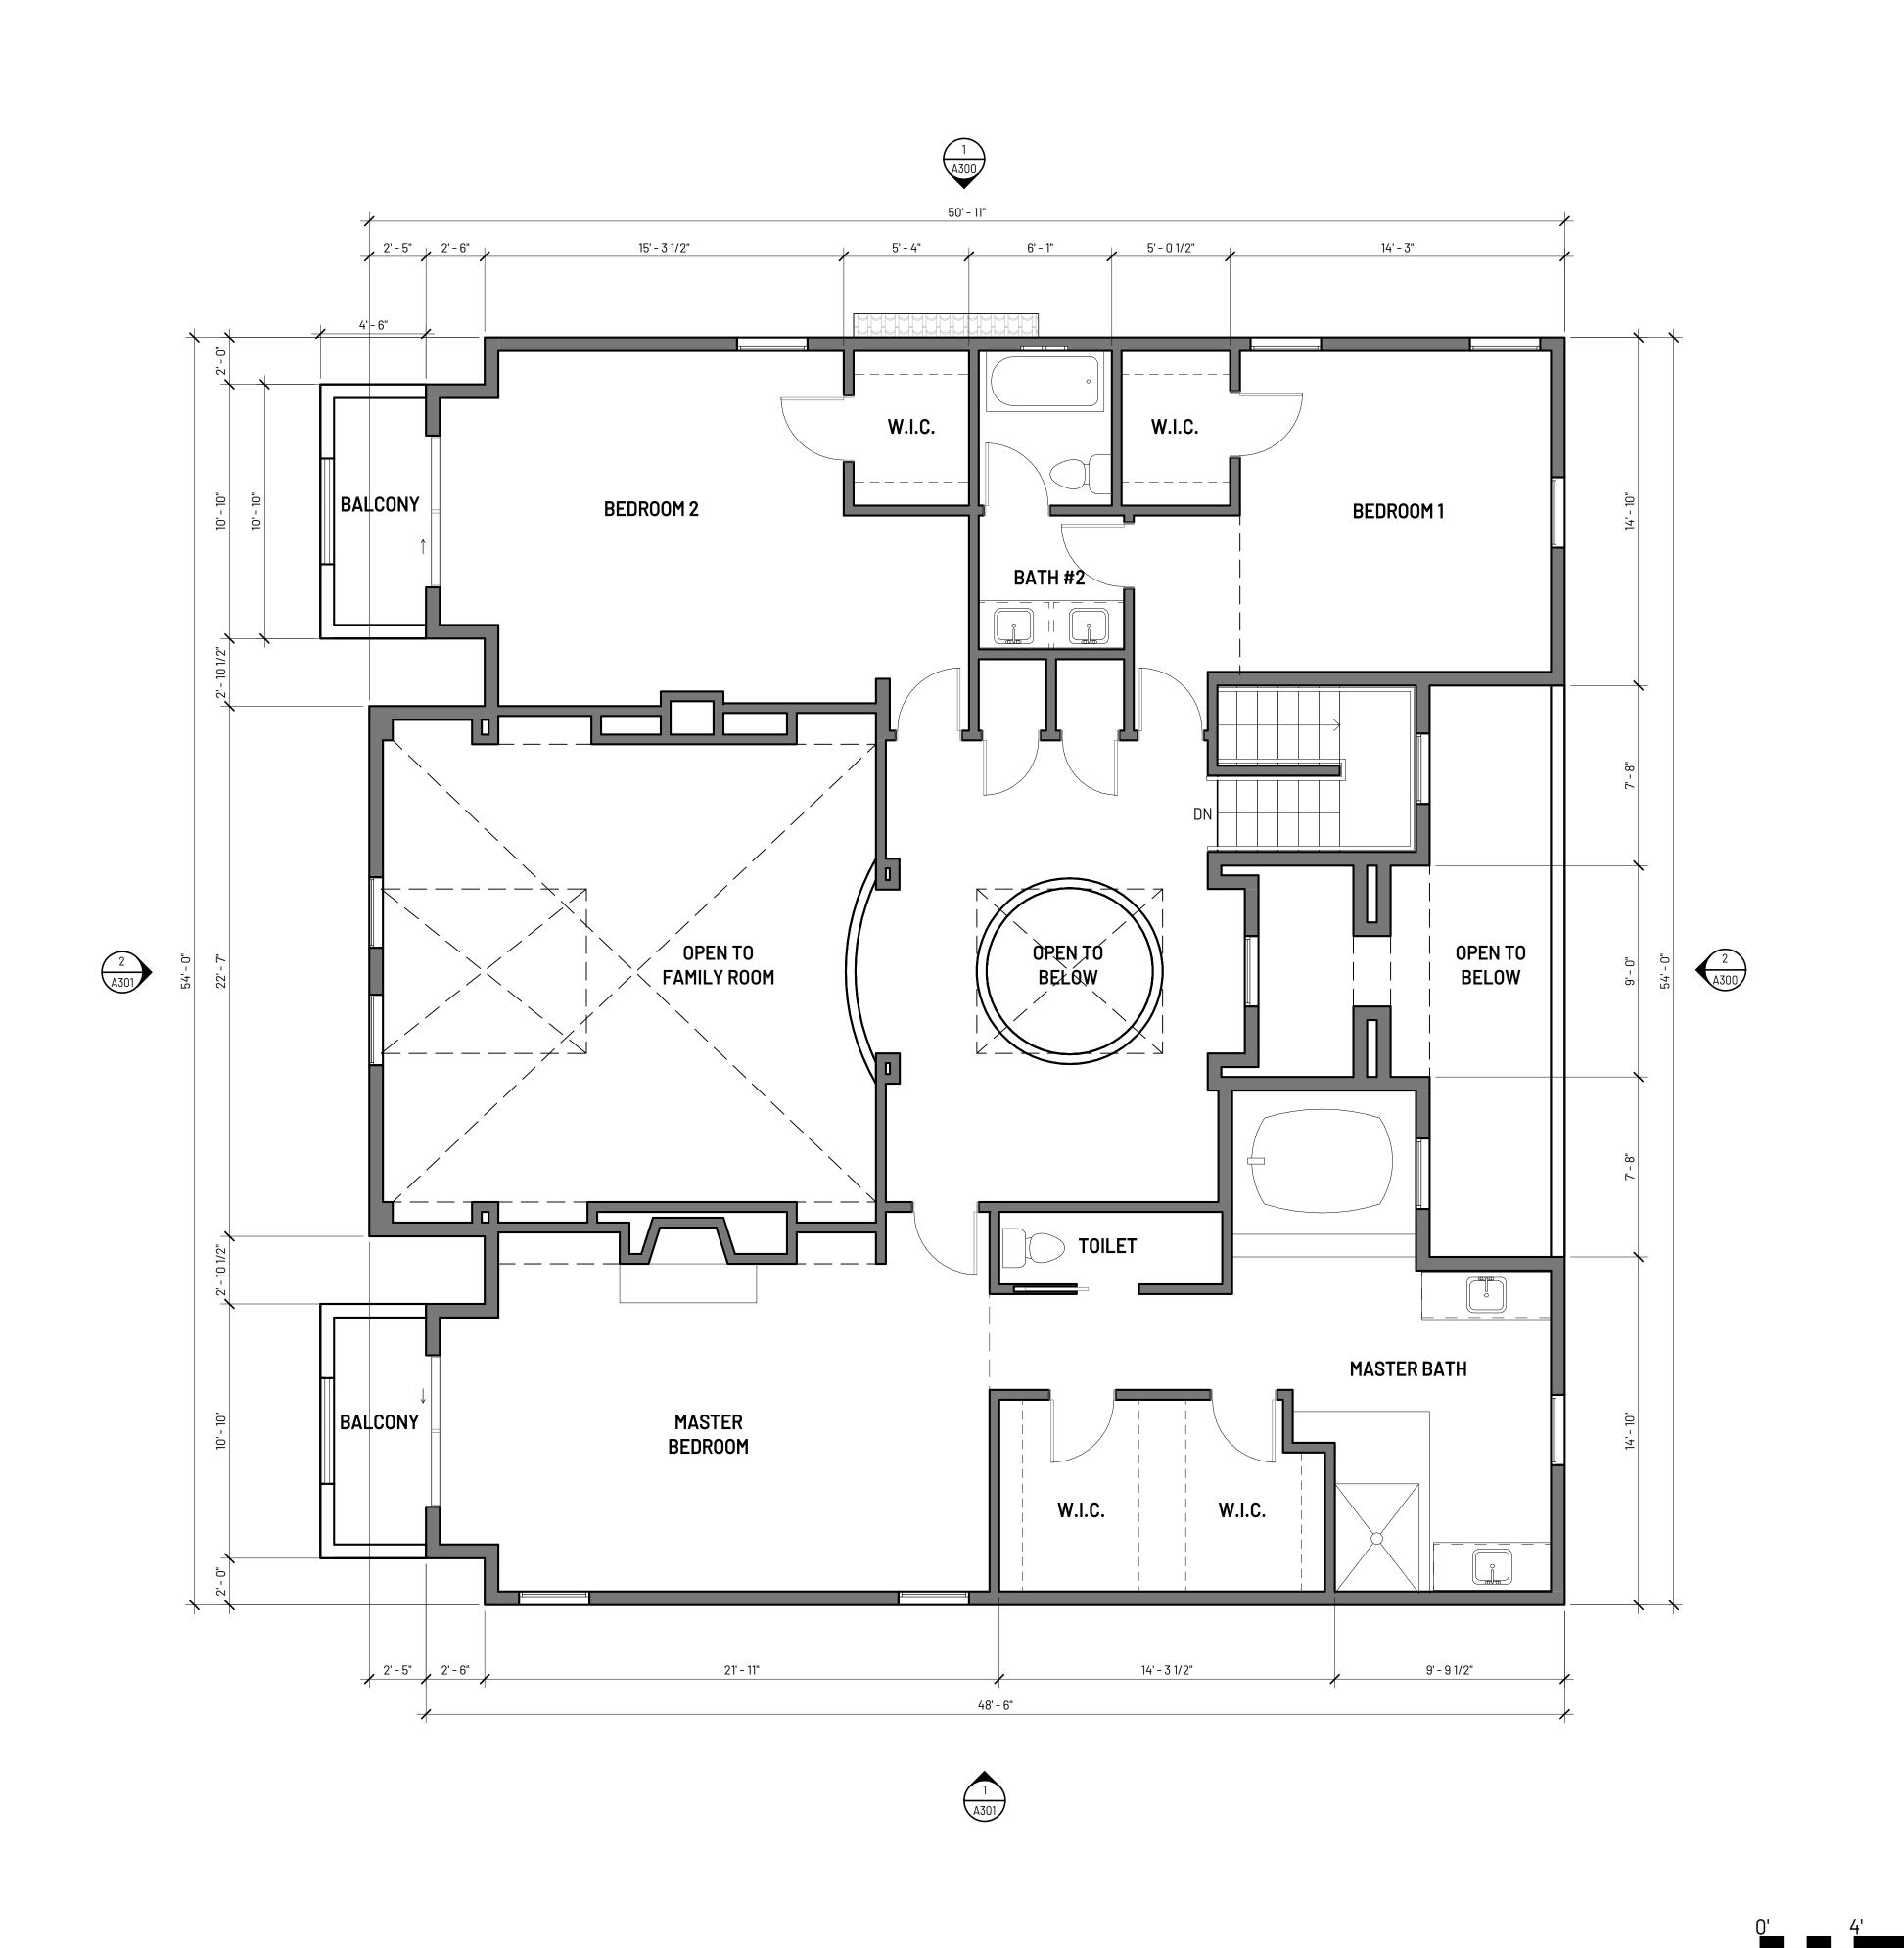



4195 CHINO HILLS PKWY, SUITE 599 CHINO HILLS, CA 91709

CONTACT: KEYUR MARU KMARU@SAJNIDESIGN.COM

BARRY DADON

23939 PARK GRANADA, CALABASAS, CA 91302

TEL: 310.905.9943 EMAIL: BARRYDADON@GMAIL.COM

PROJECT:

DADON RESIDENCE

23939 PARK GRANADA, CALABASAS, CA 91302

REVISION: MARK DESCRIPTION

WALL LEGEND

1. DRAWINGS ARE ONLY REPRESENTATIVE OF CRITICAL DIMENSIONS, LAYOUT AND CLEARANCES. ALL FINISHES, MATERIALS, DETAILS TO BE VERIFIED DURING CONSTRUCTION

WALL ASSEMBLY LEGEND

(XX.X) WALL ASSEMBLY TYPE

SEE SHEET A801 FOR

INTERIOR & EXTERIOR ASSEMBLY DETAIL

- 2. CONTRACTOR SHALL VERIFY ALL EXISTING CONDITIONS, DIMENSIONS AND ELEVATIONS BEFORE PROCEEDING WITH THE WORK.
- 3. DO NOT SCALE DRAWINGS.

PARTITION RATING

FULL HEIGHT

NON-RATED WALL

PARTIAL HEIGHT NON-RATED WALL

EXISTING TYPE-V WALL TO BE DEMOLISHED

- 4. ALL DIMENSIONS ARE TO THE FACE OF STUDS, FACE OF CONCRETE OR MASONRY, AND CENTERLINE OF, UNLESS NOTED OTHERWISE. ALL DIMENSIONS NOTED AS "CLEAR" SHALL BE TO FACE OF FINISH.
- 5. REFERENCE TO ANY DETAIL OR DRAWING IS FOR CONVENIENCE ONLY AND DOES NOT LIMIT THE APPLICATION OF SUCH DETAIL OR DRAWINGS.
- 6. REFER TO STRUCTURAL FOR WALL FRAMING INFORMATION, U.N.O.
- 7. 6" EXTERIOR WALLS SHALL HAVE R-19 INSULATION (4" WALLS SHALL HAVE R-13). ROOFS SHALL HAVE R-30 INSULATION, VERIFY WITH TITLE 24 REPORT.
- 8. OPEN GUARDRAILS SHALL HAVE INTERMEDIATE RAILS, OR AN ORNAMENTAL PATTERN SUCH THAT A SPHERE 4" IN DIAMETER CANNOT PASS THROUGH.
- 9. EXTERIOR GLAZING: EXTERIOR WINDOWS, WINDOW WALLS AND GLAZED DOORS, WINDOWS WITHIN EXTERIOR DOORS, AND SKYLIGHTS SHALL BE TEMPERED GLASS, MULTI LAYERED GLAZED PANELS, GLASS BLOCK OR HAVE A FIRE-PROTECTION RATING OF NOT LESS THAN 20
- 10. EXTEROR DOORS: EXTERIOR DOORS SHALL BE APPROVED NON-COMBUSTIBLE CONSTRUCTION, SOLID CORE WOOD NOT LESS THAN 1-3/4" THICK, OR HAVE A FIRE PROTECTION RATING OF NOT LESS THAN 20 MINUTES. WINDOWS WITHIN DOORS AND GLAZED DOORS SHALL ALSO HAVE A FIRE-PROTECTION RATING OF NOT LESS THAN 20 MINUTES.
- 11. HANDRAILS SHALL COMPLY WITH THE FOLLOWING: a. TOP OF HANDRAIL SHALL BE PLACED BETWEEN 34" & 38" ABOVE LANDINGS AND THE
- NOSING OF THE TREAD. b. HANDGRIP SHALL NOT BE LESS THAN 1-1/4" NOR MORE THAN 2" IN CROSS-SECTIONAL
- DIMENSION WITH NO SHARP CORNERS. c. HANDRAILS PROJECTING FROM THE WALL SHALL NOT HAVE LESS THAN 1-1/2" BETWEEN WALL AND THE HANDRAIL.
- 12. DRYER VENT SHALL BE VENTED TO THE OUTSIDE AND SHALL NOT EXCEED 14' DISTANCE WITH MAX (2) 90° ELBOWS. EACH ADDITIONAL ELBOW SHALL REDUCE THE MAX LENGTH BY
- 13. SHOWERS AND SHOWER/TUB SHALL BE PROVIDED WITH INDIVIDUAL CONTROL VALVES OF THE PRESSURE BALANCE, THERMOSTATIC, OR COMBINATION PRESSURE BALANCE/THERMOSTATIC MIXING VALVE TYPE THAT PROVIDE SCALD AND THERMAL SHOCK

STAMP:

EXISTING SECOND LEVEL PLAN

REPRODUCED IN WHOLE OR IN PART. IT IS TO BE USED FOR THE PROJECT AND SITE SPECIFICALLY IDENTIFIED HEREIN AND IS NOT

220625

04.01.2022

As indicated

Author

24" x 36"

IF SHEET IS LESS THAN SIZE INDICATED ABOVE, THIS IS A REDUCED

TO BE USED ON ANY OTHER PROJECT. THIS DRAWING IS TO BE

RETURNED UPON THE WRITTEN REQUEST OF sda.

© COPYRIGHT 2022 SAJNI DESIGN & ARCHITECTURE ALL RIGHTS RESERVED.

DRAWING DATA:

PROJECT NO

ISSUE DATE


SCALE

DRAWN BY

SHEET SIZE

PRINT. REDUCE SCALE ACCORDINGLY.

GENERAL NOTES FLOOR PLAN

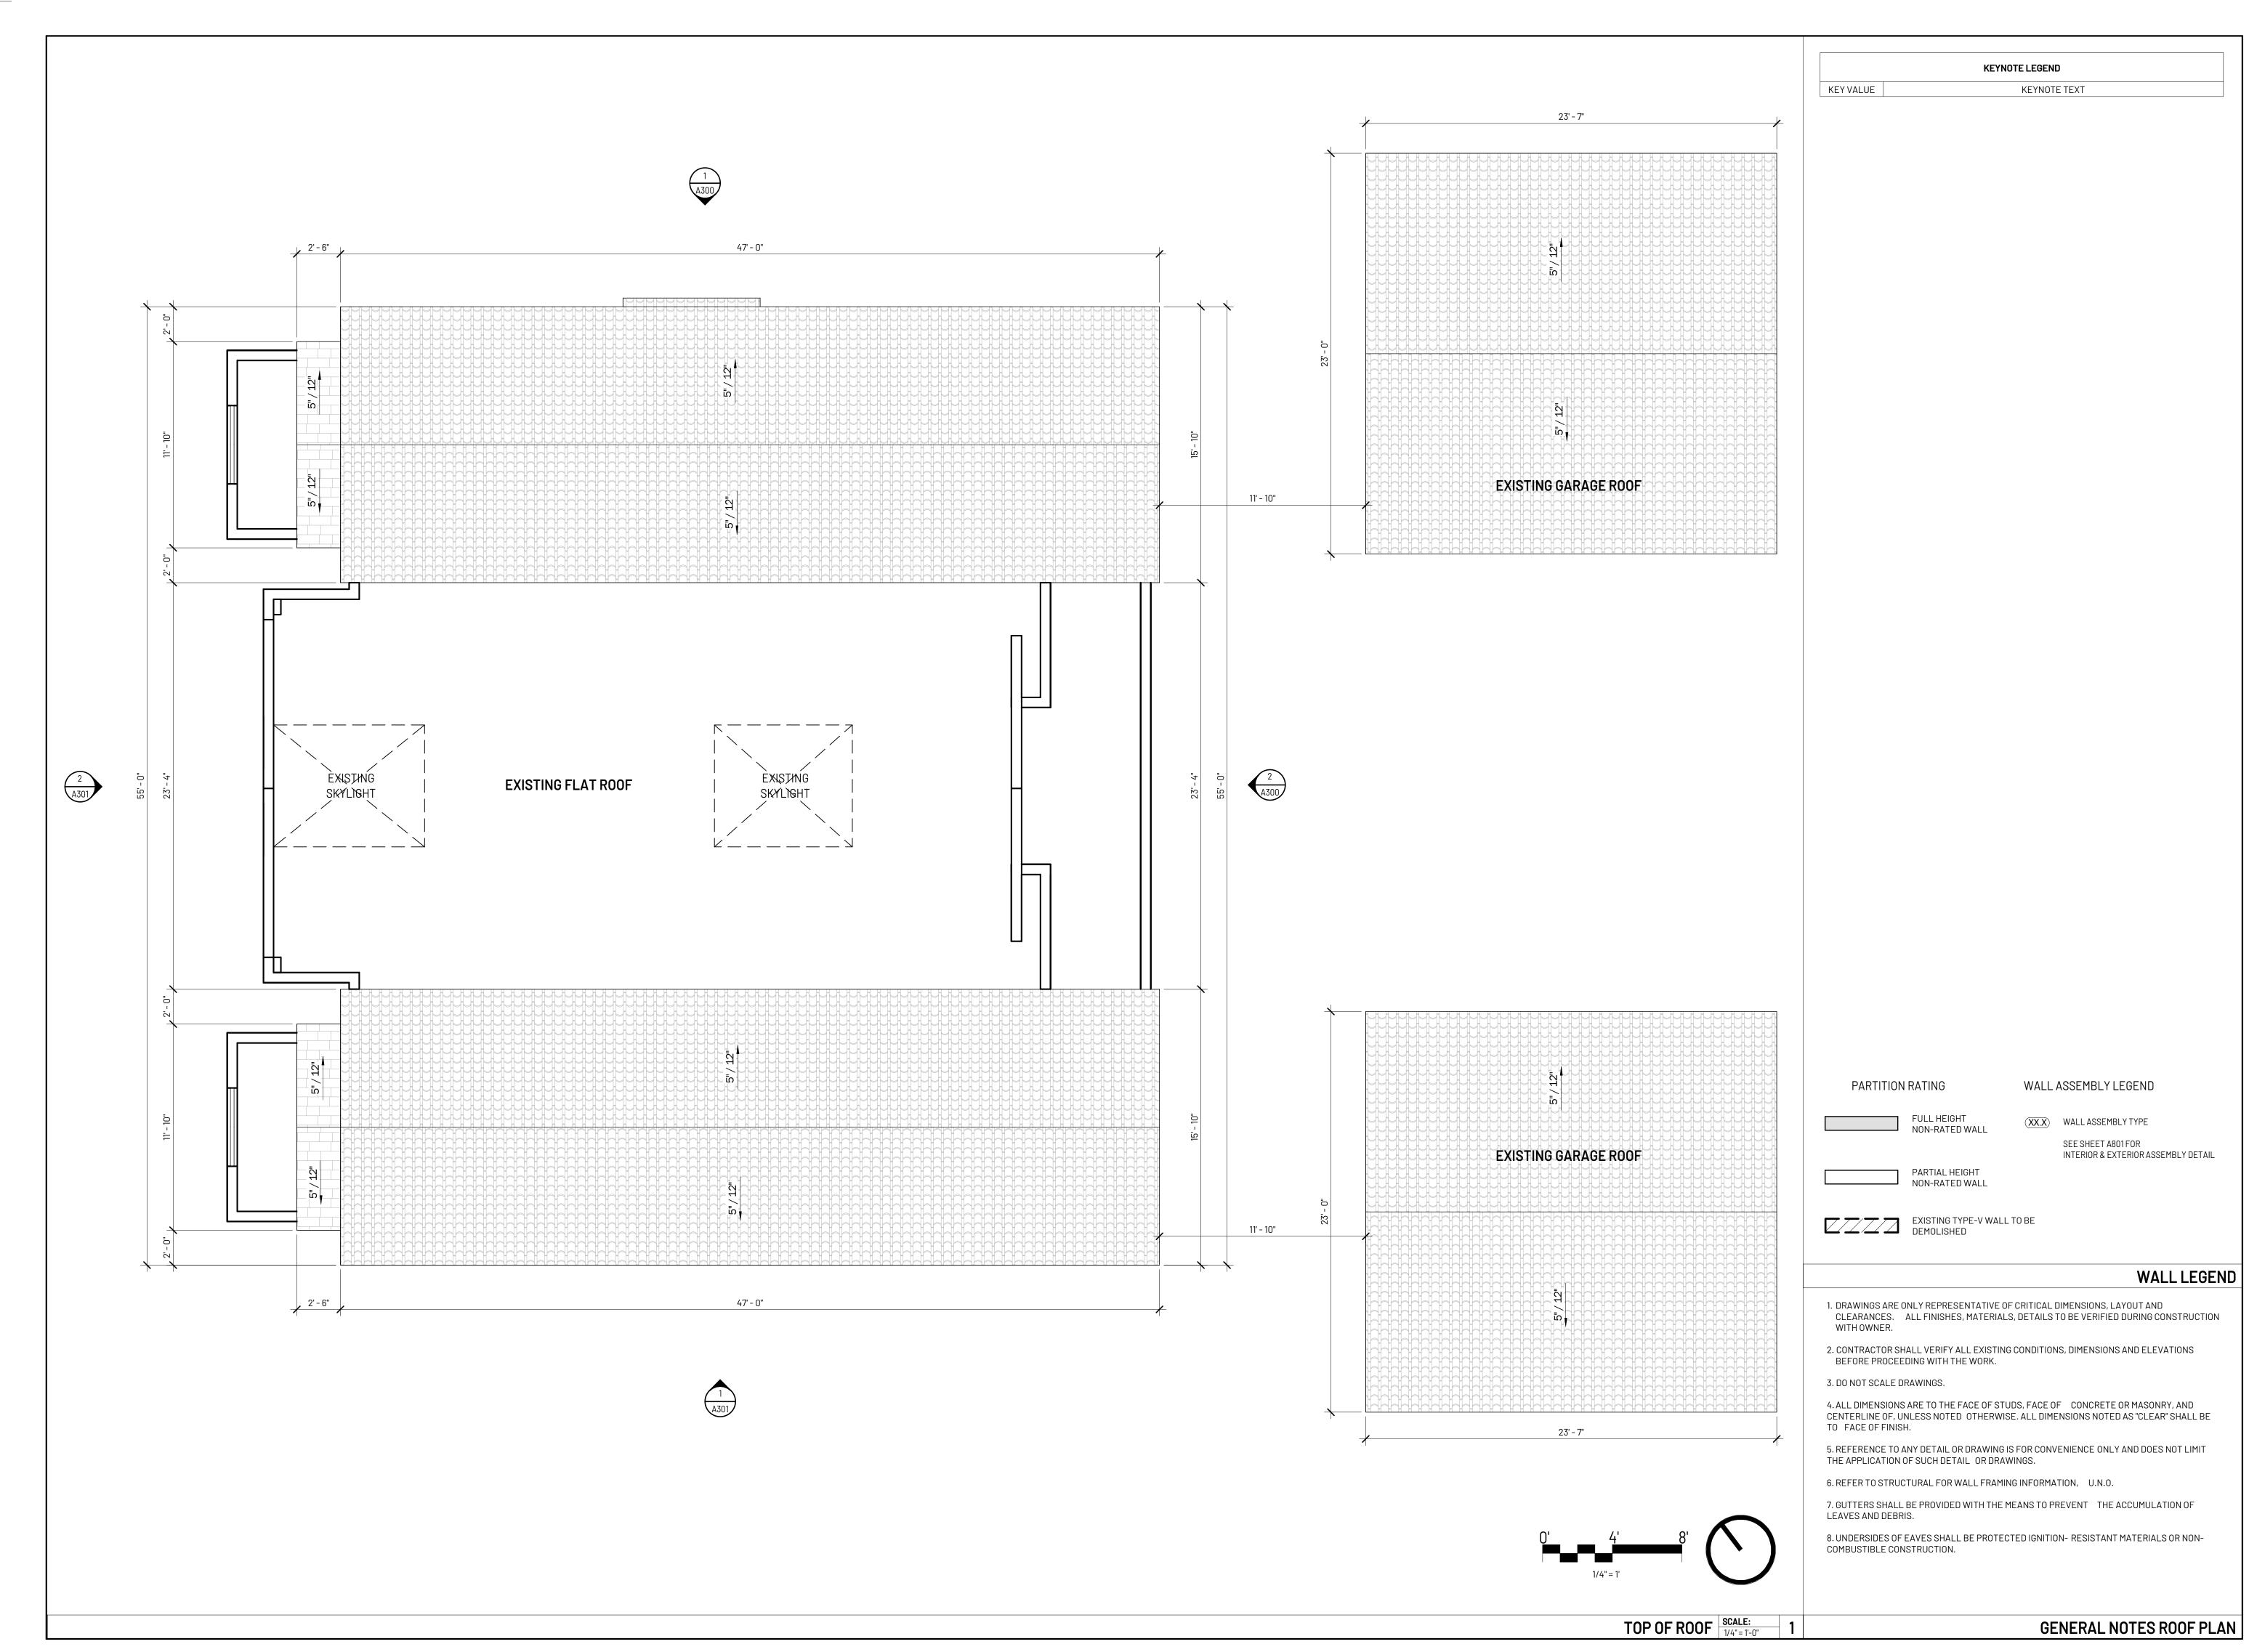

4195 CHINO HILLS PKWY, SUITE 599 CHINO HILLS, CA 91709

CONTACT: KEYUR MARU 714.390.0525 KMARU@SAJNIDESIGN.COM

BARRY DADON

23939 PARK GRANADA, CALABASAS, CA 91302

TEL: 310.905.9943 EMAIL: BARRYDADON@GMAIL.COM

PROJECT:

DADON RESIDENCE

23939 PARK GRANADA, CALABASAS, CA 91302

REVISION: DESCRIPTION



REPRODUCED IN WHOLE OR IN PART. IT IS TO BE USED FOR THE PROJECT AND SITE SPECIFICALLY IDENTIFIED HEREIN AND IS NOT TO BE USED ON ANY OTHER PROJECT. THIS DRAWING IS TO BE RETURNED UPON THE WRITTEN REQUEST OF **sda**. © COPYRIGHT 2022 SAJNI DESIGN & ARCHITECTURE

DRAWIN


ALL RIGHTS RESERVED.

NG DATA:	
CT NO	22062
ΠΔΤF	04.01.2

PROJECT NO	220625
ISSUE DATE	04.01.2022
SCALE	As indicated
DRAWN BY	Author
SHEET SIZE	24" x 36"

IF SHEET IS LESS THAN SIZE INDICATED ABOVE, THIS IS A REDUCED PRINT. REDUCE SCALE ACCORDINGLY.

EXISTING ROOF PLAN

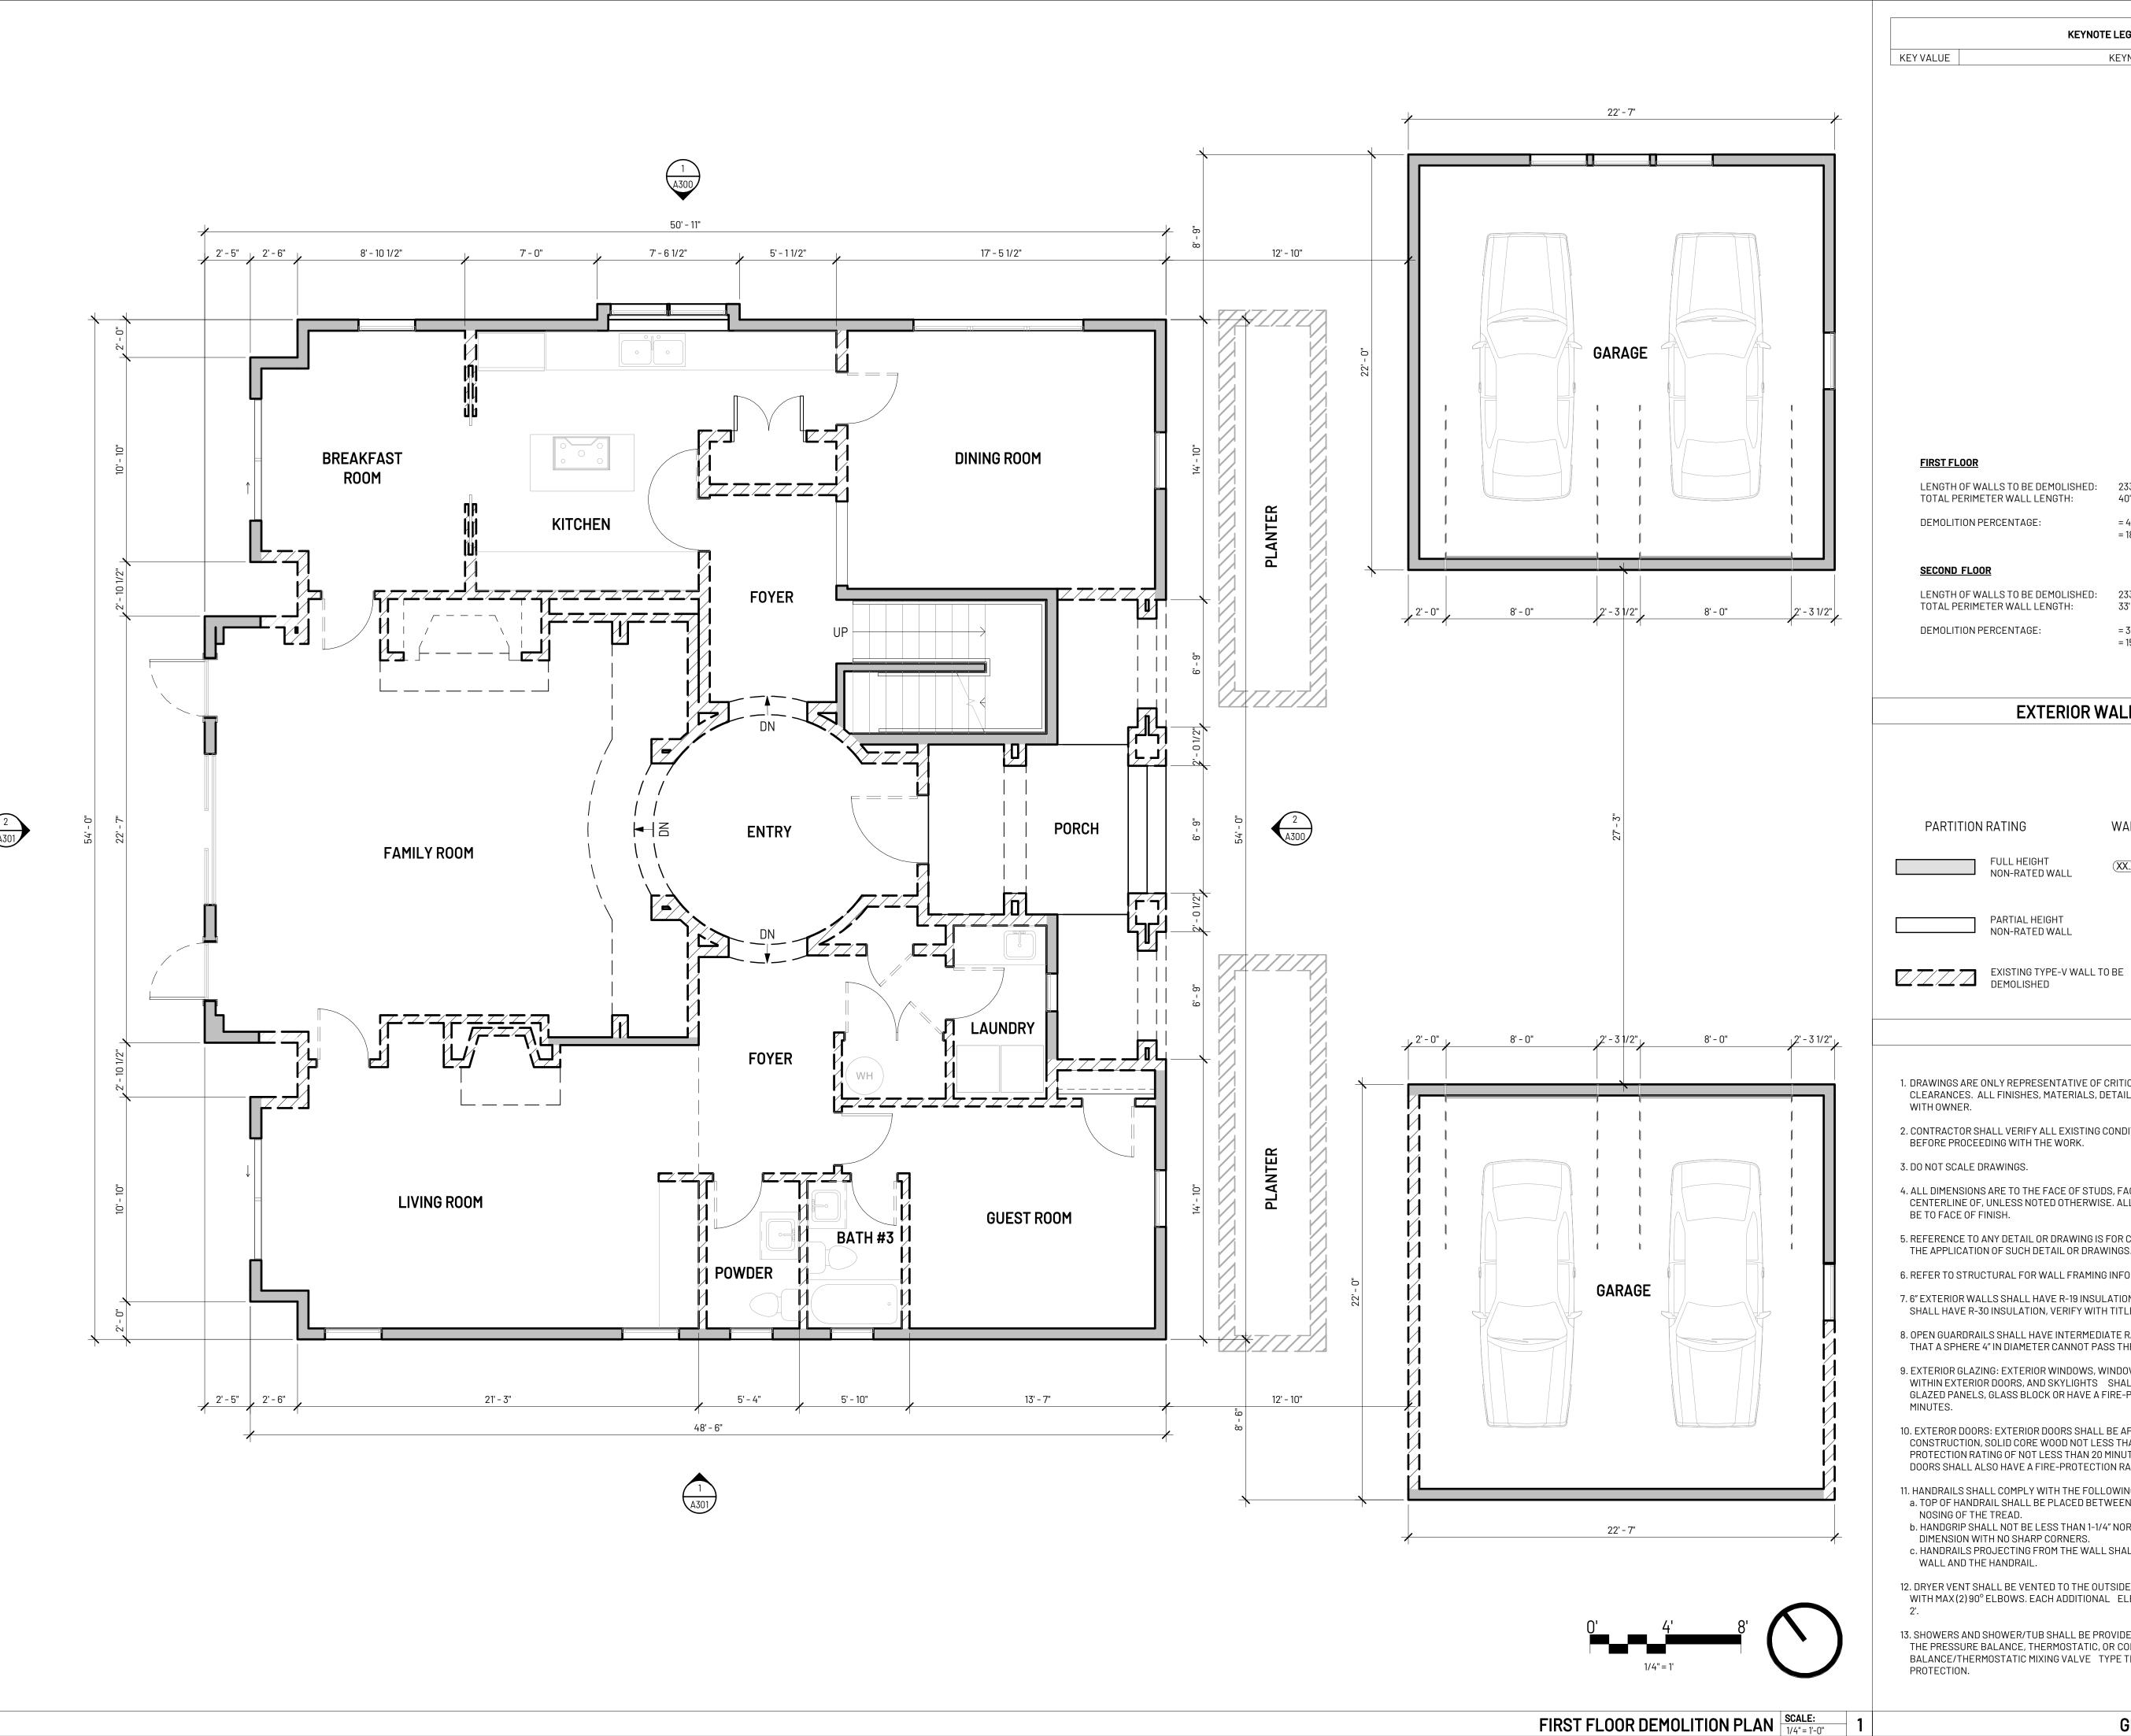

KEYNOTE LEGEND

KEYNOTE TEXT

LENGTH OF WALLS TO BE DEMOLISHED: 233' - 9" TOTAL PERIMETER WALL LENGTH: 40' - 0" = 40' / 233' - 9"

LENGTH OF WALLS TO BE DEMOLISHED: 233' - 9" TOTAL PERIMETER WALL LENGTH: 33' - 6" DEMOLITION PERCENTAGE: = 33' - 6" / 233' - 9"

EXTERIOR WALL DEMOLITION CALCULATION

= 18%

= 15%

PARTITION RATING

WALL ASSEMBLY LEGEND

FULL HEIGHT NON-RATED WALL

(XX.X) WALL ASSEMBLY TYPE SEE SHEET A801 FOR INTERIOR & EXTERIOR ASSEMBLY DETAIL

PARTIAL HEIGHT NON-RATED WALL

WALL LEGEND

- 1. DRAWINGS ARE ONLY REPRESENTATIVE OF CRITICAL DIMENSIONS, LAYOUT AND CLEARANCES. ALL FINISHES, MATERIALS, DETAILS TO BE VERIFIED DURING CONSTRUCTION
- 2. CONTRACTOR SHALL VERIFY ALL EXISTING CONDITIONS, DIMENSIONS AND ELEVATIONS
- 3. DO NOT SCALE DRAWINGS.
- 4. ALL DIMENSIONS ARE TO THE FACE OF STUDS, FACE OF CONCRETE OR MASONRY, AND CENTERLINE OF, UNLESS NOTED OTHERWISE. ALL DIMENSIONS NOTED AS "CLEAR" SHALL BE TO FACE OF FINISH.
- 5. REFERENCE TO ANY DETAIL OR DRAWING IS FOR CONVENIENCE ONLY AND DOES NOT LIMIT THE APPLICATION OF SUCH DETAIL OR DRAWINGS.
- 6. REFER TO STRUCTURAL FOR WALL FRAMING INFORMATION, U.N.O.
- 7. 6" EXTERIOR WALLS SHALL HAVE R-19 INSULATION (4" WALLS SHALL HAVE R-13). ROOFS SHALL HAVE R-30 INSULATION, VERIFY WITH TITLE 24 REPORT.
- 8. OPEN GUARDRAILS SHALL HAVE INTERMEDIATE RAILS, OR AN ORNAMENTAL PATTERN SUCH THAT A SPHERE 4" IN DIAMETER CANNOT PASS THROUGH.
- 9. EXTERIOR GLAZING: EXTERIOR WINDOWS, WINDOW WALLS AND GLAZED DOORS, WINDOWS WITHIN EXTERIOR DOORS, AND SKYLIGHTS SHALL BE TEMPERED GLASS, MULTI LAYERED GLAZED PANELS, GLASS BLOCK OR HAVE A FIRE-PROTECTION RATING OF NOT LESS THAN 20
- 10. EXTEROR DOORS: EXTERIOR DOORS SHALL BE APPROVED NON-COMBUSTIBLE CONSTRUCTION, SOLID CORE WOOD NOT LESS THAN 1-3/4" THICK, OR HAVE A FIRE PROTECTION RATING OF NOT LESS THAN 20 MINUTES. WINDOWS WITHIN DOORS AND GLAZED DOORS SHALL ALSO HAVE A FIRE-PROTECTION RATING OF NOT LESS THAN 20 MINUTES.
- 11. HANDRAILS SHALL COMPLY WITH THE FOLLOWING: a. TOP OF HANDRAIL SHALL BE PLACED BETWEEN 34" & 38" ABOVE LANDINGS AND THE
- NOSING OF THE TREAD. b. HANDGRIP SHALL NOT BE LESS THAN 1-1/4" NOR MORE THAN 2" IN CROSS-SECTIONAL
- DIMENSION WITH NO SHARP CORNERS.
- c. HANDRAILS PROJECTING FROM THE WALL SHALL NOT HAVE LESS THAN 1-1/2" BETWEEN WALL AND THE HANDRAIL.
- 12. DRYER VENT SHALL BE VENTED TO THE OUTSIDE AND SHALL NOT EXCEED 14' DISTANCE WITH MAX (2) 90° ELBOWS. EACH ADDITIONAL ELBOW SHALL REDUCE THE MAX LENGTH BY
- 13. SHOWERS AND SHOWER/TUB SHALL BE PROVIDED WITH INDIVIDUAL CONTROL VALVES OF THE PRESSURE BALANCE, THERMOSTATIC, OR COMBINATION PRESSURE BALANCE/THERMOSTATIC MIXING VALVE TYPE THAT PROVIDE SCALD AND THERMAL SHOCK

GENERAL NOTES FLOOR PLAN

CREATIVE STUDIO

4195 CHINO HILLS PKWY, SUITE 599 CHINO HILLS, CA 91709

CONTACT: KEYUR MARU 714.390.0525 KMARU@SAJNIDESIGN.COM

BARRY DADON

23939 PARK GRANADA, CALABASAS, CA 91302

TEL: 310.905.9943 EMAIL: BARRYDADON@GMAIL.COM

PROJECT:

DADON RESIDENCE

23939 PARK GRANADA, CALABASAS, CA 91302

REVISION: MARK DESCRIPTION



REPRODUCED IN WHOLE OR IN PART. IT IS TO BE USED FOR THE PROJECT AND SITE SPECIFICALLY IDENTIFIED HEREIN AND IS NOT TO BE USED ON ANY OTHER PROJECT. THIS DRAWING IS TO BE RETURNED UPON THE WRITTEN REQUEST OF sda. © COPYRIGHT 2022 SAJNI DESIGN & ARCHITECTURE


ALL RIGHTS RESERVED.


DRAWING DATA:

PROJECT NO 220625 ISSUE DATE 04.01.2022 SCALE As indicated DRAWN BY Author SHEET SIZE

IF SHEET IS LESS THAN SIZE INDICATED ABOVE, THIS IS A REDUCED PRINT. REDUCE SCALE ACCORDINGLY.

FIRST FLOOR **DEMO PLAN**

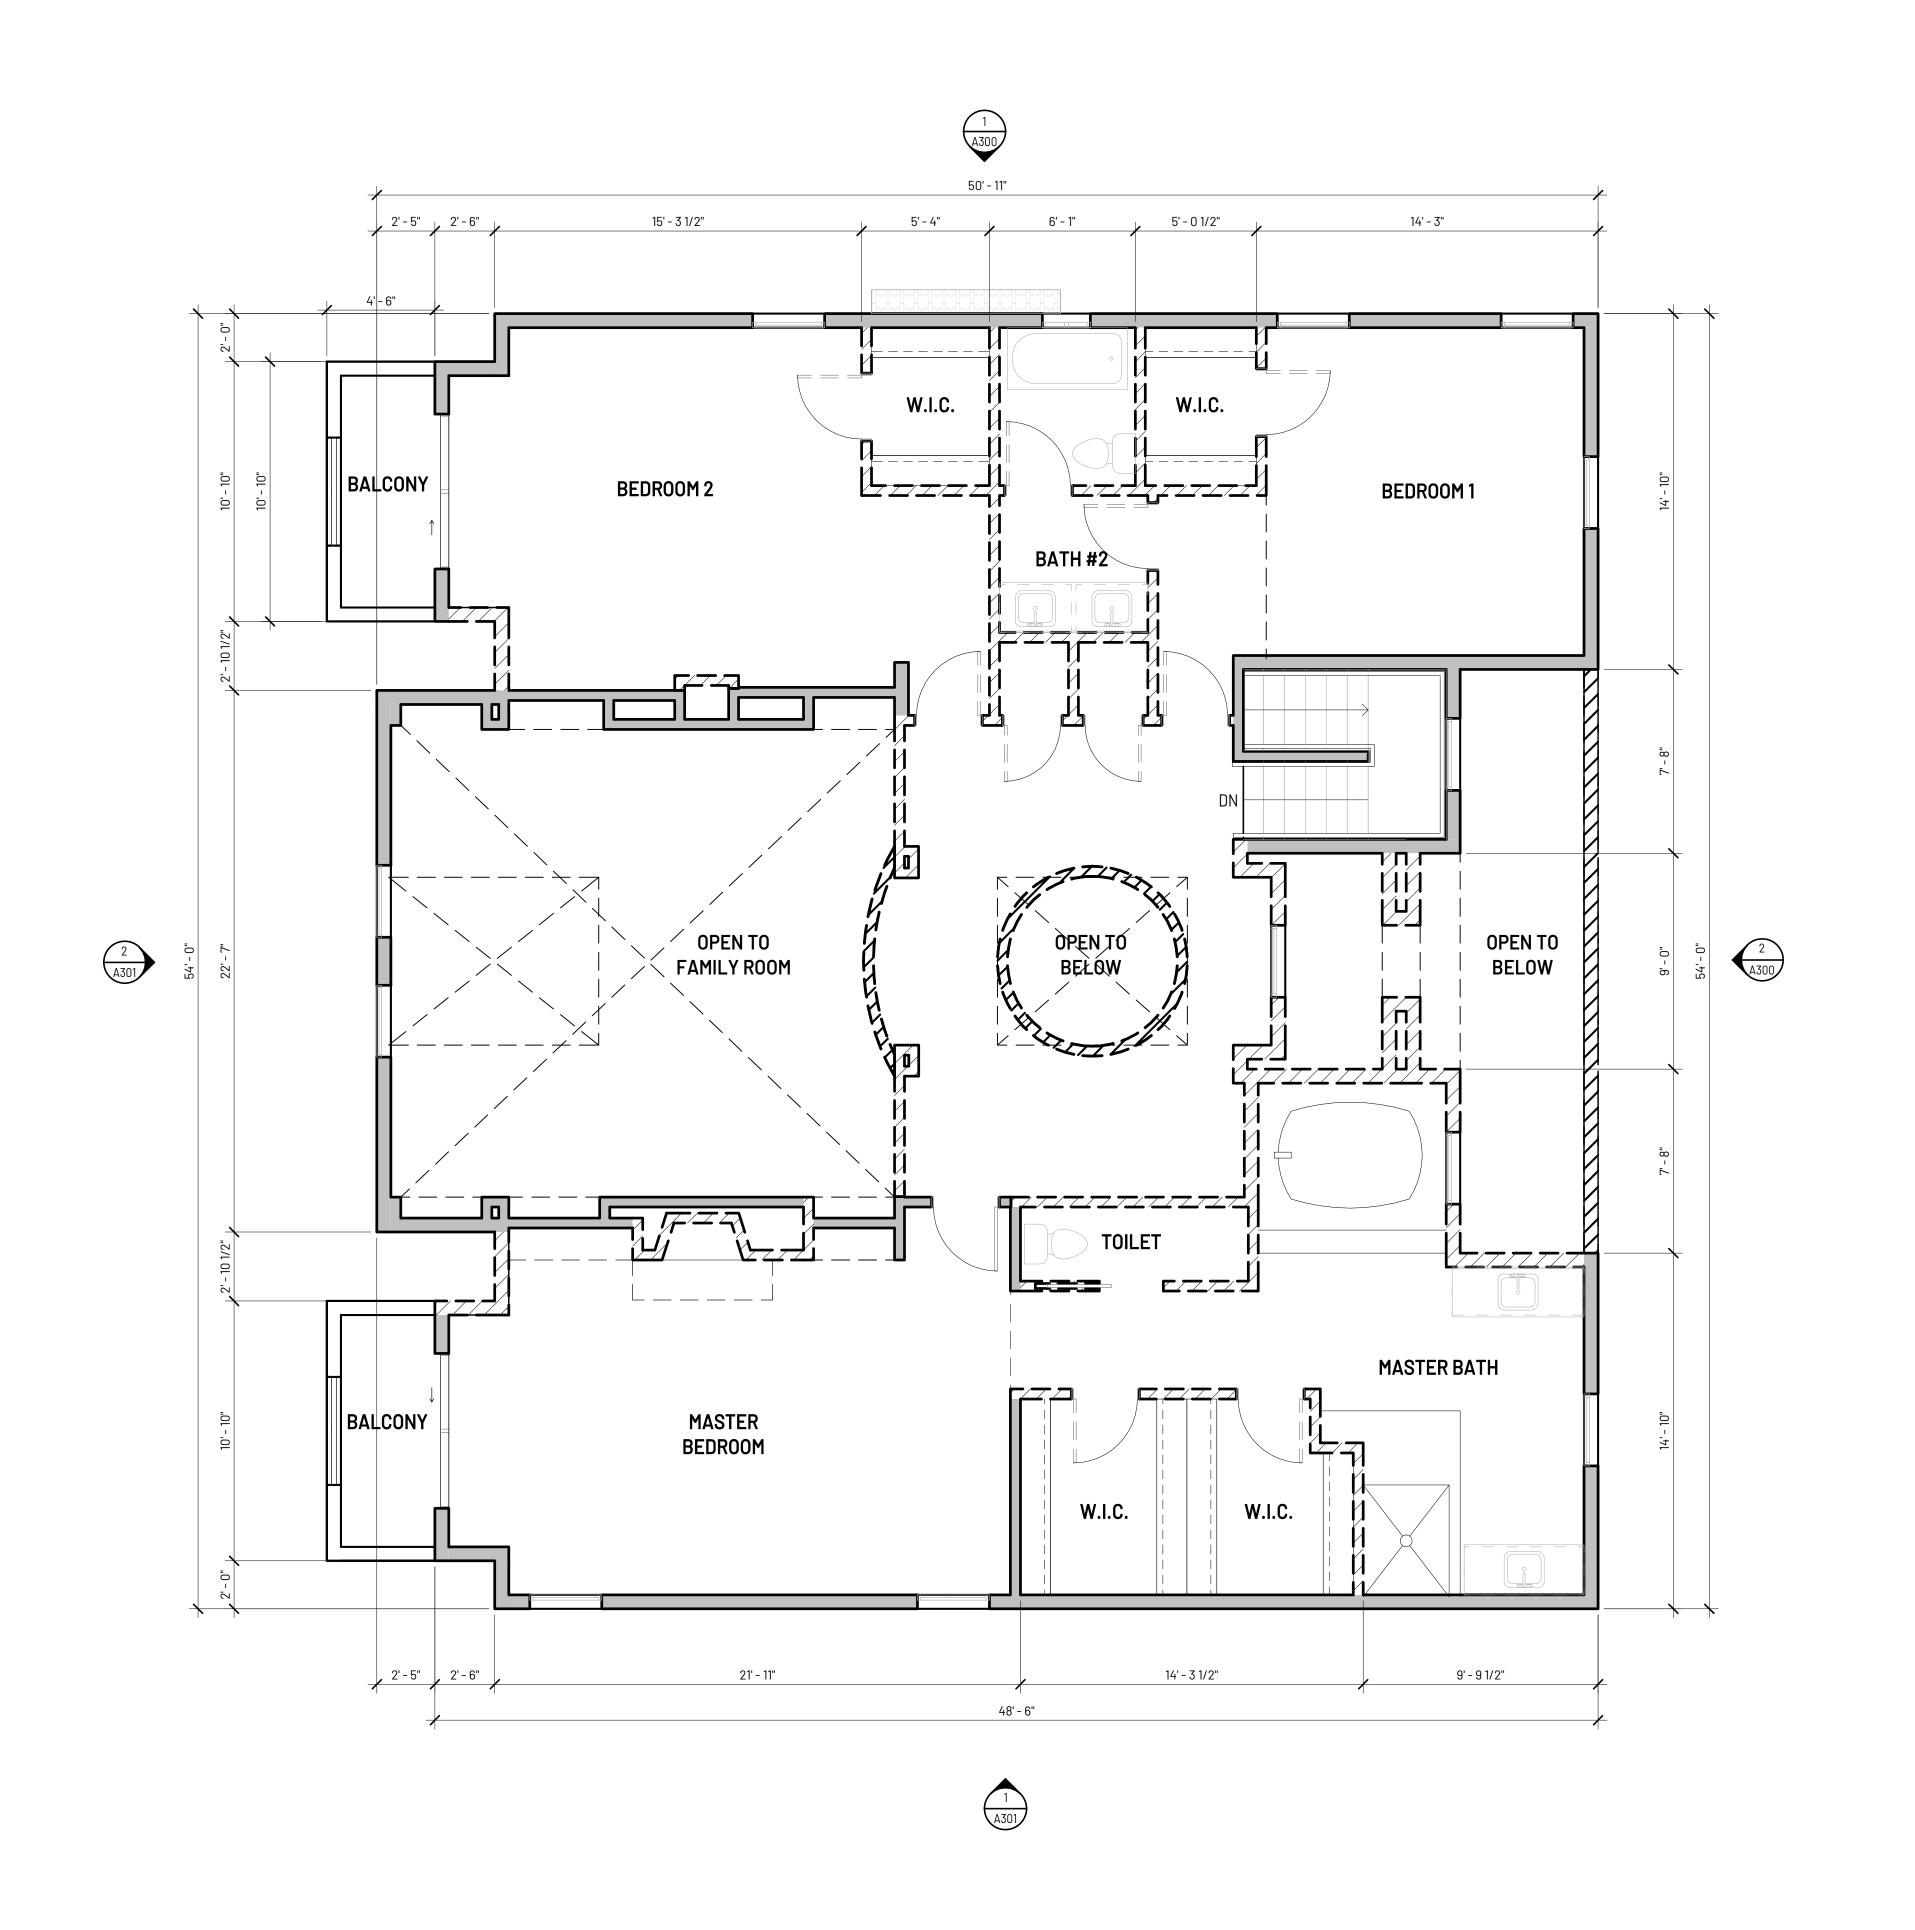

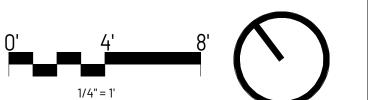

KEYNOTE LEGEND KEYNOTE TEXT

KEY VALUE

FIRST FLOOR

LENGTH OF WALLS TO BE DEMOLISHED: 233' - 9" TOTAL PERIMETER WALL LENGTH: 40' - 0" = 40' / 233' - 9" DEMOLITION PERCENTAGE:

SECOND FLOOR

LENGTH OF WALLS TO BE DEMOLISHED: 233' - 9" TOTAL PERIMETER WALL LENGTH: 33' - 6" DEMOLITION PERCENTAGE:

= 33' - 6" / 233' - 9" = 15%

= 18%

EXTERIOR WALL DEMOLITION CALCULATION

PARTITION RATING

WALL ASSEMBLY LEGEND

FULL HEIGHT NON-RATED WALL

(XX.X) WALL ASSEMBLY TYPE

SEE SHEET A801 FOR INTERIOR & EXTERIOR ASSEMBLY DETAIL

PARTIAL HEIGHT NON-RATED WALL

EXISTING TYPE-V WALL TO BE DEMOLISHED

WALL LEGEND

- 1. DRAWINGS ARE ONLY REPRESENTATIVE OF CRITICAL DIMENSIONS, LAYOUT AND CLEARANCES. ALL FINISHES, MATERIALS, DETAILS TO BE VERIFIED DURING CONSTRUCTION
- 2. CONTRACTOR SHALL VERIFY ALL EXISTING CONDITIONS, DIMENSIONS AND ELEVATIONS BEFORE PROCEEDING WITH THE WORK.
- 3. DO NOT SCALE DRAWINGS.
- 4. ALL DIMENSIONS ARE TO THE FACE OF STUDS, FACE OF CONCRETE OR MASONRY, AND CENTERLINE OF, UNLESS NOTED OTHERWISE. ALL DIMENSIONS NOTED AS "CLEAR" SHALL BE TO FACE OF FINISH.
- 5. REFERENCE TO ANY DETAIL OR DRAWING IS FOR CONVENIENCE ONLY AND DOES NOT LIMIT THE APPLICATION OF SUCH DETAIL OR DRAWINGS.
- 6. REFER TO STRUCTURAL FOR WALL FRAMING INFORMATION, U.N.O.
- 7. 6" EXTERIOR WALLS SHALL HAVE R-19 INSULATION (4" WALLS SHALL HAVE R-13). ROOFS SHALL HAVE R-30 INSULATION, VERIFY WITH TITLE 24 REPORT.
- 8. OPEN GUARDRAILS SHALL HAVE INTERMEDIATE RAILS, OR AN ORNAMENTAL PATTERN SUCH THAT A SPHERE 4" IN DIAMETER CANNOT PASS THROUGH.
- 9. EXTERIOR GLAZING: EXTERIOR WINDOWS, WINDOW WALLS AND GLAZED DOORS, WINDOWS WITHIN EXTERIOR DOORS, AND SKYLIGHTS SHALL BE TEMPERED GLASS, MULTI LAYERED GLAZED PANELS, GLASS BLOCK OR HAVE A FIRE-PROTECTION RATING OF NOT LESS THAN 20
- 10. EXTEROR DOORS: EXTERIOR DOORS SHALL BE APPROVED NON-COMBUSTIBLE CONSTRUCTION, SOLID CORE WOOD NOT LESS THAN 1-3/4" THICK, OR HAVE A FIRE PROTECTION RATING OF NOT LESS THAN 20 MINUTES. WINDOWS WITHIN DOORS AND GLAZED DOORS SHALL ALSO HAVE A FIRE-PROTECTION RATING OF NOT LESS THAN 20 MINUTES.
- 11. HANDRAILS SHALL COMPLY WITH THE FOLLOWING: a. TOP OF HANDRAIL SHALL BE PLACED BETWEEN 34" & 38" ABOVE LANDINGS AND THE
- NOSING OF THE TREAD.
- b. HANDGRIP SHALL NOT BE LESS THAN 1-1/4" NOR MORE THAN 2" IN CROSS-SECTIONAL DIMENSION WITH NO SHARP CORNERS.
- c. HANDRAILS PROJECTING FROM THE WALL SHALL NOT HAVE LESS THAN 1-1/2" BETWEEN WALL AND THE HANDRAIL.
- 12. DRYER VENT SHALL BE VENTED TO THE OUTSIDE AND SHALL NOT EXCEED 14' DISTANCE WITH MAX (2) 90° ELBOWS. EACH ADDITIONAL ELBOW SHALL REDUCE THE MAX LENGTH BY
- 13. SHOWERS AND SHOWER/TUB SHALL BE PROVIDED WITH INDIVIDUAL CONTROL VALVES OF THE PRESSURE BALANCE, THERMOSTATIC, OR COMBINATION PRESSURE BALANCE/THERMOSTATIC MIXING VALVE TYPE THAT PROVIDE SCALD AND THERMAL SHOCK



4195 CHINO HILLS PKWY, SUITE 599 CHINO HILLS, CA 91709

CONTACT: KEYUR MARU 714.390.0525 KMARU@SAJNIDESIGN.COM

BARRY DADON

23939 PARK GRANADA, CALABASAS, CA 91302


TEL: 310.905.9943 EMAIL: BARRYDADON@GMAIL.COM

PROJECT:

DADON RESIDENCE

23939 PARK GRANADA, CALABASAS, CA 91302

REVISION: MARK DESCRIPTION

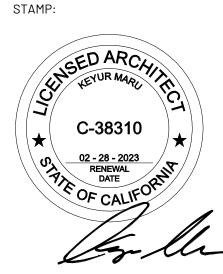

REPRODUCED IN WHOLE OR IN PART. IT IS TO BE USED FOR THE PROJECT AND SITE SPECIFICALLY IDENTIFIED HEREIN AND IS NOT TO BE USED ON ANY OTHER PROJECT. THIS DRAWING IS TO BE RETURNED UPON THE WRITTEN REQUEST OF sda. © COPYRIGHT 2022 SAJNI DESIGN & ARCHITECTURE ALL RIGHTS RESERVED.

DRAWING DATA:

DRAWN BY

PROJECT NO 220625 ISSUE DATE 04.01.2022 SCALE As indicated


SHEET SIZE IF SHEET IS LESS THAN SIZE INDICATED ABOVE, THIS IS A REDUCED PRINT. REDUCE SCALE ACCORDINGLY.

Author

SECOND FLOOR **DEMO PLAN**

SECOND FLOOR DEMOLITION PLAN SCALE: 1/4" = 1'-0" 1

GENERAL NOTES FLOOR PLAN

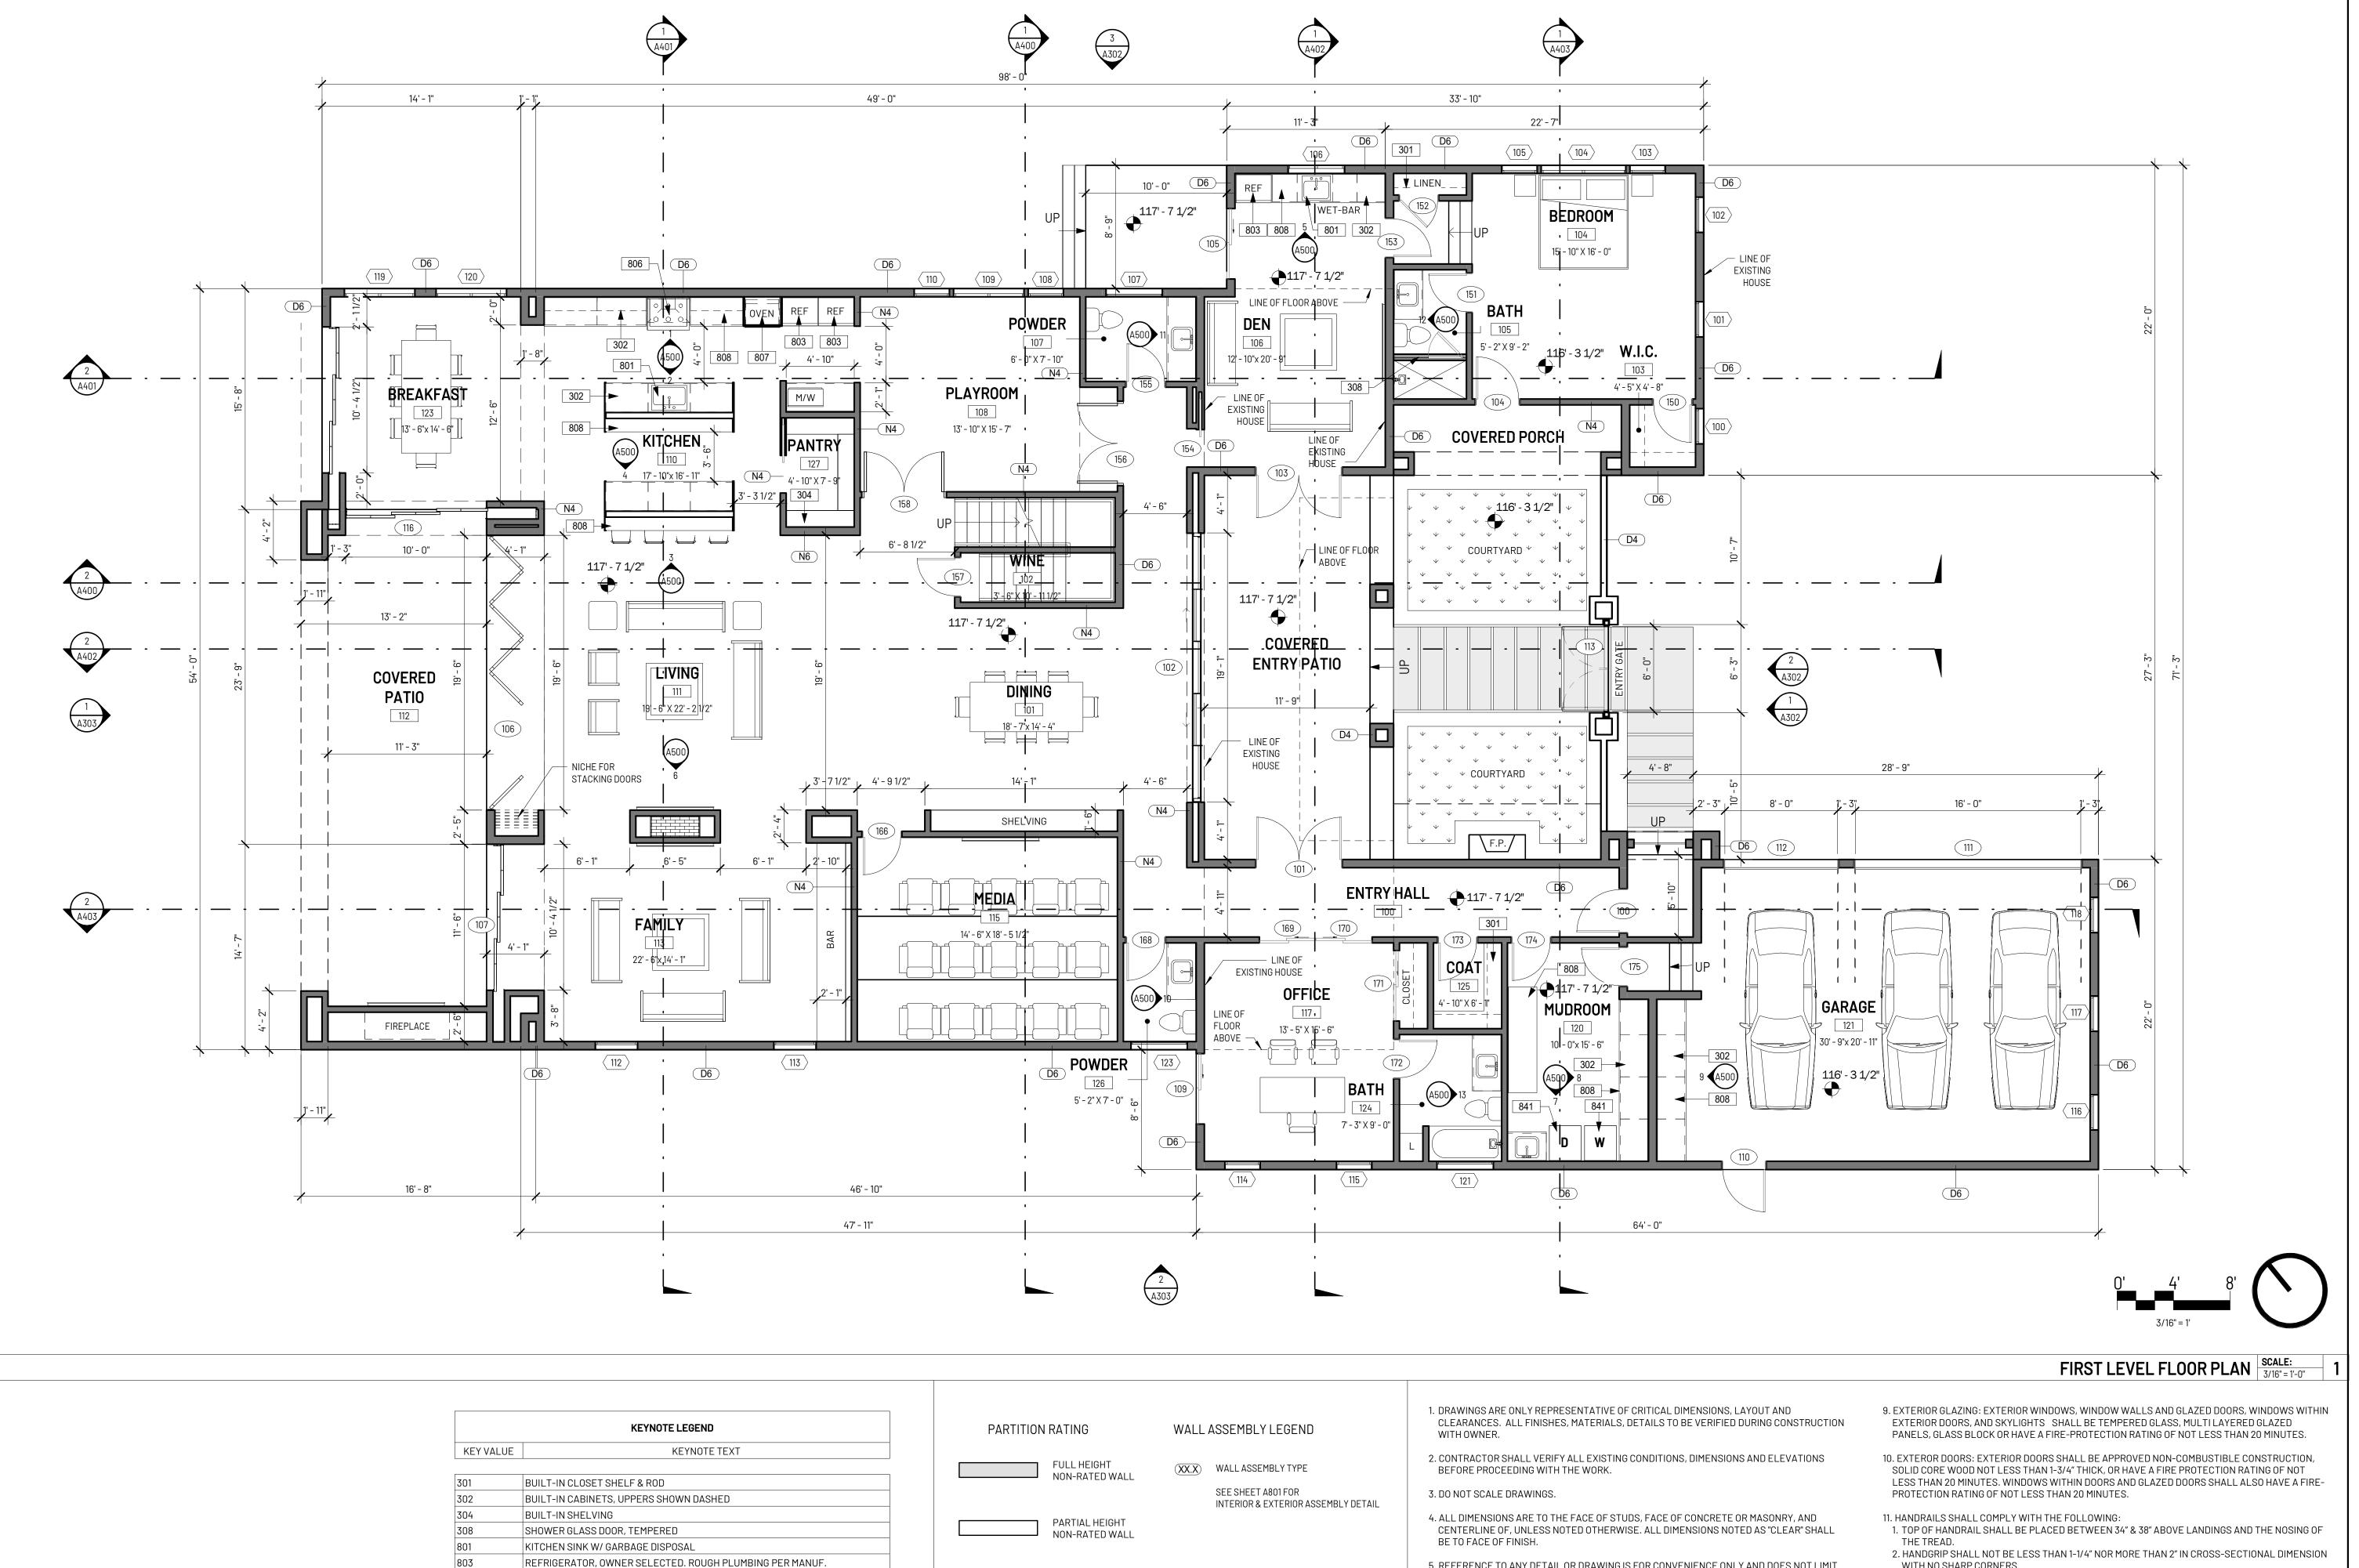

SPECIFICATIONS

COUNTERTOP

WASHER/DRYER

RANGE, PROVIDE GAS STUB & 220 ELECTRICAL

MICROWAVE, OWNER SELECTED

CREATIVE STUDIO

4195 CHINO HILLS PKWY, SUITE 599 CHINO HILLS, CA 91709

CONTACT: KEYUR MARU KMARU@SAJNIDESIGN.COM

BARRY DADON

23939 PARK GRANADA, CALABASAS, CA 91302

TEL: 310.905.9943 EMAIL: BARRYDADON@GMAIL.COM

DADON RESIDENCE

23939 PARK GRANADA, CALABASAS, CA 91302

REVISION:		
MARK	DESCRIPTION	DAT



REPRODUCED IN WHOLE OR IN PART. IT IS TO BE USED FOR THE PROJECT AND SITE SPECIFICALLY IDENTIFIED HEREIN AND IS NOT TO BE USED ON ANY OTHER PROJECT. THIS DRAWING IS TO BE RETURNED UPON THE WRITTEN REQUEST OF **sda**. © COPYRIGHT 2022 SAJNI DESIGN & ARCHITECTURE

DRAWING DATA:

ALL RIGHTS RESERVED.

SHEET SIZE

DNAWING DATA.	
PROJECT NO	220625
ISSUE DATE	04.01.2022
SCALE	As indicated
DRAWN BY	Author

IF SHEET IS LESS THAN SIZE INDICATED ABOVE, THIS IS A REDUCED PRINT. REDUCE SCALE ACCORDINGLY.

PROPOSED FIRST LEVEL PLAN

- 5. REFERENCE TO ANY DETAIL OR DRAWING IS FOR CONVENIENCE ONLY AND DOES NOT LIMIT THE APPLICATION OF SUCH DETAIL OR DRAWINGS.
- 6. REFER TO STRUCTURAL FOR WALL FRAMING INFORMATION, U.N.O.

WALL LEGEND

- 7. 6" EXTERIOR WALLS SHALL HAVE R-19 INSULATION (4" WALLS SHALL HAVE R-13). ROOFS SHALL HAVE R-30 INSULATION, VERIFY WITH TITLE 24 REPORT.
- 8. OPEN GUARDRAILS SHALL HAVE INTERMEDIATE RAILS, OR AN ORNAMENTAL PATTERN SUCH THAT A SPHERE 4" IN DIAMETER CANNOT PASS THROUGH.

13. SHOWERS AND SHOWER/TUB SHALL BE PROVIDED WITH INDIVIDUAL CONTROL VALVES OF THE PRESSURE BALANCE, THERMOSTATIC, OR COMBINATION PRESSURE BALANCE/THERMOSTATIC MIXING VALVE TYPE THAT PROVIDE SCALD AND THERMAL SHOCK PROTECTION.

AND THE HANDRAIL.


WITH NO SHARP CORNERS.

GENERAL NOTES FLOOR PLAN

3. HANDRAILS PROJECTING FROM THE WALL SHALL NOT HAVE LESS THAN 1-1/2" BETWEEN WALL

12. DRYER VENT SHALL BE VENTED TO THE OUTSIDE AND SHALL NOT EXCEED 14' DISTANCE WITH

MAX (2) 90° ELBOWS. EACH ADDITIONAL ELBOW SHALL REDUCE THE MAX LENGTH BY 2'.

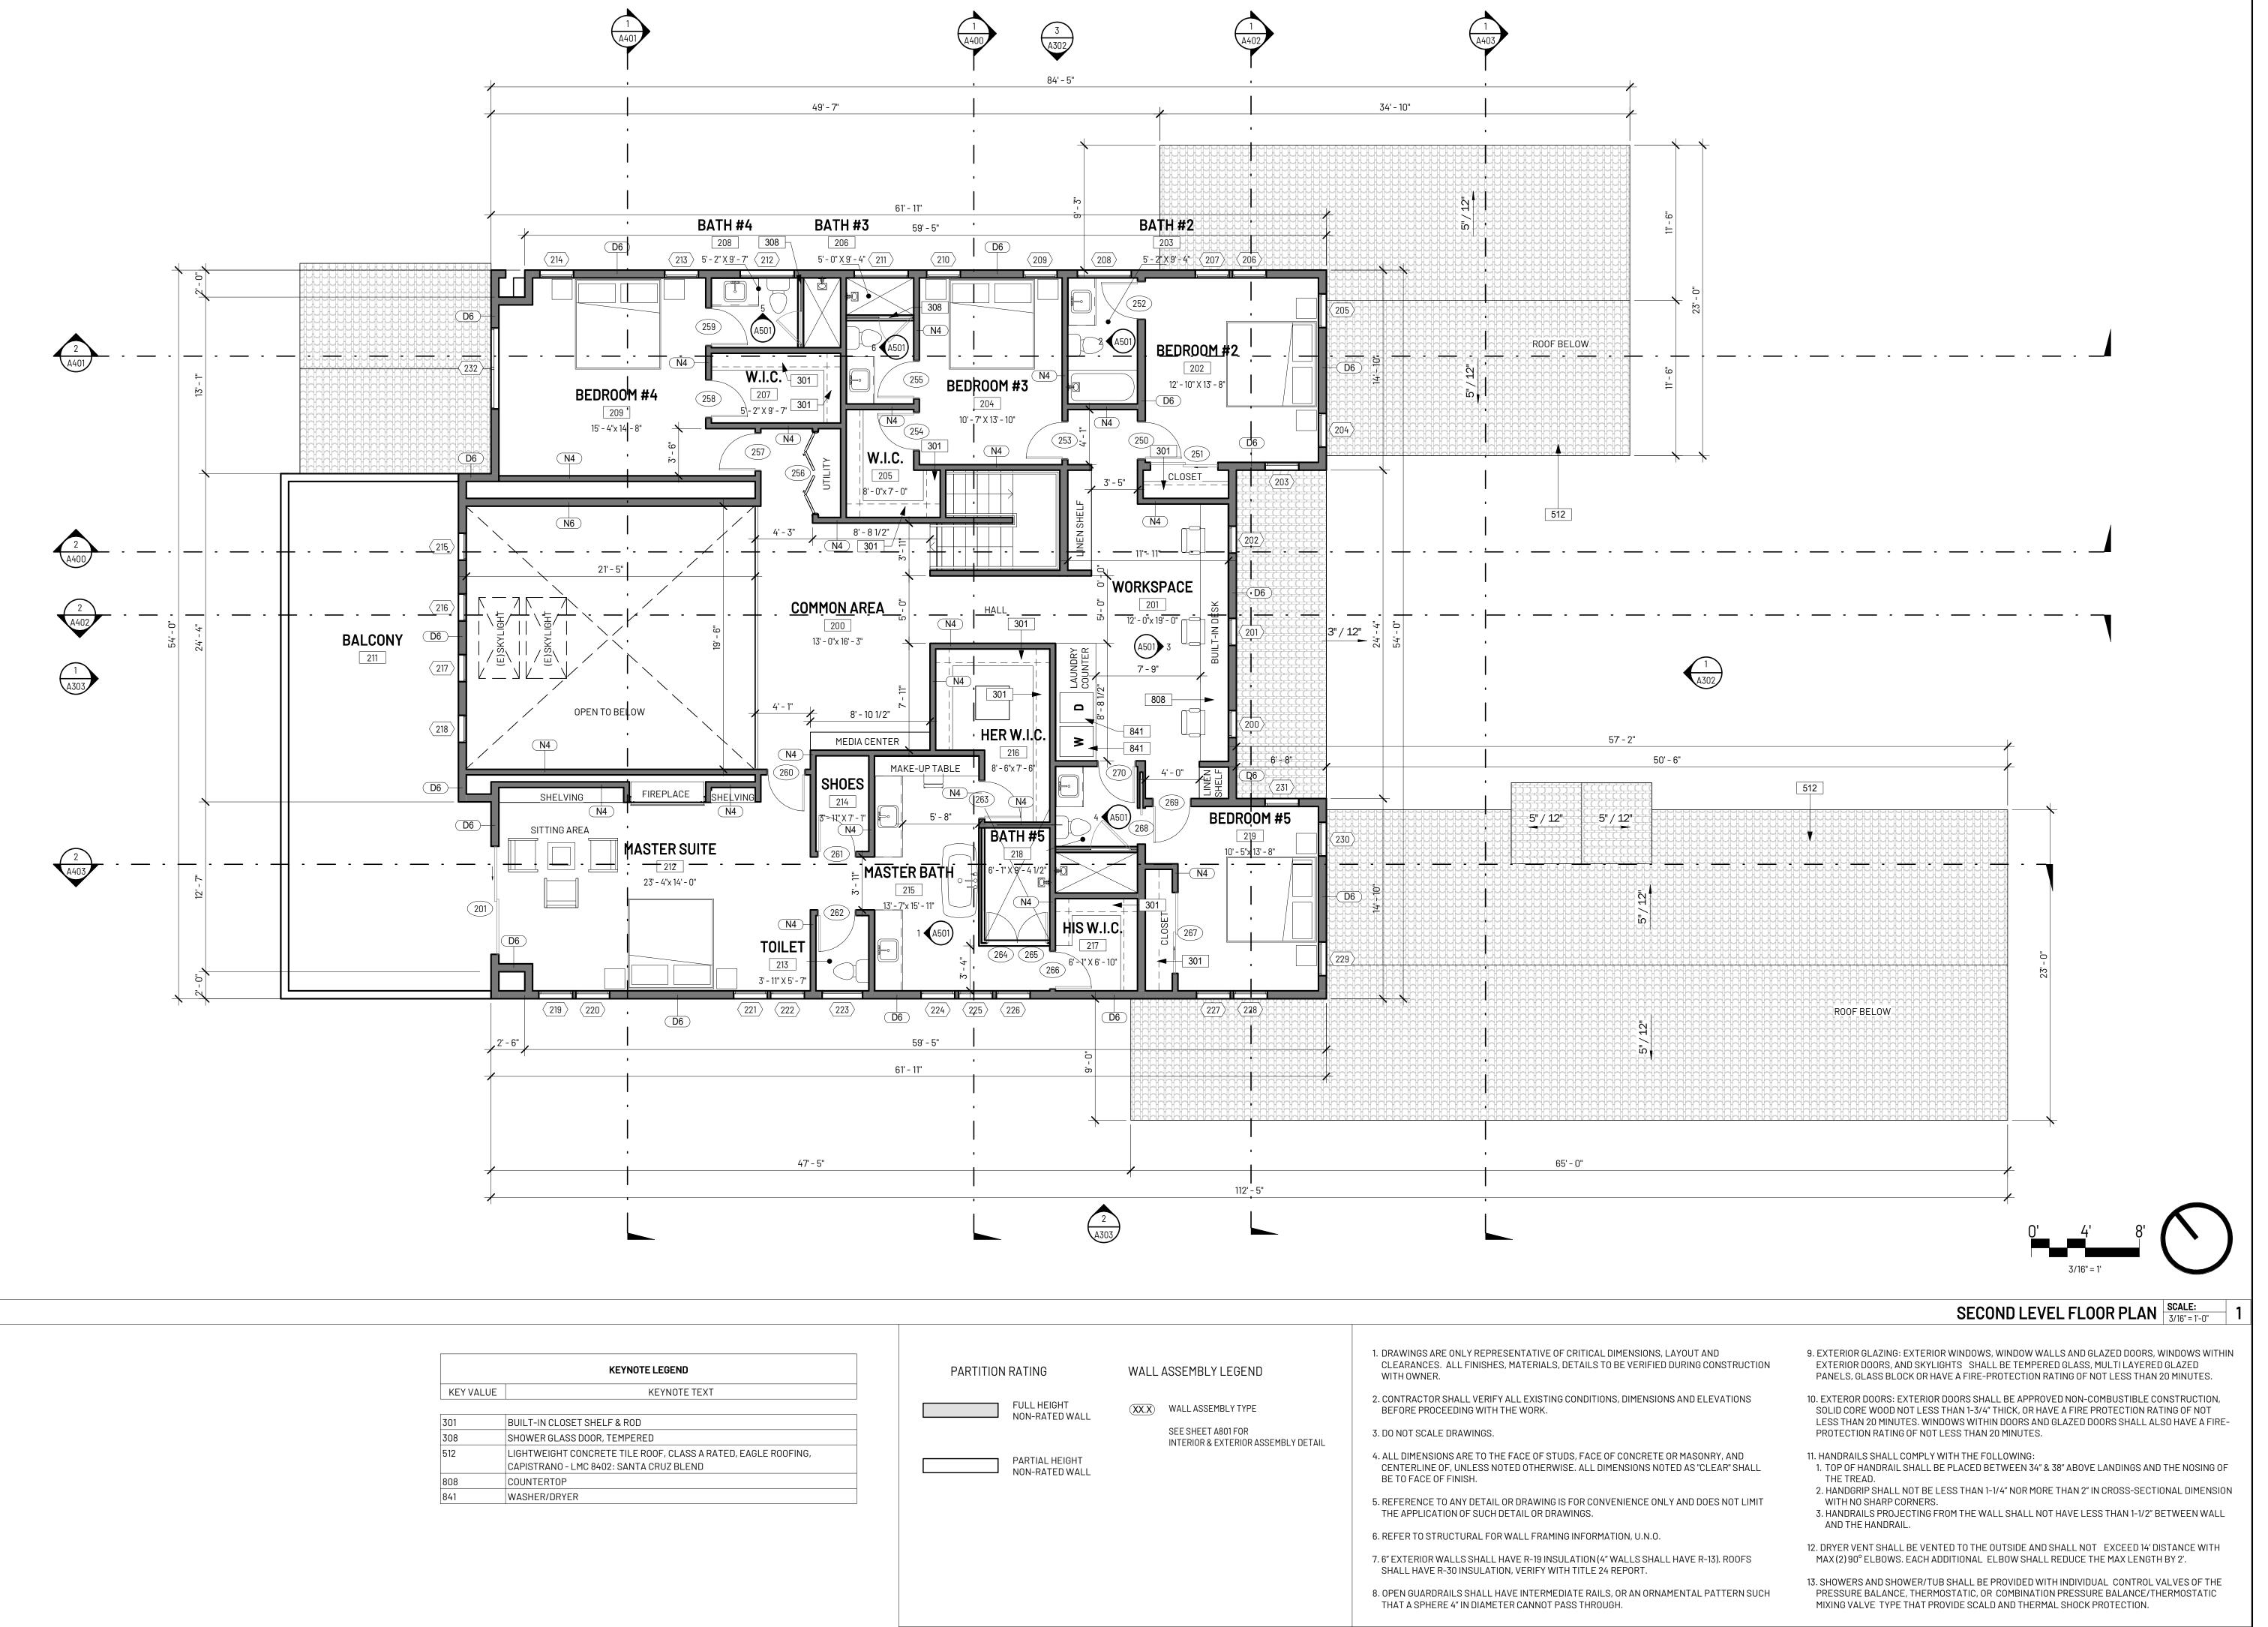

WALL LEGEND

SCI CREATIVE STUDIO

4195 CHINO HILLS PKWY, SUITE 599 CHINO HILLS, CA 91709

CONTACT: KEYUR MARU 714.390.0525 KMARU@SAJNIDESIGN.COM

CLIENT:

BARRY DADON

23939 PARK GRANADA,

CALABASAS, CA 91302

TEL: 310.905.9943 EMAIL: BARRYDADON@GMAIL.COM

DADON RESIDENCE

23939 PARK GRANADA, CALABASAS, CA 91302

MARK	DESCRIPTION	DATE



THIS DRAWING IS THE PROPERTY OF **sda** AND IS NOT TO BE REPRODUCED IN WHOLE OR IN PART. IT IS TO BE USED FOR THE PROJECT AND SITE SPECIFICALLY IDENTIFIED HEREIN AND IS NOT TO BE USED ON ANY OTHER PROJECT. THIS DRAWING IS TO BE RETURNED UPON THE WRITTEN REQUEST OF **sda**.

© COPYRIGHT 2022 SAJNI DESIGN & ARCHITECTURE

ALL RIGHTS RESERVED.

DRAWING DATA:	
DDG IEGENIG	


PROJECT NO	220625
ISSUE DATE	04.01.2022
SCALE	As indicated
DRAWN BY	Author
SHEET SIZE	24" x 36"

IF SHEET IS LESS THAN SIZE INDICATED ABOVE, THIS IS A REDUCED PRINT. REDUCE SCALE ACCORDINGLY.

PROPOSED
SECOND LVL PLAN

A206

GENERAL NOTES FLOOR PLAN

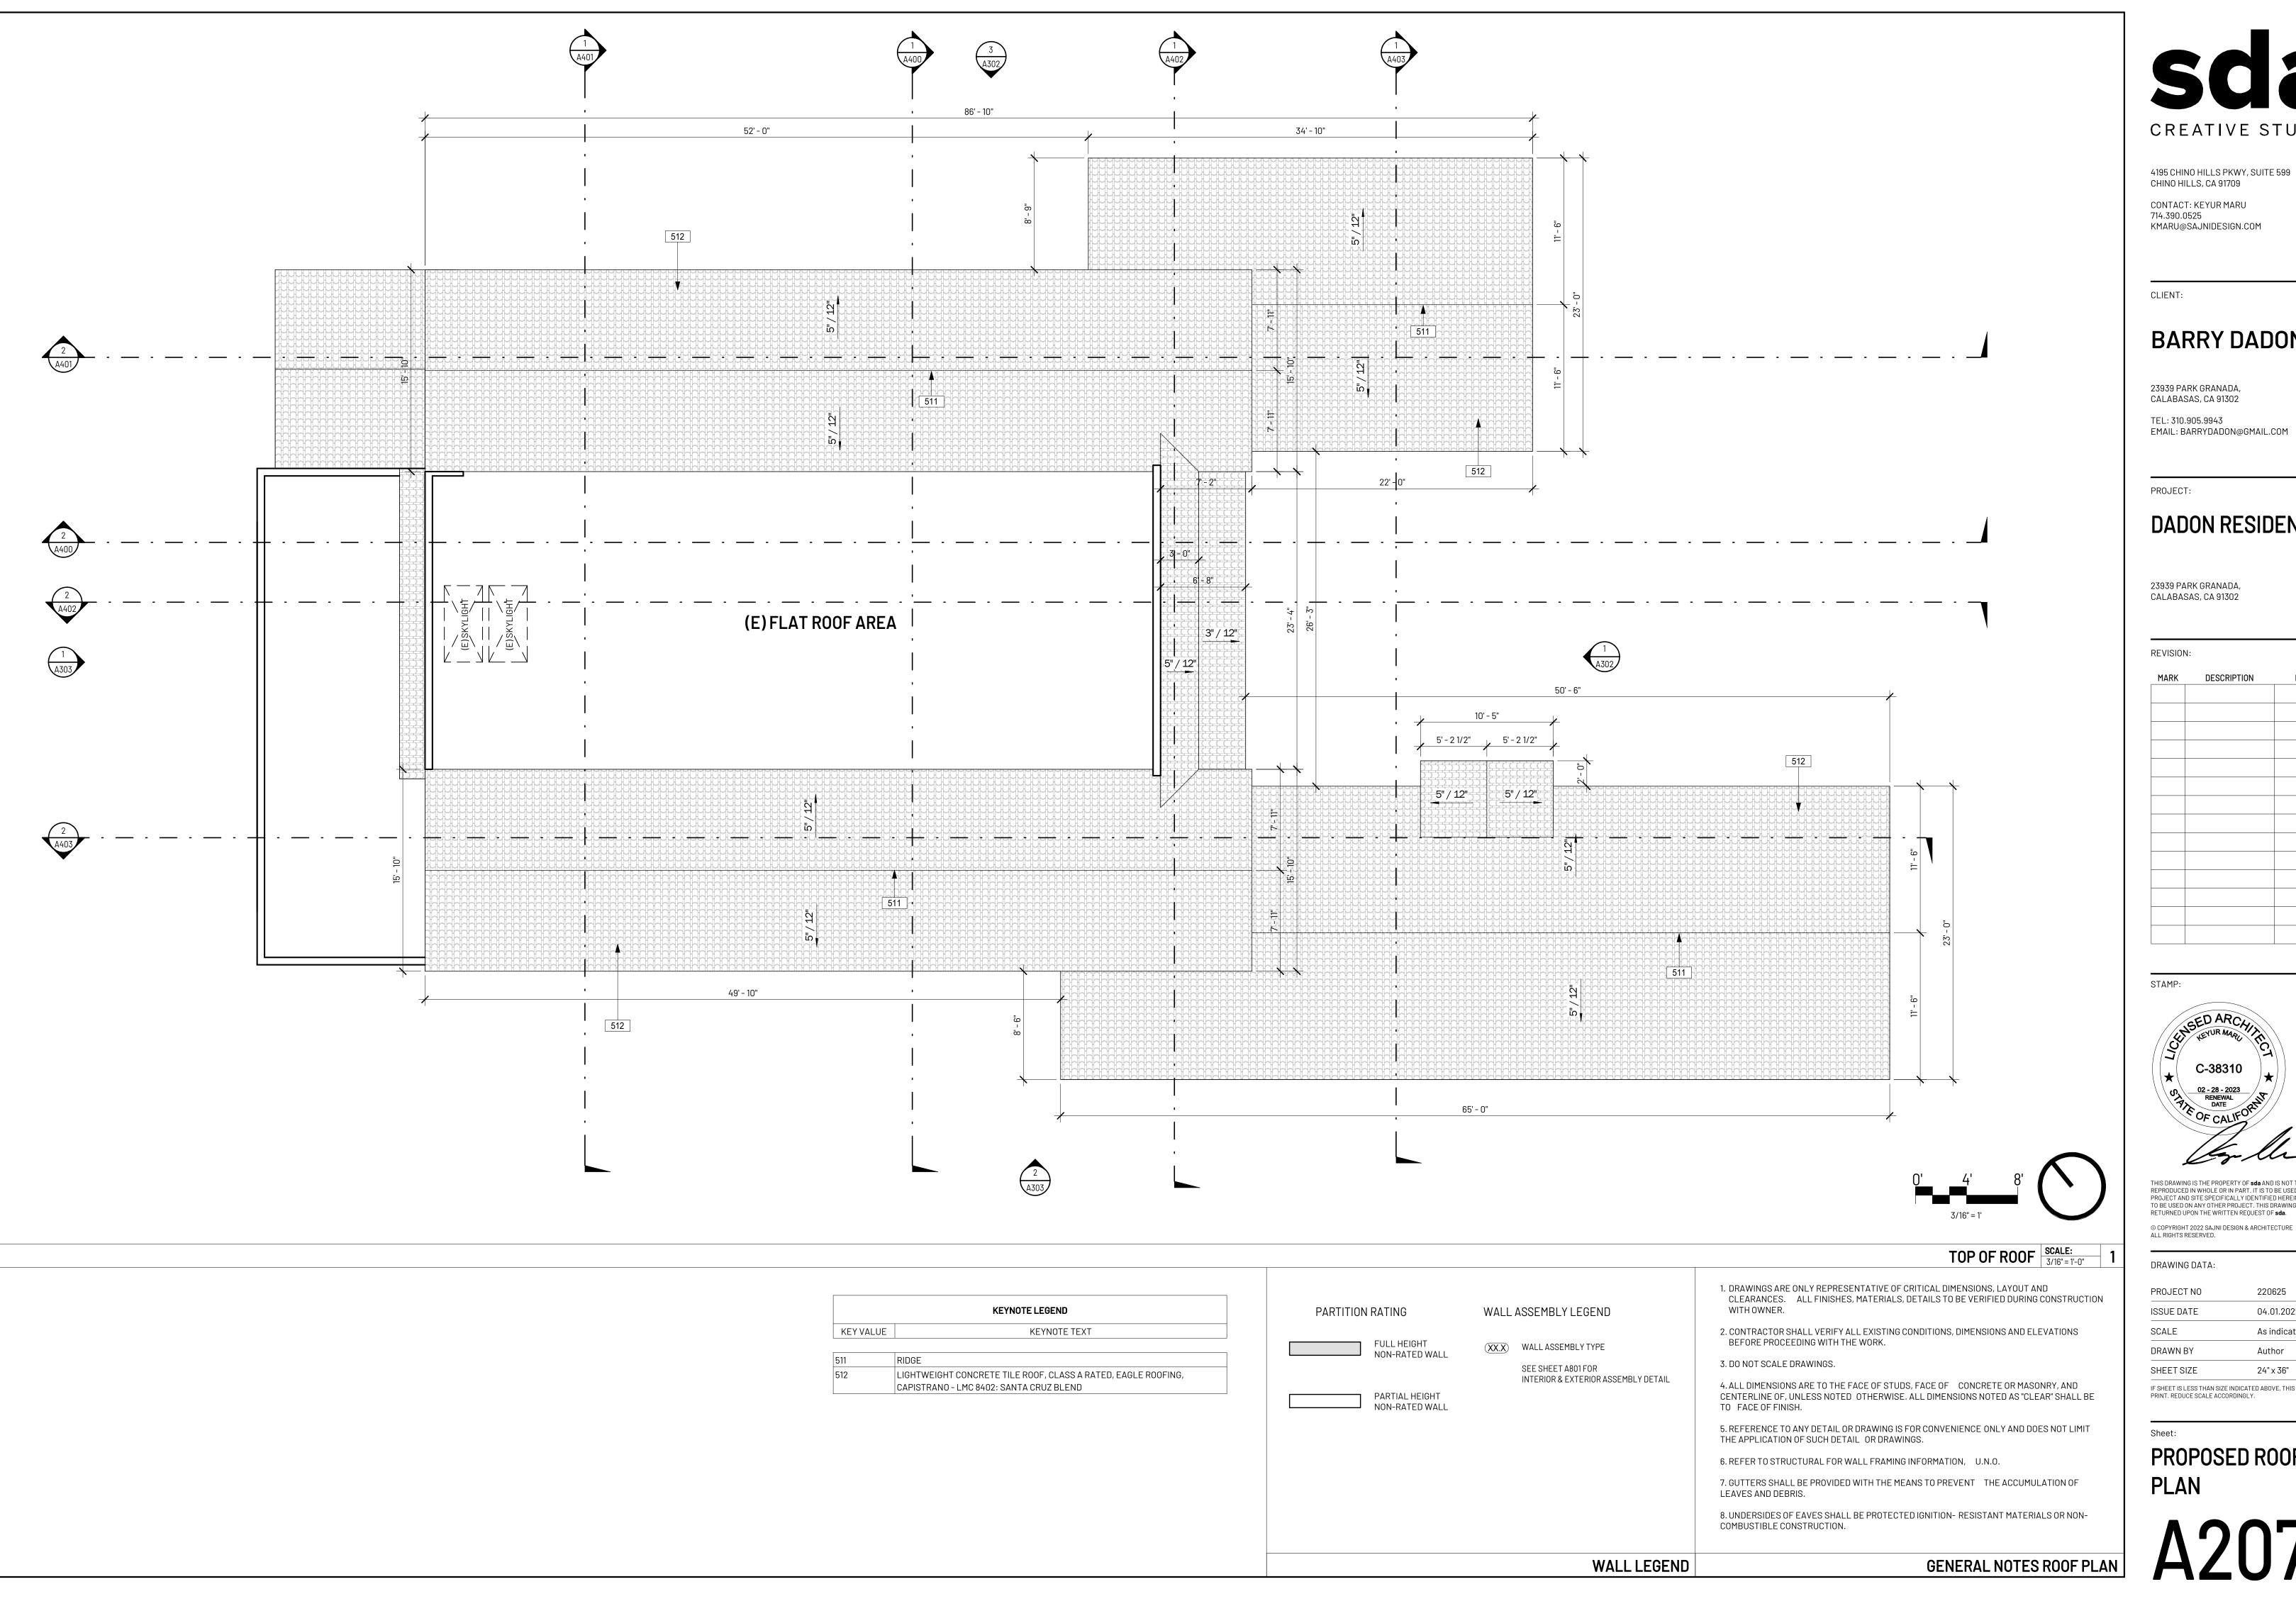

4195 CHINO HILLS PKWY, SUITE 599

CONTACT: KEYUR MARU 714.390.0525 KMARU@SAJNIDESIGN.COM

BARRY DADON

23939 PARK GRANADA,

TEL: 310.905.9943 EMAIL: BARRYDADON@GMAIL.COM

DADON RESIDENCE

23939 PARK GRANADA, CALABASAS, CA 91302

REVISION: MARK DESCRIPTION




REPRODUCED IN WHOLE OR IN PART. IT IS TO BE USED FOR THE PROJECT AND SITE SPECIFICALLY IDENTIFIED HEREIN AND IS NOT TO BE USED ON ANY OTHER PROJECT. THIS DRAWING IS TO BE RETURNED UPON THE WRITTEN REQUEST OF **sda**.

DRAWING DATA:	
PROJECT NO	220625
ISSUE DATE	04.01.2022
SCALE	As indicated
DRAWN BY	Author
SHEET SIZE	24" x 36"

IF SHEET IS LESS THAN SIZE INDICATED ABOVE, THIS IS A REDUCED PRINT. REDUCE SCALE ACCORDINGLY.

PROPOSED ROOF PLAN

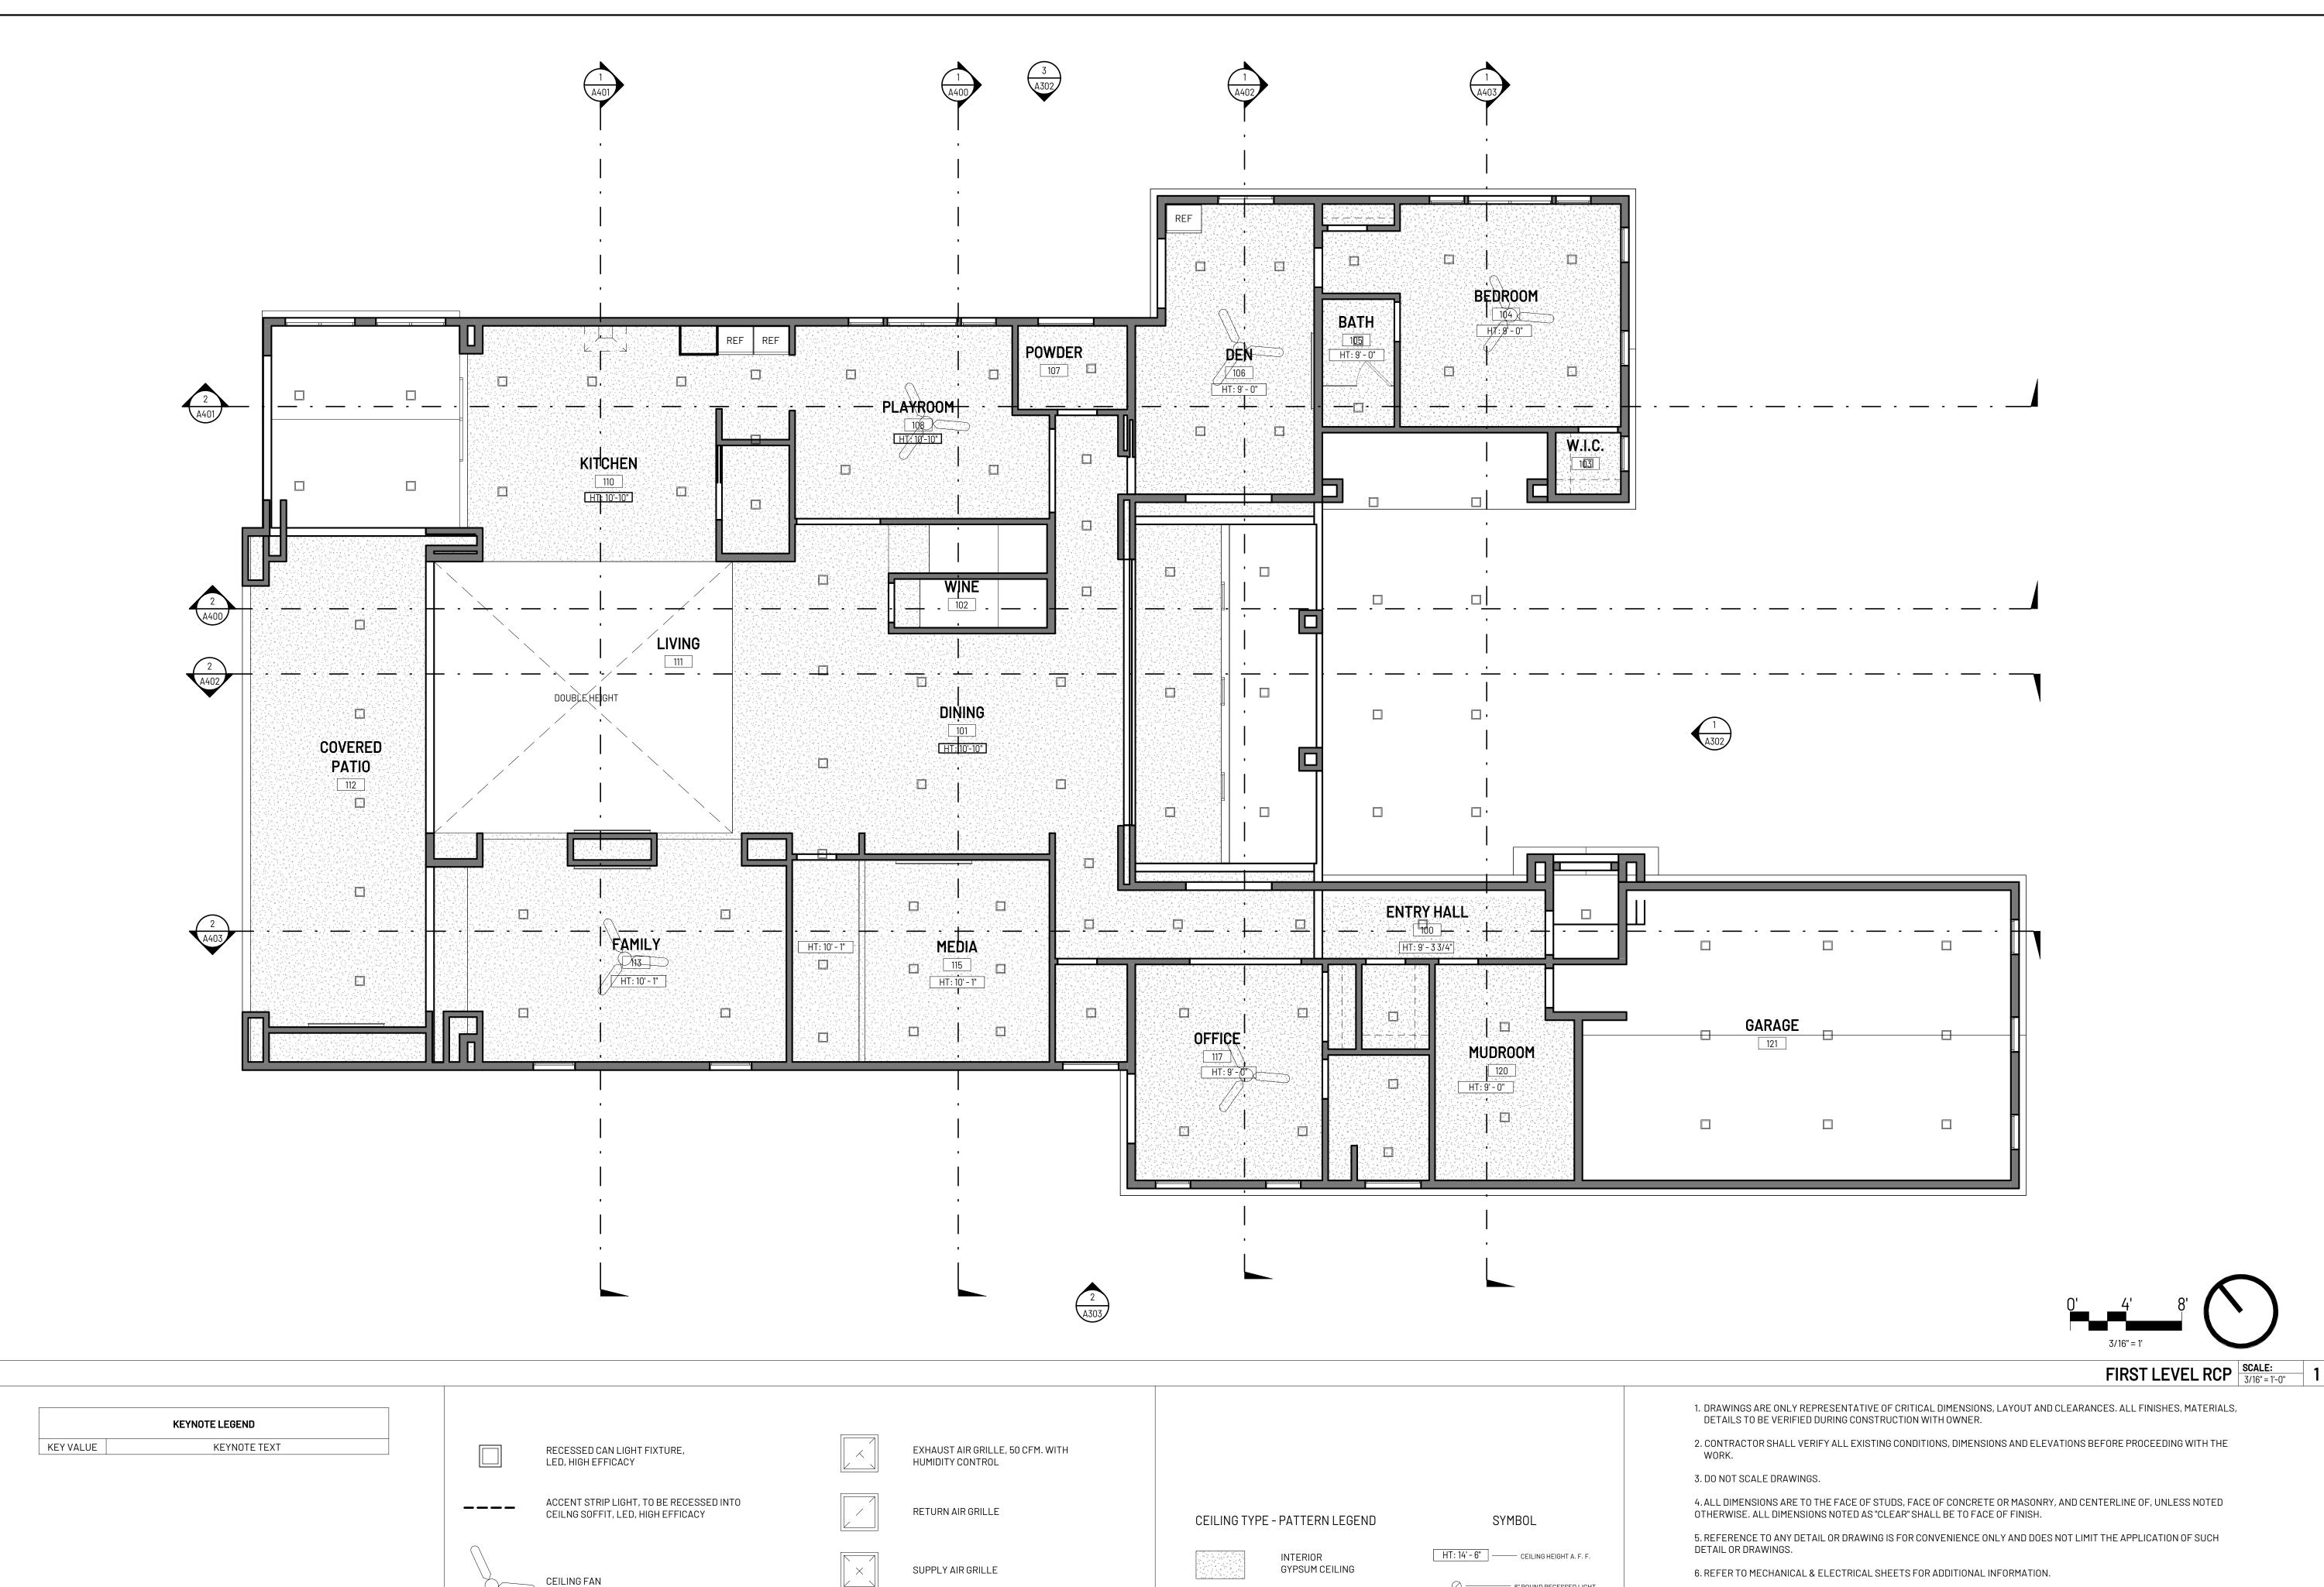

6" ROUND RECESSED LIGHT

RCP LEGEND

EXTERIOR

COMBO SMOKE AND CARBON MONOXIDE ALARM,

W/BATTERY BACK UP AND SHALL BE INSTALLED

RCP SYMBOL LEGEND

SHALL BE INTERCONNECTED HARD-WIRED

IN ACCORDANCE WITH NFPA 72

GYPSUM CEILING

BOARD CEILING

WOOD CEILING SLATS, ATTACHED TO GYPSUM

7. SMOKE ALARM SHALL BE PROVIDED IN AREAS LEADING TO BEDROOMS & WITHIN EACH BEDROOM IN BOTH NEW & EXISTING

8. EXHAUST FANS IN PRIVATE TOILET ROOMS SHALL PROVIDE A MINIMUM OF 50 CFM AND BE CONTROLLED BY A HUMIDISTAT.

GENERAL NOTES REFLECTED CEILING PLAN

9. PER CRC R315.3, CARBON MONOXIDE ALARMS SHALL BE LOCATED OUTSIDE OF EACH SLEEPING AREA IN IMMEDIATE

PORTION OF THE RESIDENCE @ AT EACH LEVEL.

FANS SHALL BE ENERGY STAR COMPLIANT AND BE DUCTED TO THE EXTERIOR

VICINITY OF BEDROOMS, ON EVERY LEVEL INCLUDING THE BASEMENT.

CREATIVE STUDIO

4195 CHINO HILLS PKWY, SUITE 599 CHINO HILLS, CA 91709

CONTACT: KEYUR MARU 714.390.0525 KMARU@SAJNIDESIGN.COM

BARRY DADON

23939 PARK GRANADA, CALABASAS, CA 91302

TEL: 310.905.9943 EMAIL: BARRYDADON@GMAIL.COM

PROJECT:

DADON RESIDENCE

23939 PARK GRANADA, CALABASAS, CA 91302

MARK	DESCRIPTION	D




REPRODUCED IN WHOLE OR IN PART. IT IS TO BE USED FOR THE PROJECT AND SITE SPECIFICALLY IDENTIFIED HEREIN AND IS NOT TO BE USED ON ANY OTHER PROJECT. THIS DRAWING IS TO BE RETURNED UPON THE WRITTEN REQUEST OF **sda**. © COPYRIGHT 2022 SAJNI DESIGN & ARCHITECTURE ALL RIGHTS RESERVED.

DRAWING DATA.

DRAWING DATA:	
PROJECT NO	220625
ISSUE DATE	04.01.2022
SCALE	As indicated
DRAWN BY	Author
OUEET 017E	24" v 36"

IF SHEET IS LESS THAN SIZE INDICATED ABOVE, THIS IS A REDUCED PRINT. REDUCE SCALE ACCORDINGLY.

PROPOSED FIRST FLOOR RCP

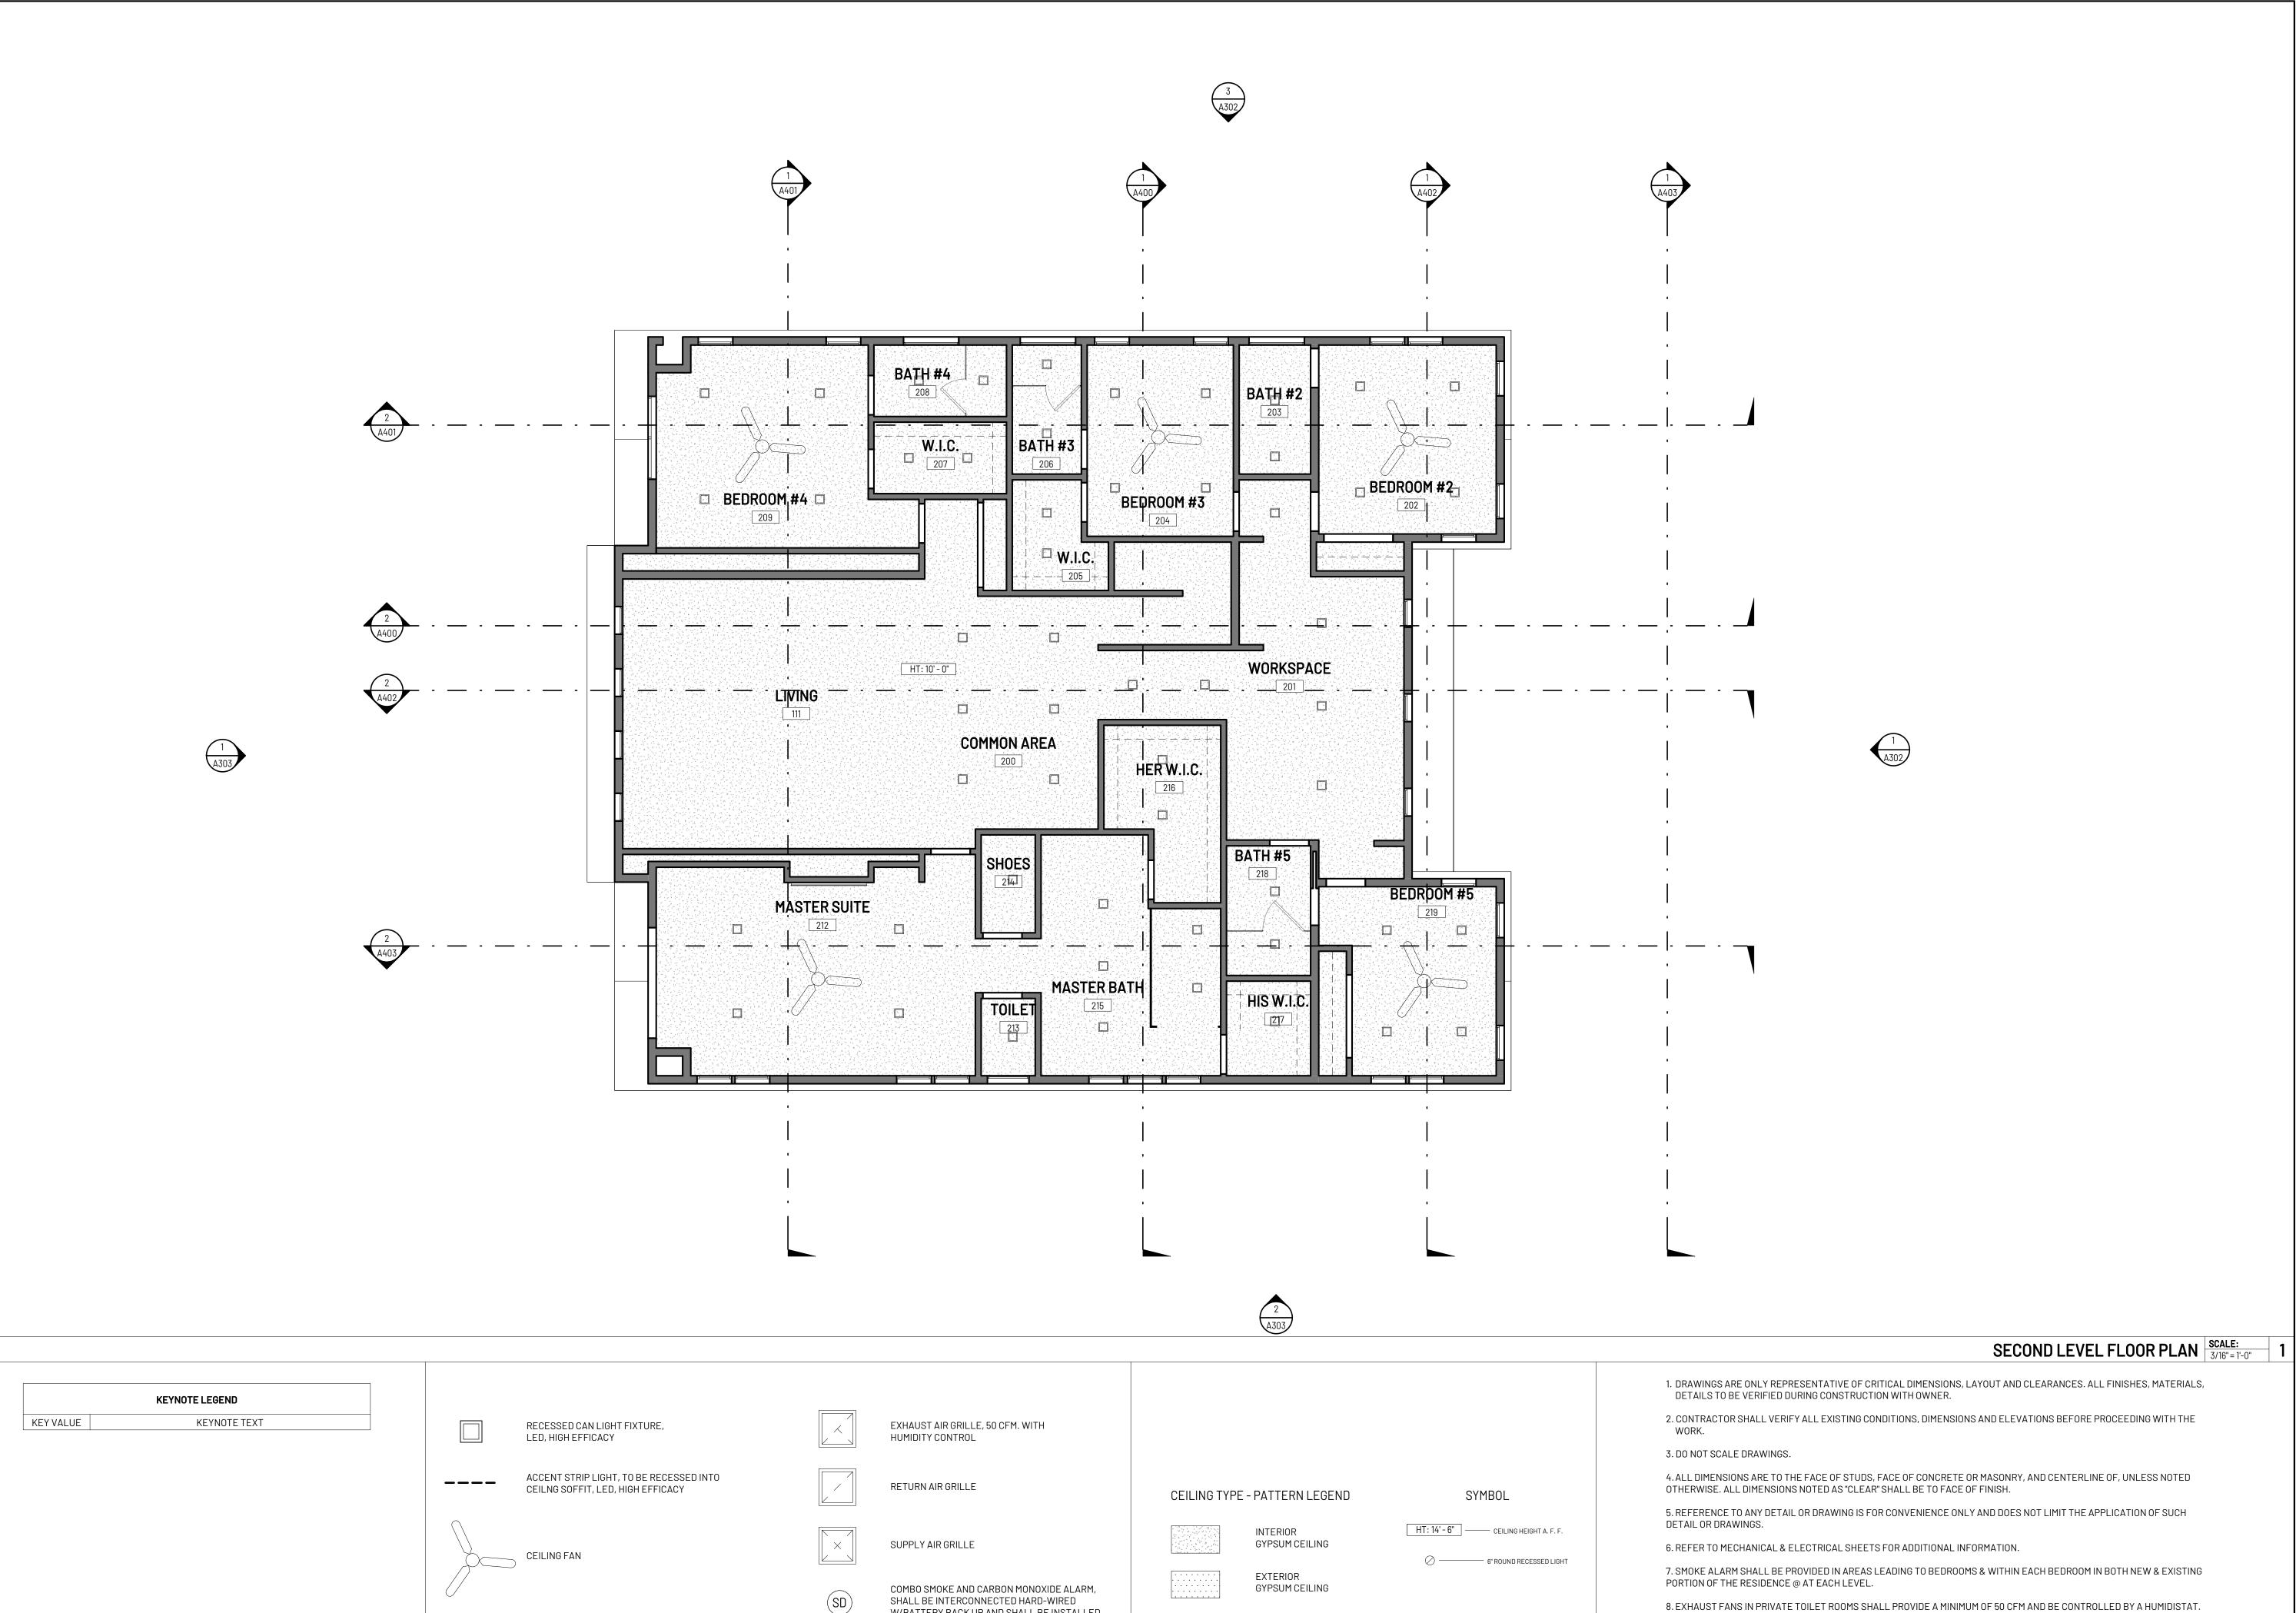

W/BATTERY BACK UP AND SHALL BE INSTALLED

RCP SYMBOL LEGEND

IN ACCORDANCE WITH NFPA 72

WOOD CEILING SLATS,

ATTACHED TO GYPSUM

RCP LEGEND

BOARD CEILING

CREATIVE STUDIO

4195 CHINO HILLS PKWY, SUITE 599 CHINO HILLS, CA 91709

CONTACT: KEYUR MARU 714.390.0525 KMARU@SAJNIDESIGN.COM

BARRY DADON

23939 PARK GRANADA, CALABASAS, CA 91302

TEL: 310.905.9943 EMAIL: BARRYDADON@GMAIL.COM

PROJECT:

DADON RESIDENCE

23939 PARK GRANADA, CALABASAS, CA 91302

REVISION	N:	
MARK	DESCRIPTION	DATE

STAMP:



REPRODUCED IN WHOLE OR IN PART. IT IS TO BE USED FOR THE PROJECT AND SITE SPECIFICALLY IDENTIFIED HEREIN AND IS NOT RETURNED UPON THE WRITTEN REQUEST OF **sda**. \odot COPYRIGHT 2022 SAJNI DESIGN & ARCHITECTURE ALL RIGHTS RESERVED.

DRAWING DATA:	

PROJECT NO	220625
ISSUE DATE	04.01.2022
SCALE	As indicated
DRAWN BY	Author
SHEET SIZE	24" x 36"

IF SHEET IS LESS THAN SIZE INDICATED ABOVE, THIS IS A REDUCED PRINT. REDUCE SCALE ACCORDINGLY.

FANS SHALL BE ENERGY STAR COMPLIANT AND BE DUCTED TO THE EXTERIOR

VICINITY OF BEDROOMS, ON EVERY LEVEL INCLUDING THE BASEMENT.

9. PER CRC R315.3, CARBON MONOXIDE ALARMS SHALL BE LOCATED OUTSIDE OF EACH SLEEPING AREA IN IMMEDIATE

GENERAL NOTES REFLECTED CEILING PLAN

PROPOSED SECOND FLOOR

TOP OF ROOF 27' - 6 1/2" SECOND FLOOR PLATE
21' - 6 1/2" EXISTING SECOND LEVEL PLAN FIRST FLOOR PLATE
10' - 10 3/4" EXISTING FIRST LEVEL PLAN GARAGE LEVEL EXISTING EAST ELEVATION SCALE: 1/4" = 1'-0" 2 TOP OF ROOF 27' - 6 1/2" SECOND FLOOR PLATE 21' - 6 1/2" EXISTING SECOND LEVEL PLAN 11' - 6 1/2" FIRST FLOOR PLATE 10' - 10 3/4" 1. DRAWINGS ARE ONLY REPRESENTATIVE OF CRITICAL DIMENSIONS, LAYOUT AND CLEARANCES. ALL FINISHES, MATERIALS, DETAILS TO BE VERIFIED DURING CONSTRUCTION 2. CONTRACTOR SHALL VERIFY ALL EXISTING CONDITIONS, DIMENSIONS AND ELEVATIONS EXISTING FIRST LEVEL PLAN

0' - 0"

GARAGE LEVEL

-1' - 4" BEFORE PROCEEDING WITH THE WORK. 3. DO NOT SCALE DRAWINGS. 4. ALL DIMENSIONS ARE TO THE FACE OF STUDS, FACE OF CONCRETE OR MASONRY, AND CENTERLINE OF, UNLESS NOTED OTHERWISE. ALL DIMENSIONS NOTED AS "CLEAR" SHALL BE TO FACE OF FINISH. 5. REFERENCE TO ANY DETAIL OR DRAWING IS FOR CONVENIENCE ONLY AND DOES NOT LIMIT THE APPLICATION OF SUCH DETAIL OR DRAWINGS. 6. REFER TO STRUCTURAL FOR WALL FRAMING INFORMATION, U.N.O. 7. GUTTERS SHALL BE PROVIDED WITH THE MEANS TO PREVENT THE ACCUMULATION OF LEAVES AND DEBRIS.

KEYNOTE LEGEND KEYNOTE TEXT KEY VALUE

8. UNDERSIDES OF EAVES SHALL BE PROTECTED IGNITION- RESISTANT MATERIALS OR NON-

ELEVATION GENERAL NOTES

COMBUSTIBLE CONSTRUCTION.

EXISTING NORTH ELEVATION SCALE: 1/4" = 1'-0" 1

CREATIVE STUDIO

4195 CHINO HILLS PKWY, SUITE 599 CHINO HILLS, CA 91709

CONTACT: KEYUR MARU 714.390.0525 KMARU@SAJNIDESIGN.COM

BARRY DADON

23939 PARK GRANADA,

CALABASAS, CA 91302

TEL: 310.905.9943 EMAIL: BARRYDADON@GMAIL.COM

PROJECT:

DADON RESIDENCE

23939 PARK GRANADA, CALABASAS, CA 91302

REVISION:		
MARK	DESCRIPTION	DATE



REPRODUCED IN WHOLE OR IN PART. IT IS TO BE USED FOR THE PROJECT AND SITE SPECIFICALLY IDENTIFIED HEREIN AND IS NOT TO BE USED ON ANY OTHER PROJECT. THIS DRAWING IS TO BE RETURNED UPON THE WRITTEN REQUEST OF **sda**. © COPYRIGHT 2022 SAJNI DESIGN & ARCHITECTURE ALL RIGHTS RESERVED.

DRAWING DATA:	
PROJECT NO	220625
ISSUE DATE	04.01.2022
SCALE	As indicated
DRAWN BY	Author

IF SHEET IS LESS THAN SIZE INDICATED ABOVE, THIS IS A REDUCED PRINT. REDUCE SCALE ACCORDINGLY.

SHEET SIZE

EXISTING ELEVATIONS



KEYNOTE LEGEND KEYNOTE TEXT KEY VALUE

CREATIVE STUDIO

4195 CHINO HILLS PKWY, SUITE 599 CHINO HILLS, CA 91709

CONTACT: KEYUR MARU 714.390.0525 KMARU@SAJNIDESIGN.COM

BARRY DADON

23939 PARK GRANADA, CALABASAS, CA 91302

TEL: 310.905.9943 EMAIL: BARRYDADON@GMAIL.COM

PROJECT:

DADON RESIDENCE

23939 PARK GRANADA, CALABASAS, CA 91302

REVISION: MARK DESCRIPTION



REPRODUCED IN WHOLE OR IN PART. IT IS TO BE USED FOR THE PROJECT AND SITE SPECIFICALLY IDENTIFIED HEREIN AND IS NOT TO BE USED ON ANY OTHER PROJECT. THIS DRAWING IS TO BE RETURNED UPON THE WRITTEN REQUEST OF **sda**. \odot COPYRIGHT 2022 SAJNI DESIGN & ARCHITECTURE ALL RIGHTS RESERVED.

DRAWING DATA:

PROJECT NO	220625
ISSUE DATE	04.01.2022
SCALE	As indicated
DRAWN BY	Author
CHEET SIZE	2/ _" v 36"

IF SHEET IS LESS THAN SIZE INDICATED ABOVE, THIS IS A REDUCED PRINT. REDUCE SCALE ACCORDINGLY.

EXISTING ELEVATIONS


6. REFER TO STRUCTURAL FOR WALL FRAMING INFORMATION, U.N.O.

EXISTING SOUTH ELEVATION SCALE: 1/4" = 1'-0" 1

7. GUTTERS SHALL BE PROVIDED WITH THE MEANS TO PREVENT THE ACCUMULATION OF LEAVES AND DEBRIS.

8. UNDERSIDES OF EAVES SHALL BE PROTECTED IGNITION- RESISTANT MATERIALS OR NON-COMBUSTIBLE CONSTRUCTION.

ELEVATION GENERAL NOTES

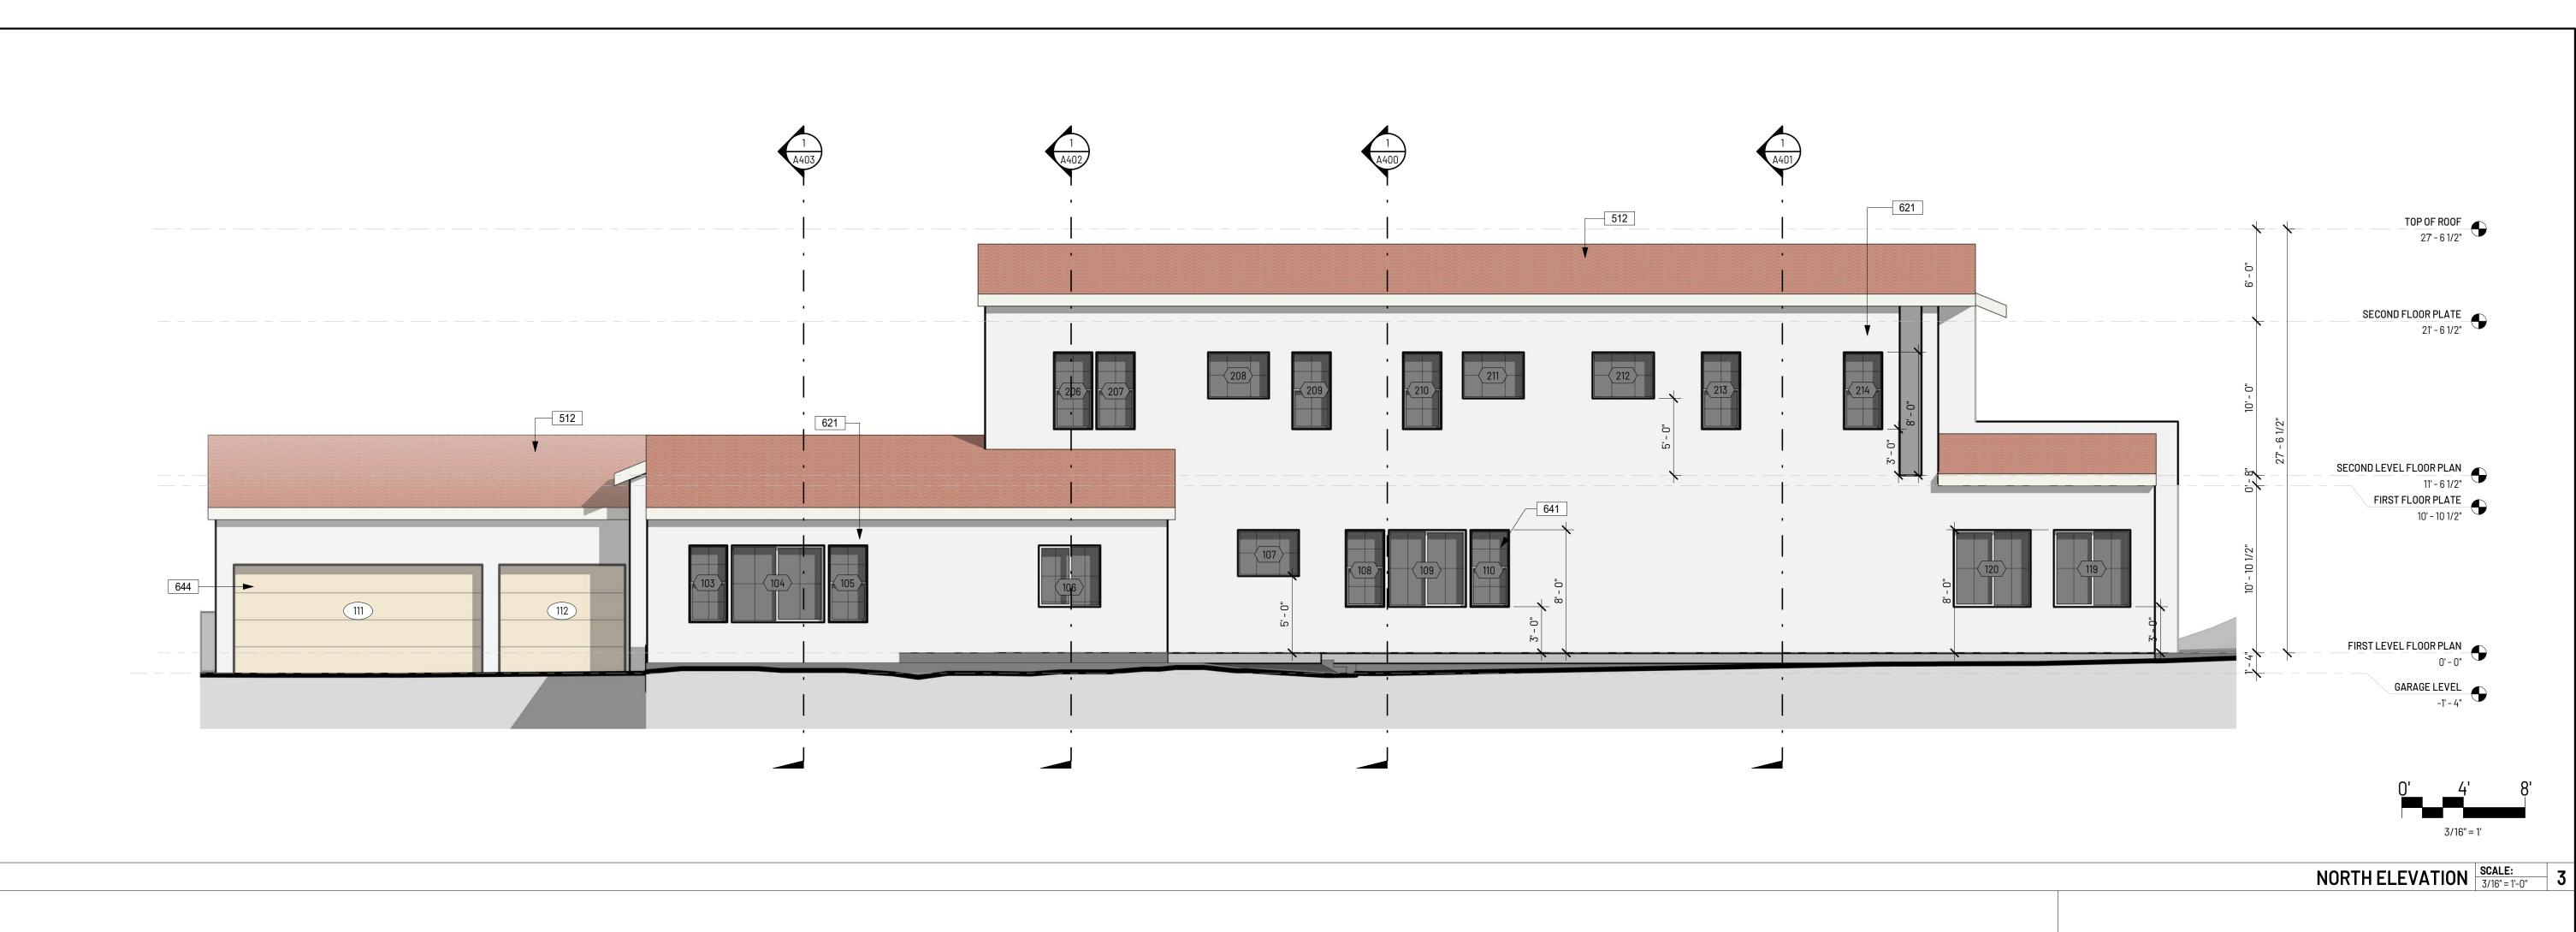



	KEYNOTE LEGEND
KEY VALUE	KEYNOTE TEXT
512	LIGHTWEIGHT CONCRETE TILE ROOF, CLASS A RATED, EAGLE ROOFING, CAPISTRANO - LMC 8402: SANTA CRUZ BLEND
621	EXTERIOR STUCCO, ACRYLIC SMOOTH SAND-FINISH, COLOR: BENJAMIN MOORE - CLOUD WHITE
641	ALUMINUM WINDOW, LOW-E, DUAL PANE GLASS, MATTE BLACK METAL FRAME, REFER TO WINDOW SCHEDULE
644	GARAGE DOOR, BLEACHED WOOD FINISH DOORS WITH BLACK METAL FRAME, PER MFR SPECS
667	EXTERIOR DOUBLE SWING GATE, BLEACHED WOOD FINISH DOORS WITH BLACK METAL FRAME, PER MFR SPECS

- 1. DRAWINGS ARE ONLY REPRESENTATIVE OF CRITICAL DIMENSIONS, LAYOUT AND CLEARANCES. ALL FINISHES, MATERIALS, DETAILS TO BE VERIFIED DURING CONSTRUCTION WITH OWNER.
- 2. CONTRACTOR SHALL VERIFY ALL EXISTING CONDITIONS, DIMENSIONS AND ELEVATIONS BEFORE PROCEEDING WITH THE WORK.
- 3. DO NOT SCALE DRAWINGS.
- 4. ALL DIMENSIONS ARE TO THE FACE OF STUDS, FACE OF CONCRETE OR MASONRY, AND CENTERLINE OF, UNLESS NOTED OTHERWISE. ALL DIMENSIONS NOTED AS "CLEAR" SHALL BE TO FACE OF FINISH.
- 5. REFERENCE TO ANY DETAIL OR DRAWING IS FOR CONVENIENCE ONLY AND DOES NOT LIMIT THE APPLICATION OF SUCH DETAIL OR DRAWINGS.
- 6. REFER TO STRUCTURAL FOR WALL FRAMING INFORMATION, U.N.O.
- 7. GUTTERS SHALL BE PROVIDED WITH THE MEANS TO PREVENT THE ACCUMULATION OF LEAVES AND DEBRIS.
- 8. UNDERSIDES OF EAVES SHALL BE PROTECTED IGNITION- RESISTANT MATERIALS OR NON-COMBUSTIBLE CONSTRUCTION.

EAST ELEVATION SCALE: 3/16" = 1'-0" 1 ELEVATION GENERAL NOTES

SCIA

CREATIVE STUDIO

4195 CHINO HILLS PKWY, SUITE 599 CHINO HILLS, CA 91709

CONTACT: KEYUR MARU 714.390.0525 KMARU@SAJNIDESIGN.COM

CLIENT:

BARRY DADON

23939 PARK GRANADA,

CALABASAS, CA 91302

TEL: 310.905.9943 EMAIL: BARRYDADON@GMAIL.COM

PROJECT:

DADON RESIDENCE

23939 PARK GRANADA, CALABASAS, CA 91302

MARK	DESCRIPTION	
		1

TAMB



THIS DRAWING IS THE PROPERTY OF **sda** AND IS NOT TO BE REPRODUCED IN WHOLE OR IN PART. IT IS TO BE USED FOR THE PROJECT AND SITE SPECIFICALLY IDENTIFIED HEREIN AND IS NOT TO BE USED ON ANY OTHER PROJECT. THIS DRAWING IS TO BE RETURNED UPON THE WRITTEN REQUEST OF **sda**.

.....

 \odot COPYRIGHT 2022 SAJNI DESIGN & ARCHITECTURE ALL RIGHTS RESERVED.


DRAWING DATA:	
PROJECT NO	220625
ISSUE DATE	04.01.2022
SCALE	As indicated
DRAWN BY	Author

IF SHEET IS LESS THAN SIZE INDICATED ABOVE, THIS IS A REDUCED PRINT. REDUCE SCALE ACCORDINGLY.


SHEET SIZE

PROPOSED ELEVATIONS



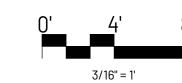

SOUTH ELEVATION SCALE: 3/16" = 1'-0" 2

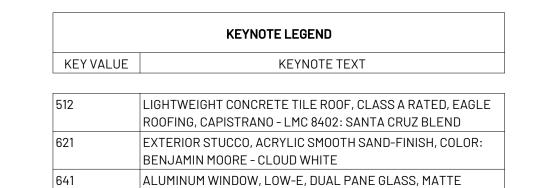

BLACK METAL FRAME, REFER TO WINDOW SCHEDULE

1. DRAWINGS ARE ONLY REPRESENTATIVE OF CRITICAL DIMENSIONS, LAYOUT AND CLEARANCES. ALL FINISHES, MATERIALS, DETAILS TO BE VERIFIED DURING CONSTRUCTION

2. CONTRACTOR SHALL VERIFY ALL EXISTING CONDITIONS, DIMENSIONS AND ELEVATIONS BEFORE PROCEEDING WITH THE WORK.

3. DO NOT SCALE DRAWINGS.

4. ALL DIMENSIONS ARE TO THE FACE OF STUDS, FACE OF CONCRETE OR MASONRY, AND CENTERLINE OF, UNLESS NOTED OTHERWISE. ALL DIMENSIONS NOTED AS "CLEAR" SHALL BE TO FACE OF FINISH.

5. REFERENCE TO ANY DETAIL OR DRAWING IS FOR CONVENIENCE ONLY AND DOES NOT LIMIT THE APPLICATION OF SUCH DETAIL OR DRAWINGS.

6. REFER TO STRUCTURAL FOR WALL FRAMING INFORMATION, U.N.O.

7. GUTTERS SHALL BE PROVIDED WITH THE MEANS TO PREVENT THE ACCUMULATION OF LEAVES AND DEBRIS.

8. UNDERSIDES OF EAVES SHALL BE PROTECTED IGNITION- RESISTANT MATERIALS OR NON-COMBUSTIBLE CONSTRUCTION.

 WEST ELEVATION
 SCALE: 3/16" = 1'-0"
 1

TOP OF ROOF 27' - 6 1/2"

SECOND FLOOR PLATE
21' - 6 1/2"

SECOND LEVEL FLOOR PLAN

621

621

FIRST FLOOR PLATE
10' - 10 1/2"

FIRST LEVEL FLOOR PLAN

ELEVATION GENERAL NOTES

SCI CREATIVE STUDIO

4195 CHINO HILLS PKWY, SUITE 599 CHINO HILLS, CA 91709

CONTACT: KEYUR MARU 714.390.0525 KMARU@SAJNIDESIGN.COM

CLIENT:

BARRY DADON

23939 PARK GRANADA, CALABASAS, CA 91302

TEL: 310.905.9943 EMAIL: BARRYDADON@GMAIL.COM

PROJECT:

DADON RESIDENCE

23939 PARK GRANADA, CALABASAS, CA 91302

MARK DESCRIPTION DATE



THIS DRAWING IS THE PROPERTY OF **sda** AND IS NOT TO BE REPRODUCED IN WHOLE OR IN PART. IT IS TO BE USED FOR THE PROJECT AND SITE SPECIFICALLY IDENTIFIED HEREIN AND IS NOT TO BE USED ON ANY OTHER PROJECT. THIS DRAWING IS TO BE RETURNED UPON THE WRITTEN REQUEST OF **sda**.

© COPYRIGHT 2022 SAJNI DESIGN & ARCHITECTURE ALL RIGHTS RESERVED.


DRAWING DATA:


PROJECT NO	220625
ISSUE DATE	04.01.2022
SCALE	As indicated
DRAWN BY	Author

IF SHEET IS LESS THAN SIZE INDICATED ABOVE, THIS IS A REDUCED PRINT. REDUCE SCALE ACCORDINGLY.

SHEET SIZE

PROPOSED ELEVATIONS

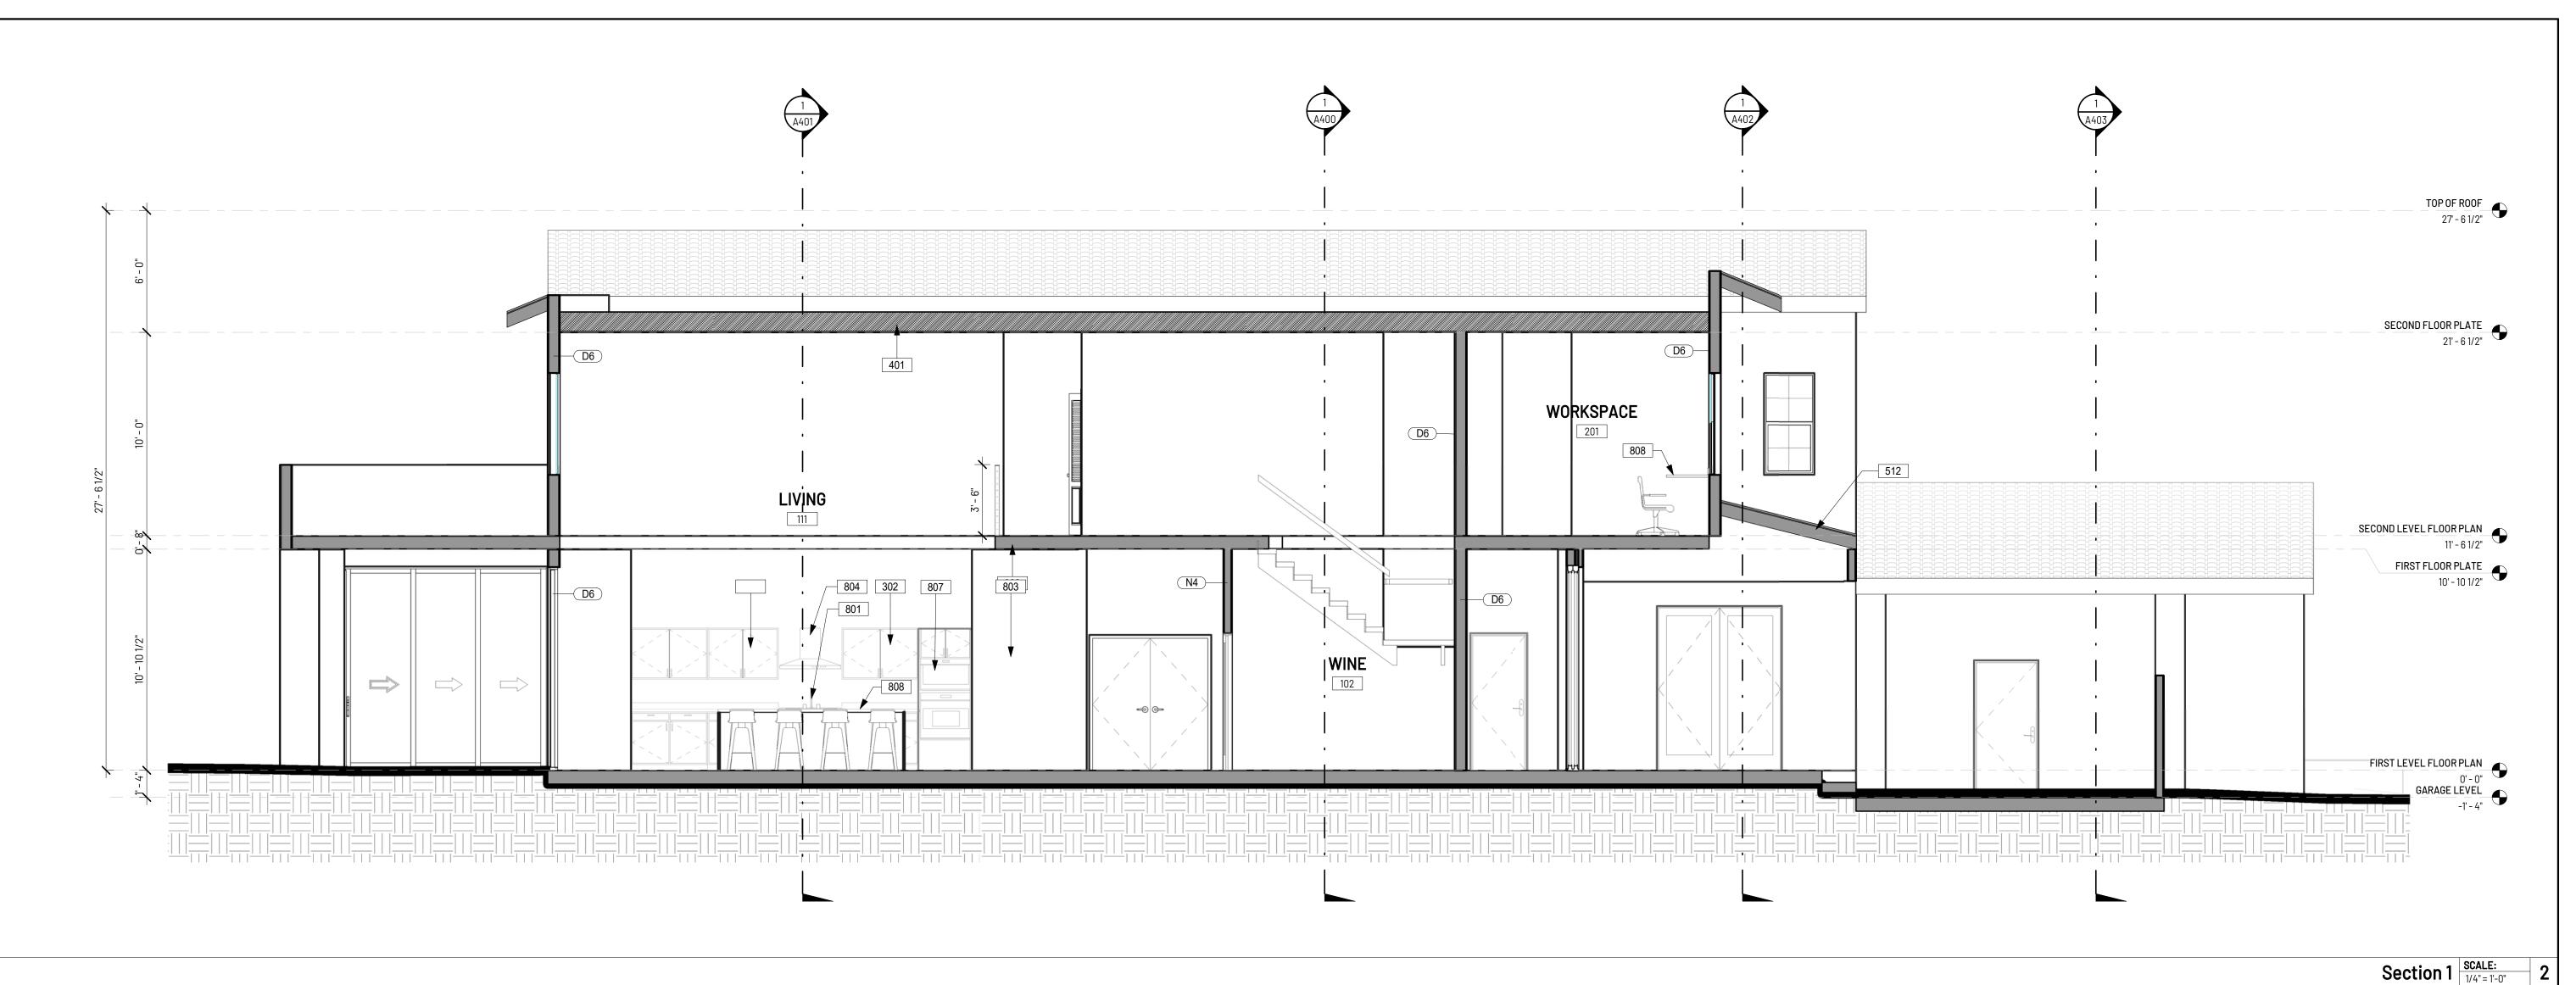

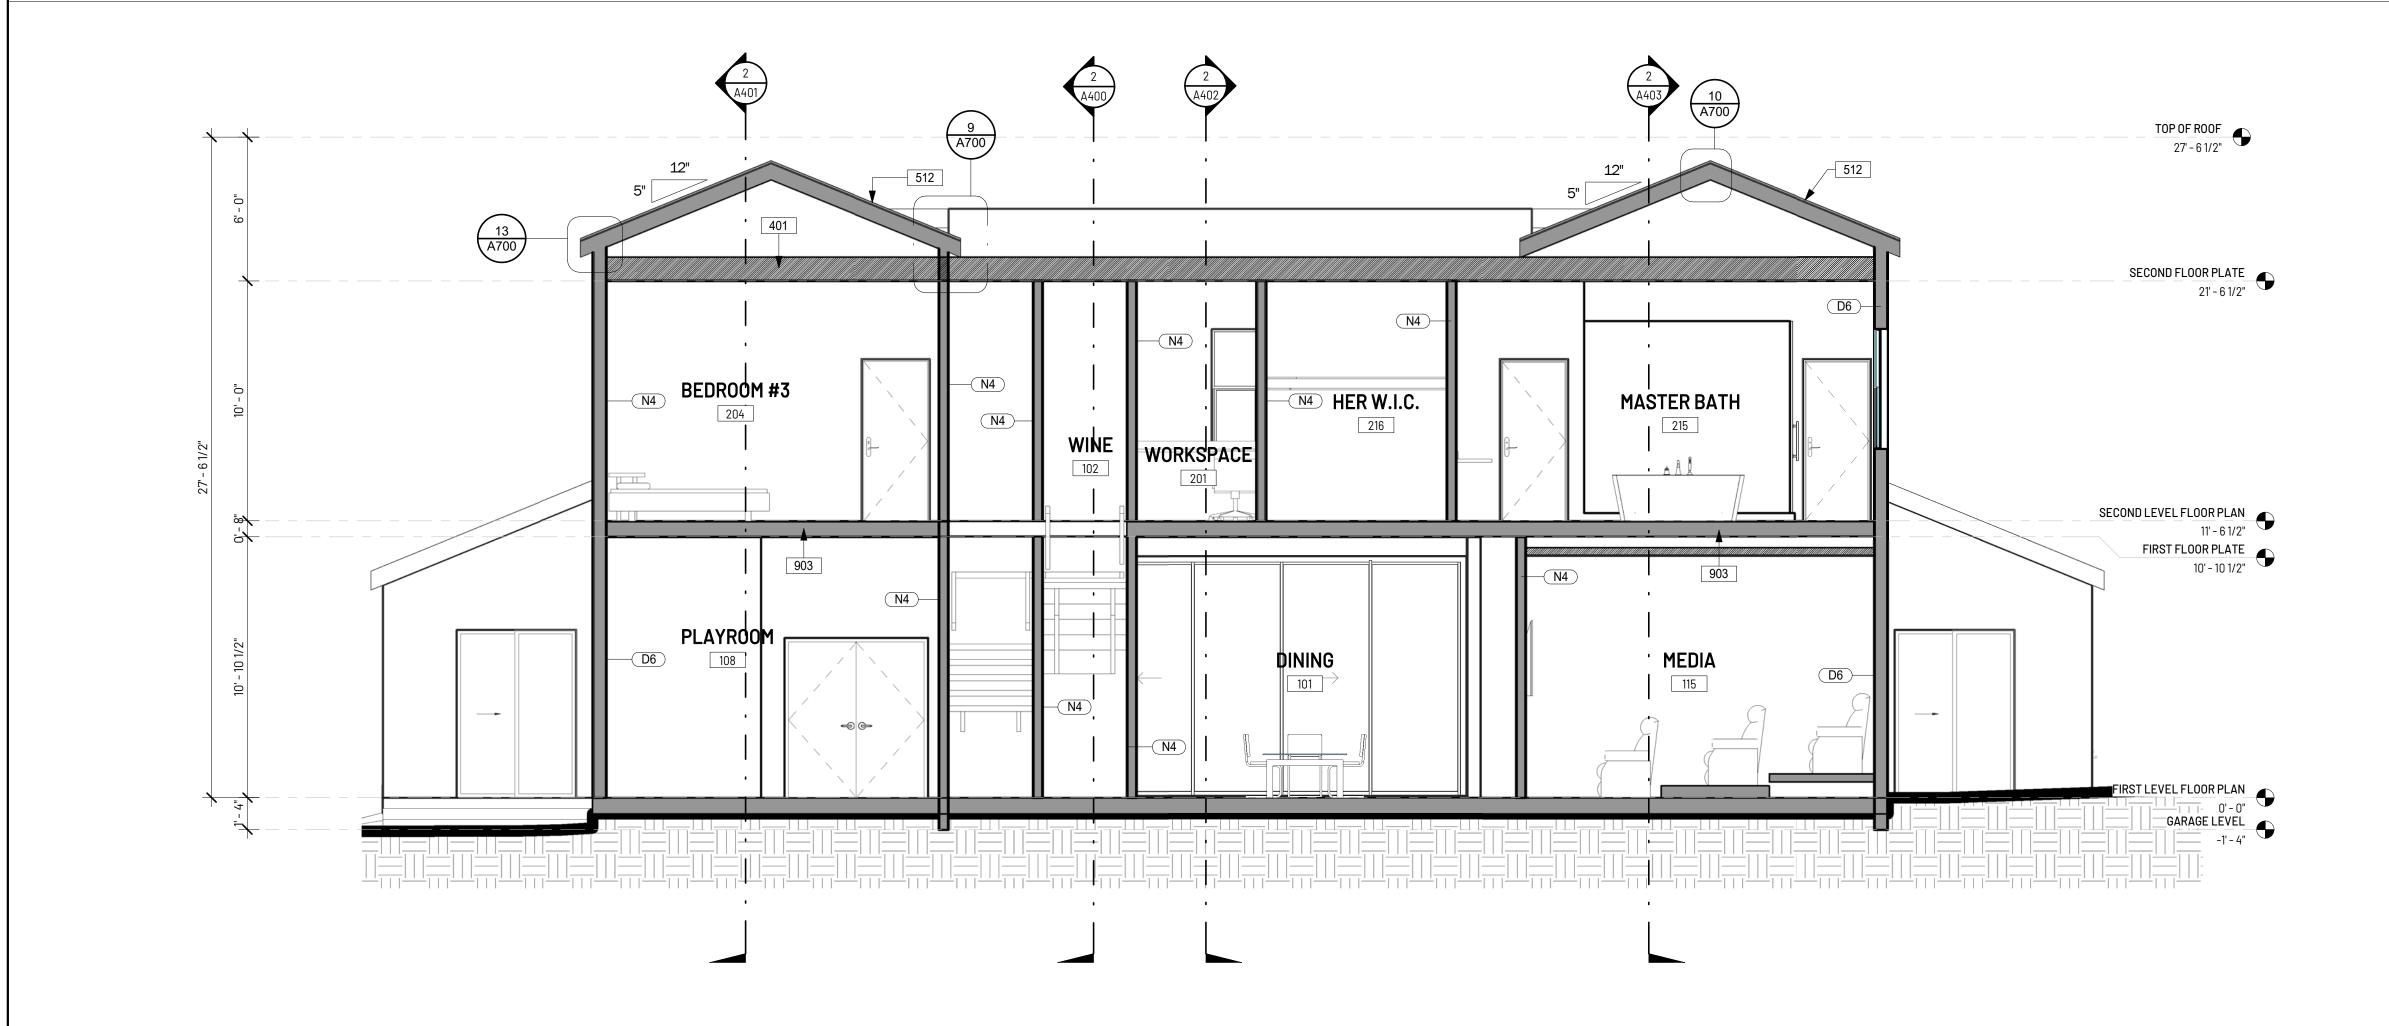

KEYNOTE LEGEND		
KEY VALUE	KEYNOTE TEXT	
302	BUILT-IN CABINETS, UPPERS SHOWN DASHED	
401	5/8" TYPE X GYP. BOARD AT CEILING	
512	LIGHTWEIGHT CONCRETE TILE ROOF, CLASS A RATED, EAGLE	
	ROOFING, CAPISTRANO - LMC 8402: SANTA CRUZ BLEND	
801	KITCHEN SINK W/ GARBAGE DISPOSAL	
803	REFRIGERATOR, OWNER SELECTED. ROUGH PLUMBING PER	
	MANUF. SPECIFICATIONS	
804	BUILT-IN RANGE EXHAUST HOOD, MIN. 100 CFM, OWNER	
	SELECTED	
807	MICROWAVE, OWNER SELECTED	
808	COUNTERTOP	
903	FLOOR FRAMING, SEE STRUCTURAL, PROVIDE INSULATION PER	
	SCHEDULE	

Section 2 SCALE: 1/4"= 1'-0" 1

CREATIVE STUDIO

4195 CHINO HILLS PKWY, SUITE 599 CHINO HILLS, CA 91709

CONTACT: KEYUR MARU 714.390.0525 KMARU@SAJNIDESIGN.COM

BARRY DADON

23939 PARK GRANADA, CALABASAS, CA 91302

TEL: 310.905.9943 EMAIL: BARRYDADON@GMAIL.COM

DADON RESIDENCE

23939 PARK GRANADA, CALABASAS, CA 91302

REVISION:

MARK	DESCRIPTION	DATE



THIS DRAWING IS THE PROPERTY OF **sda** AND IS NOT TO BE REPRODUCED IN WHOLE OR IN PART. IT IS TO BE USED FOR THE PROJECT AND SITE SPECIFICALLY IDENTIFIED HEREIN AND IS NOT TO BE USED ON ANY OTHER PROJECT. THIS DRAWING IS TO BE RETURNED UPON THE WRITTEN REQUEST OF **sda**. © COPYRIGHT 2022 SAJNI DESIGN & ARCHITECTURE ALL RIGHTS RESERVED.


DRAWING DATA:

PROJECT NO	220625
ISSUE DATE	04.01.2022
SCALE	1/4" = 1'-0"
DRAWN BY	Author
SHEET SIZE	24" x 36"

IF SHEET IS LESS THAN SIZE INDICATED ABOVE, THIS IS A REDUCED PRINT. REDUCE SCALE ACCORDINGLY.

PROPOSED SECTIONS



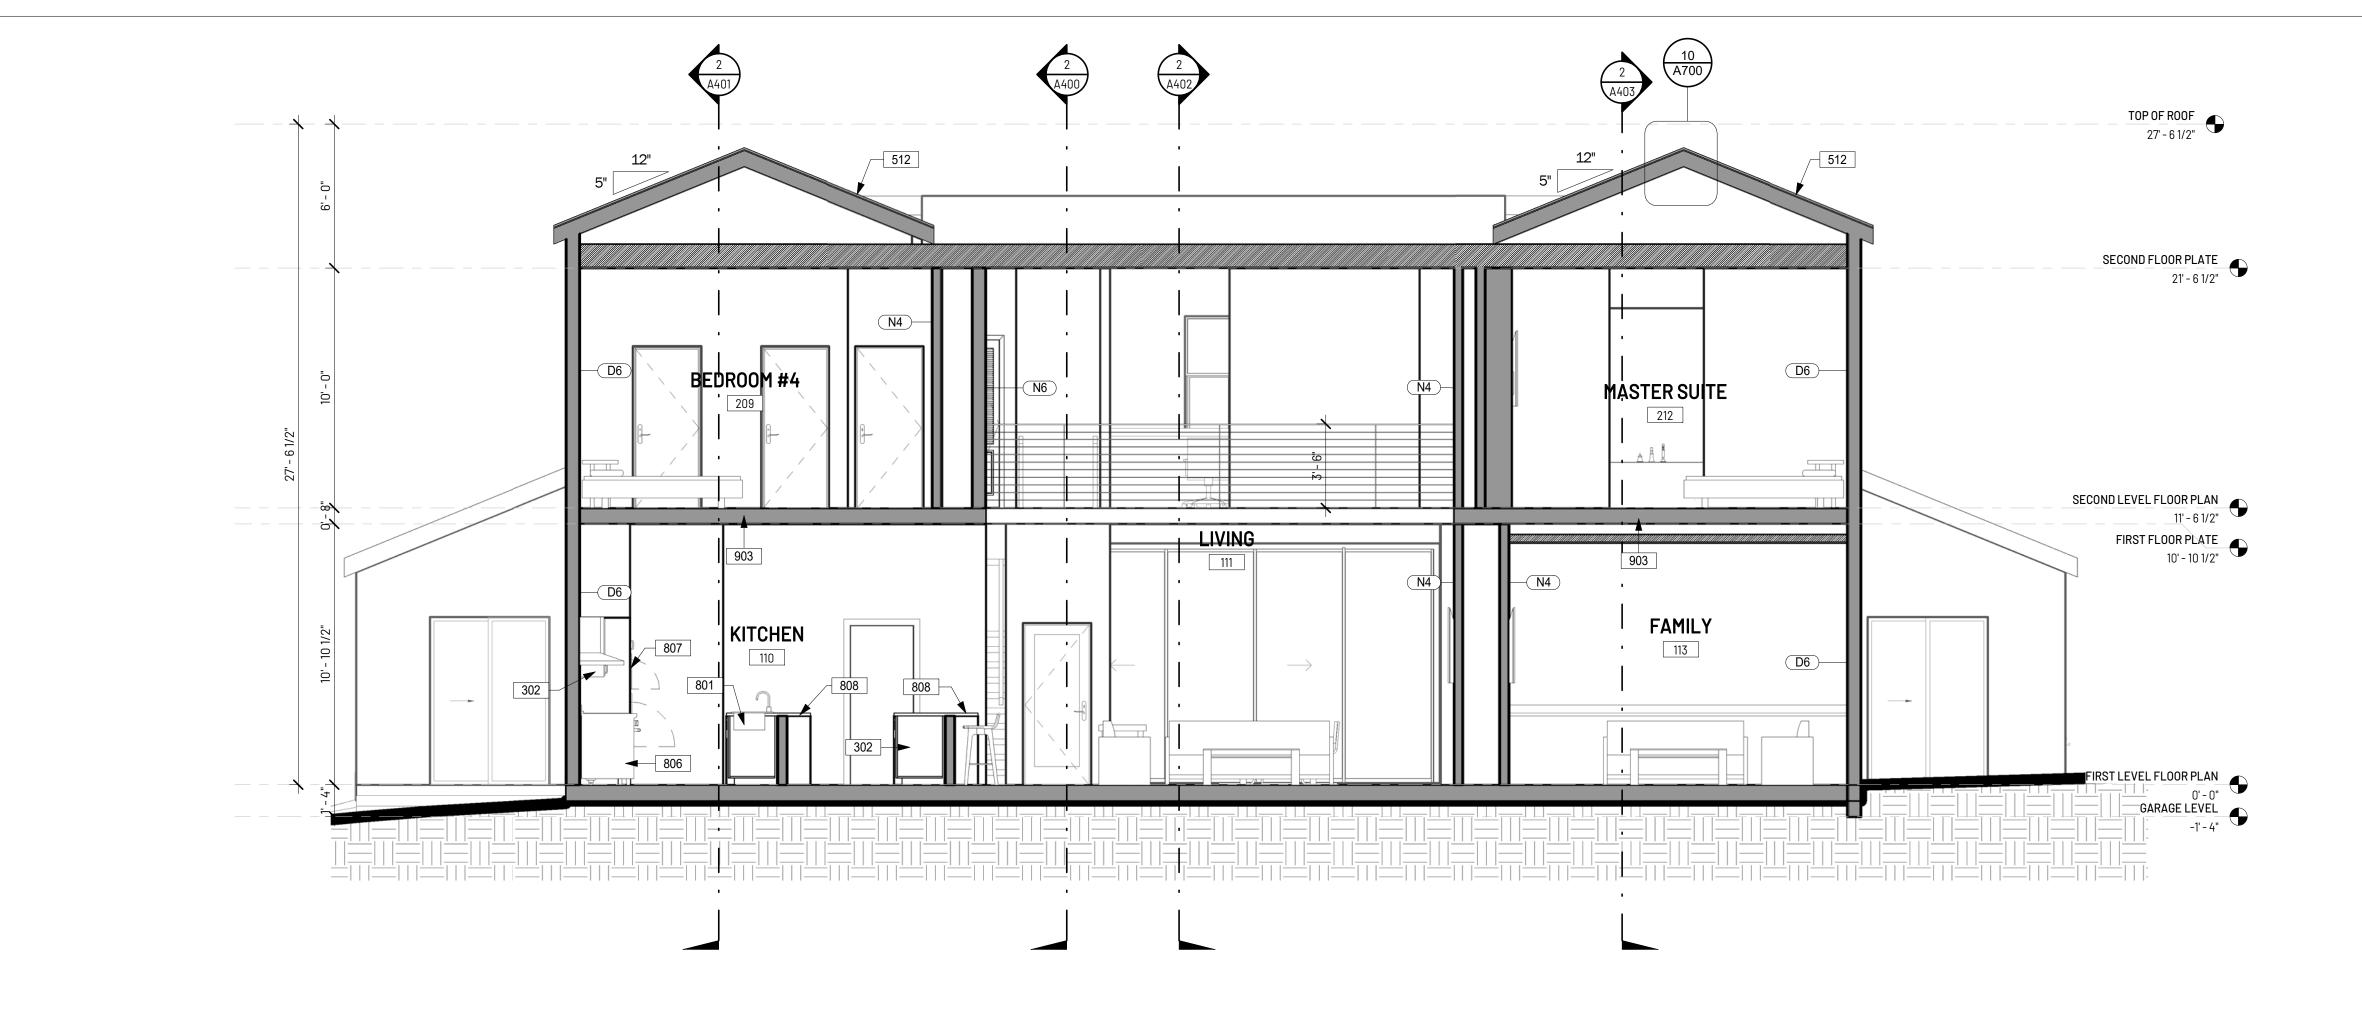

	Section 3
	KEYNOTE LEGEND
KEY VALUE	KEYNOTE TEXT
301	BUILT-IN CLOSET SHELF & ROD
302	BUILT-IN CABINETS, UPPERS SHOWN DASHED
512	LIGHTWEIGHT CONCRETE TILE ROOF, CLASS A RATED, EAGL ROOFING, CAPISTRANO - LMC 8402: SANTA CRUZ BLEND
801	KITCHEN SINK W/ GARBAGE DISPOSAL
803	REFRIGERATOR, OWNER SELECTED. ROUGH PLUMBING PER MANUF. SPECIFICATIONS
806	RANGE, PROVIDE GAS STUB & 220 ELECTRICAL
807	MICROWAVE, OWNER SELECTED
808	COUNTERTOP

SCHEDULE

Section 4 SCALE: 1/4" = 1'-0" 1

FLOOR FRAMING, SEE STRUCTURAL, PROVIDE INSULATION PER

SCI CREATIVE STUDIO

4195 CHINO HILLS PKWY, SUITE 599 CHINO HILLS, CA 91709

CONTACT: KEYUR MARU 714.390.0525 KMARU@SAJNIDESIGN.COM

OLIENT

BARRY DADON

23939 PARK GRANADA, CALABASAS, CA 91302

TEL: 310.905.9943 EMAIL: BARRYDADON@GMAIL.COM

DDN IECT.

DADON RESIDENCE

23939 PARK GRANADA, CALABASAS, CA 91302

REVISION:

		_
		_
		_

STAMP:



REPRODUCED IN WHOLE OR IN PART. IT IS TO BE USED FOR THE PROJECT AND SITE SPECIFICALLY IDENTIFIED HEREIN AND IS NOT TO BE USED ON ANY OTHER PROJECT. THIS DRAWING IS TO BE RETURNED UPON THE WRITTEN REQUEST OF **sda**.

© COPYRIGHT 2022 SAJNI DESIGN & ARCHITECTURE ALL RIGHTS RESERVED.


DRAWING DATA:

PROJECT NO	220625
ISSUE DATE	04.01.2022
SCALE	1/4" = 1'-0"
DRAWN BY	Author
SHEET SIZE	24" x 36"

IF SHEET IS LESS THAN SIZE INDICATED ABOVE, THIS IS A REDUCED PRINT. REDUCE SCALE ACCORDINGLY.

:

PROPOSED SECTIONS

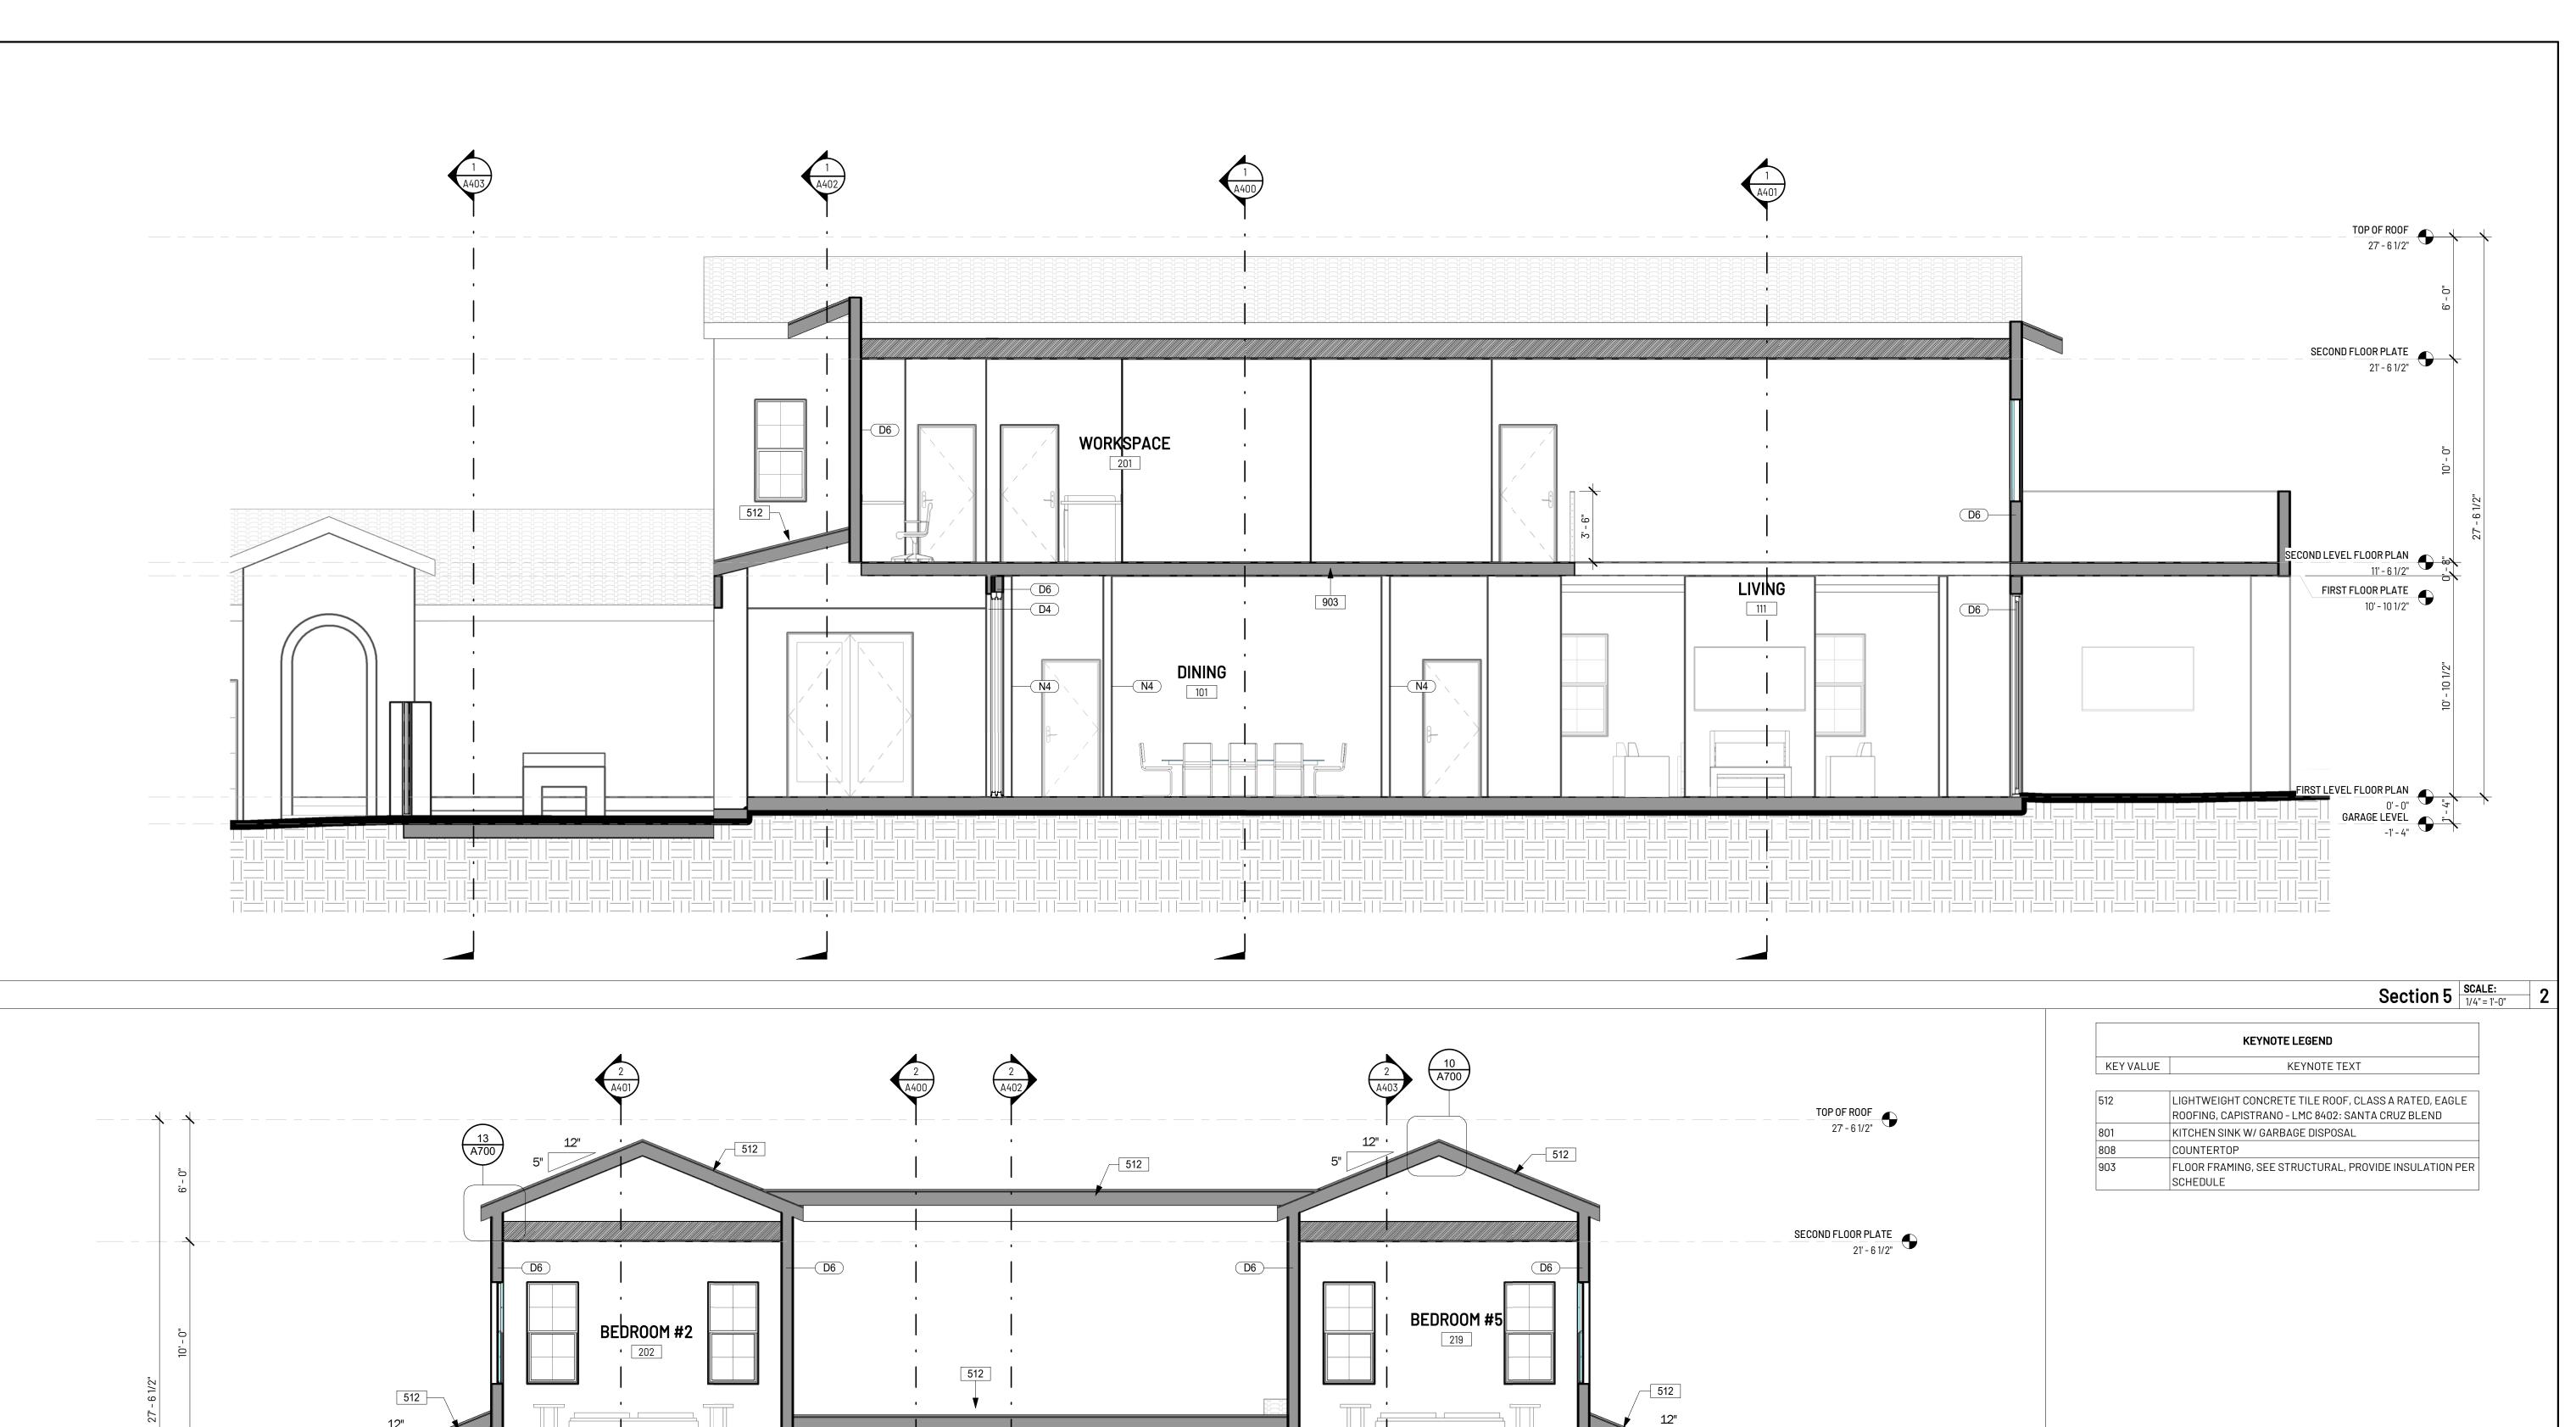

SECOND LEVEL FLOOR PLAN
11' - 6 1/2"

OFFICE

ENTRY HALI

106

FIRST FLOOR PLATE
10' - 10 1/2"

FIRST LEVEL FLOOR PLAN

0'-0"

GARAGE LEVEL

Section 7 | SCALE: 1/4" = 1'-0" | 1



4195 CHINO HILLS PKWY, SUITE 599 CHINO HILLS, CA 91709

CONTACT: KEYUR MARU 714.390.0525 KMARU@SAJNIDESIGN.COM

CLIENT:

BARRY DADON

23939 PARK GRANADA, CALABASAS, CA 91302

TEL: 310.905.9943 EMAIL: BARRYDADON@GMAIL.COM

PROJECT:

DADON RESIDENCE

23939 PARK GRANADA, CALABASAS, CA 91302

MARK DESCRIPTION DA

STAMP:



THIS DRAWING IS THE PROPERTY OF **sda** AND IS NOT TO BE REPRODUCED IN WHOLE OR IN PART. IT IS TO BE USED FOR THE PROJECT AND SITE SPECIFICALLY IDENTIFIED HEREIN AND IS NOT TO BE USED ON ANY OTHER PROJECT. THIS DRAWING IS TO BE RETURNED UPON THE WRITTEN REQUEST OF **sda**.

© COPYRIGHT 2022 SAJNI DESIGN & ARCHITECTURE ALL RIGHTS RESERVED.


DRAWING DATA:

PROJECT NO	220625
ISSUE DATE	04.01.2022
SCALE	1/4" = 1'-0"
DRAWN BY	Author
SHEET SIZE	24" x 36"

IF SHEET IS LESS THAN SIZE INDICATED ABOVE, THIS IS A REDUCED PRINT. REDUCE SCALE ACCORDINGLY.

t:

PROPOSED SECTIONS

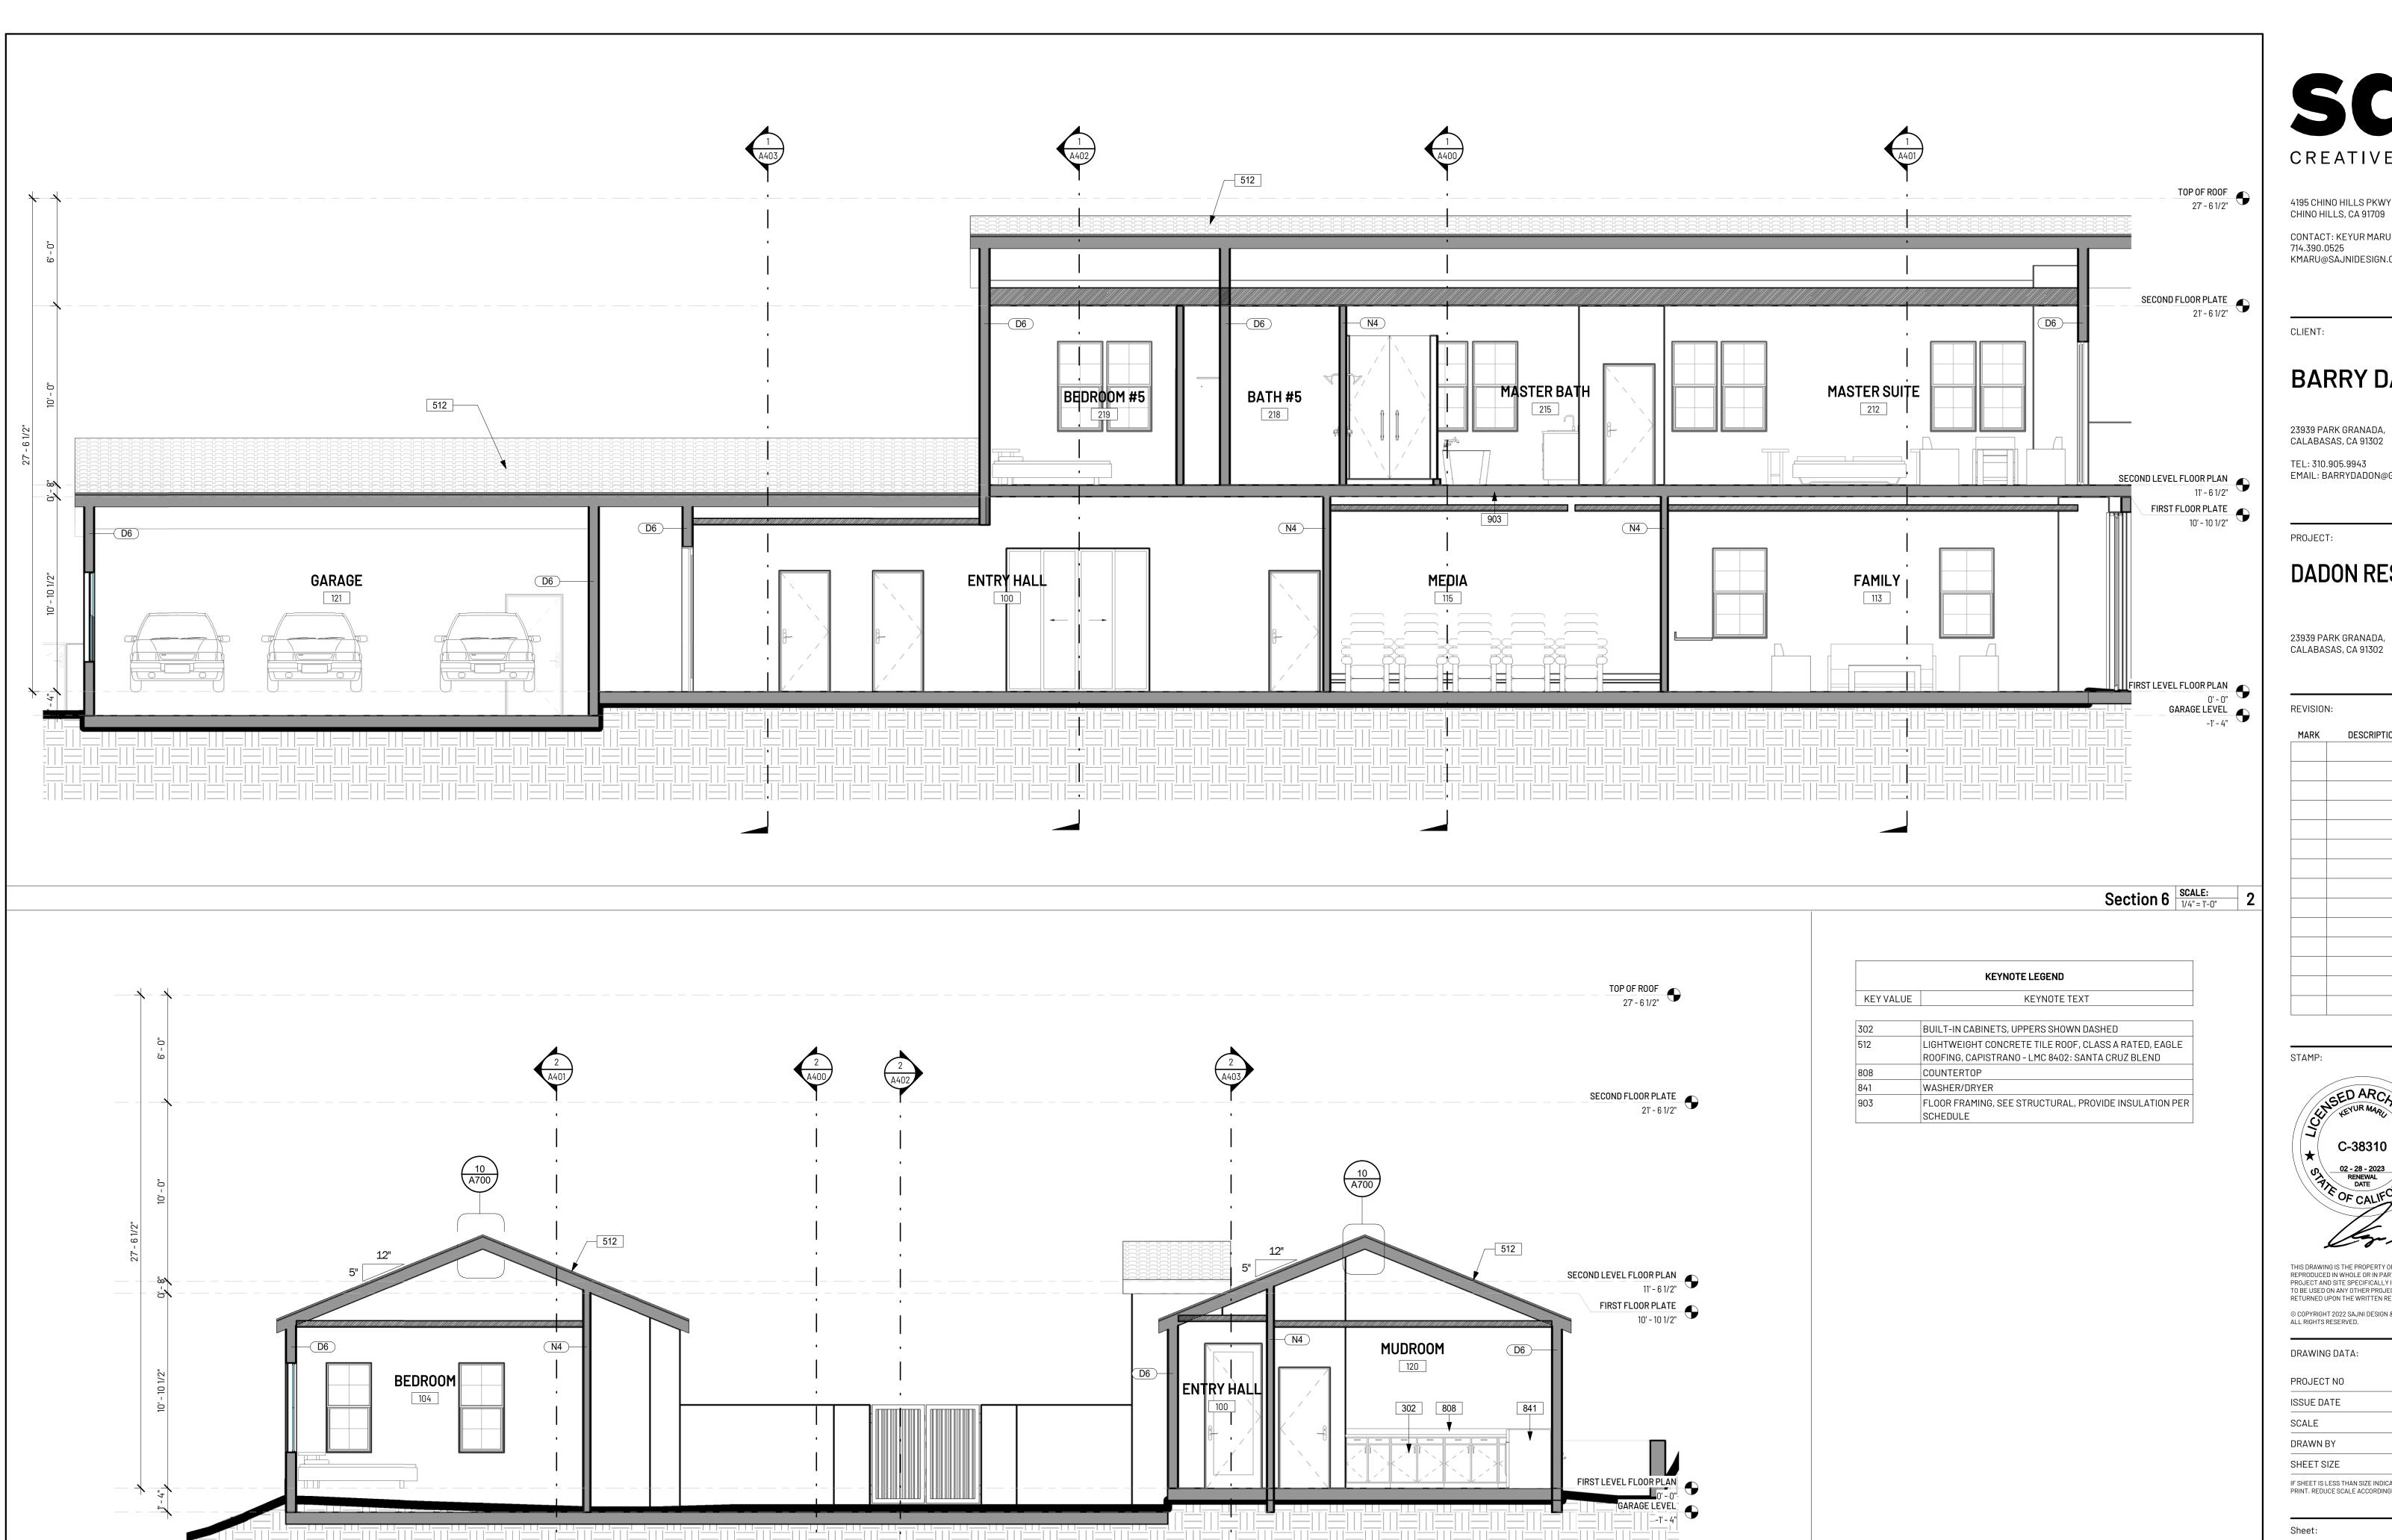

4195 CHINO HILLS PKWY, SUITE 599 CHINO HILLS, CA 91709

CONTACT: KEYUR MARU 714.390.0525 KMARU@SAJNIDESIGN.COM

BARRY DADON

TEL: 310.905.9943

EMAIL: BARRYDADON@GMAIL.COM

DADON RESIDENCE

REVISION: MARK DESCRIPTION



THIS DRAWING IS THE PROPERTY OF **sda** AND IS NOT TO BE REPRODUCED IN WHOLE OR IN PART. IT IS TO BE USED FOR THE PROJECT AND SITE SPECIFICALLY IDENTIFIED HEREIN AND IS NOT TO BE USED ON ANY OTHER PROJECT. THIS DRAWING IS TO BE RETURNED UPON THE WRITTEN REQUEST OF **sda**. © COPYRIGHT 2022 SAJNI DESIGN & ARCHITECTURE ALL RIGHTS RESERVED.


DRAWING DATA:

BIWITTE BITTE	
PROJECT NO	220625
ISSUE DATE	04.01.2022
SCALE	1/4" = 1'-0"
DRAWN BY	Author
	- ()

IF SHEET IS LESS THAN SIZE INDICATED ABOVE, THIS IS A REDUCED PRINT. REDUCE SCALE ACCORDINGLY.

Section 8 SCALE: 1/4" = 1'-0" 1

PROPOSED SECTIONS

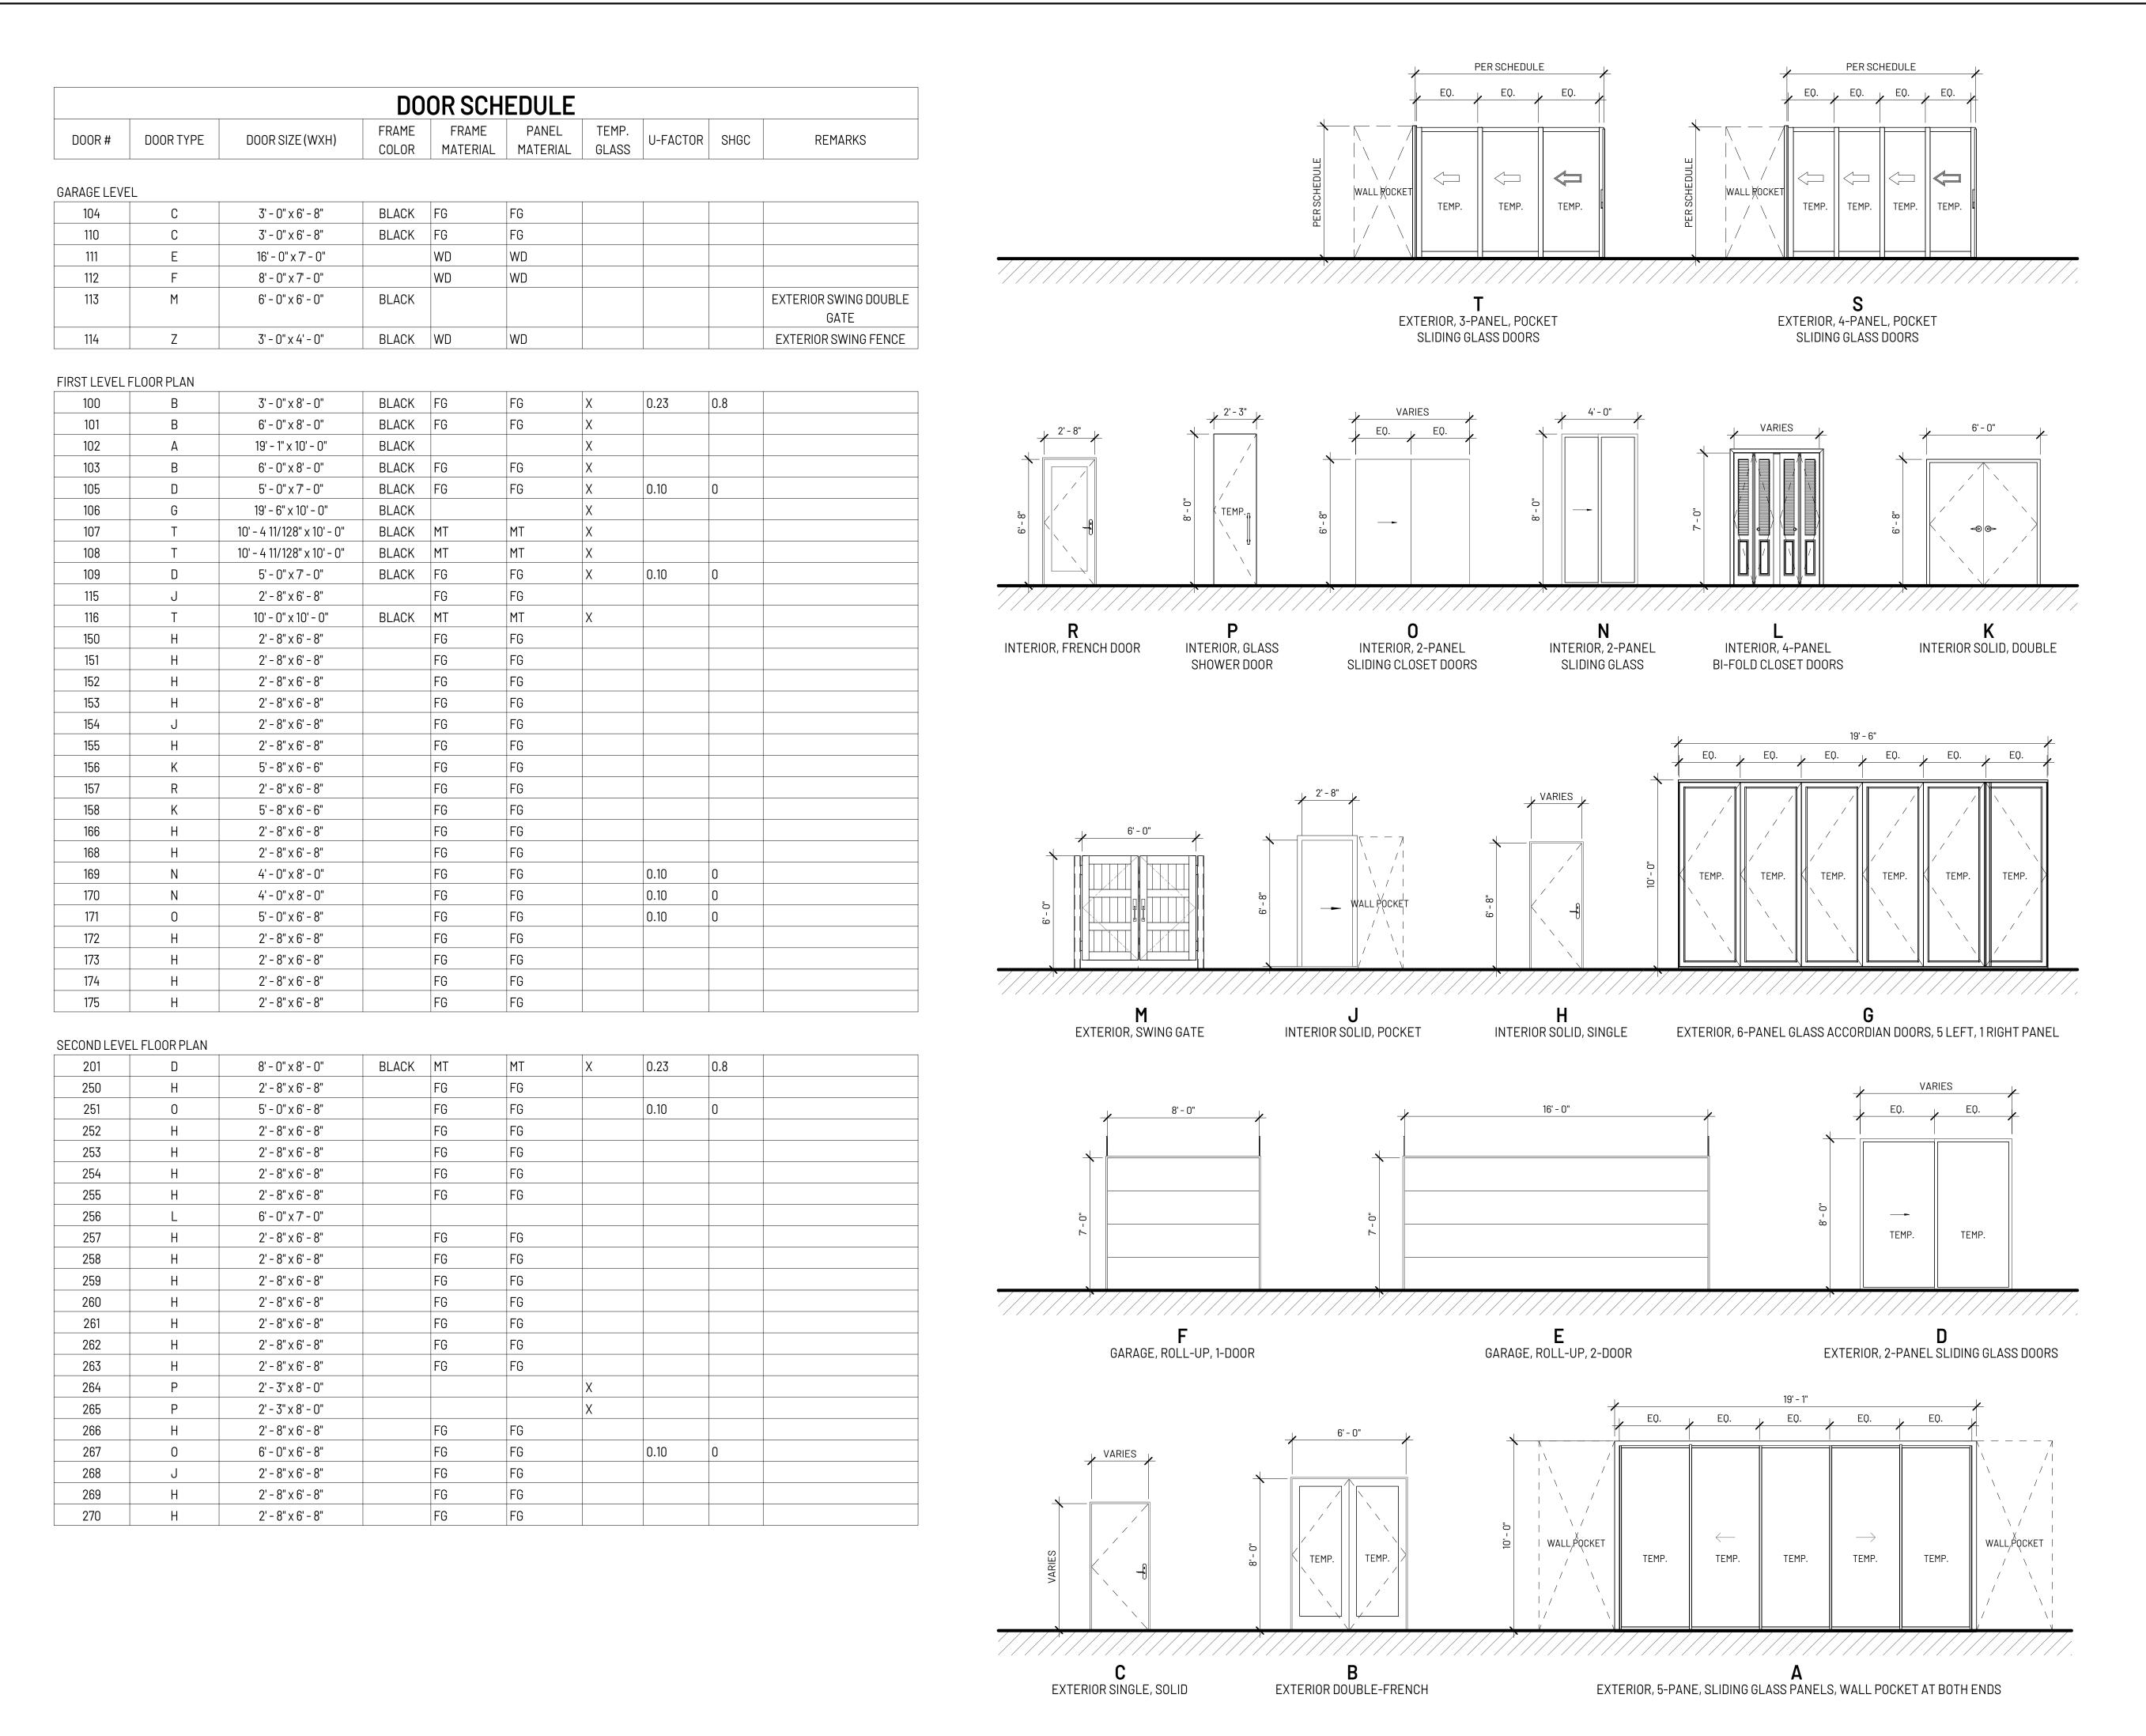



4195 CHINO HILLS PKWY, SUITE 599 CHINO HILLS, CA 91709

CONTACT: KEYUR MARU 714.390.0525 KMARU@SAJNIDESIGN.COM

CLIENT:

BARRY DADON

23939 PARK GRANADA, CALABASAS, CA 91302

TEL: 310.905.9943 EMAIL: BARRYDADON@GMAIL.COM

PROJECT:

DADON RESIDENCE

23939 PARK GRANADA, CALABASAS, CA 91302

MARK	DESCRIPTION	DATE

STAMP:



THIS DRAWING IS THE PROPERTY OF **sda** AND IS NOT TO BE REPRODUCED IN WHOLE OR IN PART. IT IS TO BE USED FOR THE PROJECT AND SITE SPECIFICALLY IDENTIFIED HEREIN AND IS NOT TO BE USED ON ANY OTHER PROJECT. THIS DRAWING IS TO BE RETURNED UPON THE WRITTEN REQUEST OF **sda**.

© COPYRIGHT 2022 SAJNI DESIGN & ARCHITECTURE

DRAWING DATA:


ALL RIGHTS RESERVED.

PROJECT NO	220625	
ISSUE DATE	04.01.2022	
SCALE	1/4" = 1'-0"	
DRAWN BY	Author	
SHEET SIZE	24" x 36"	

IF SHEET IS LESS THAN SIZE INDICATED ABOVE, THIS IS A REDUCED PRINT. REDUCE SCALE ACCORDINGLY.

eet.

DOOR SCHEDULE

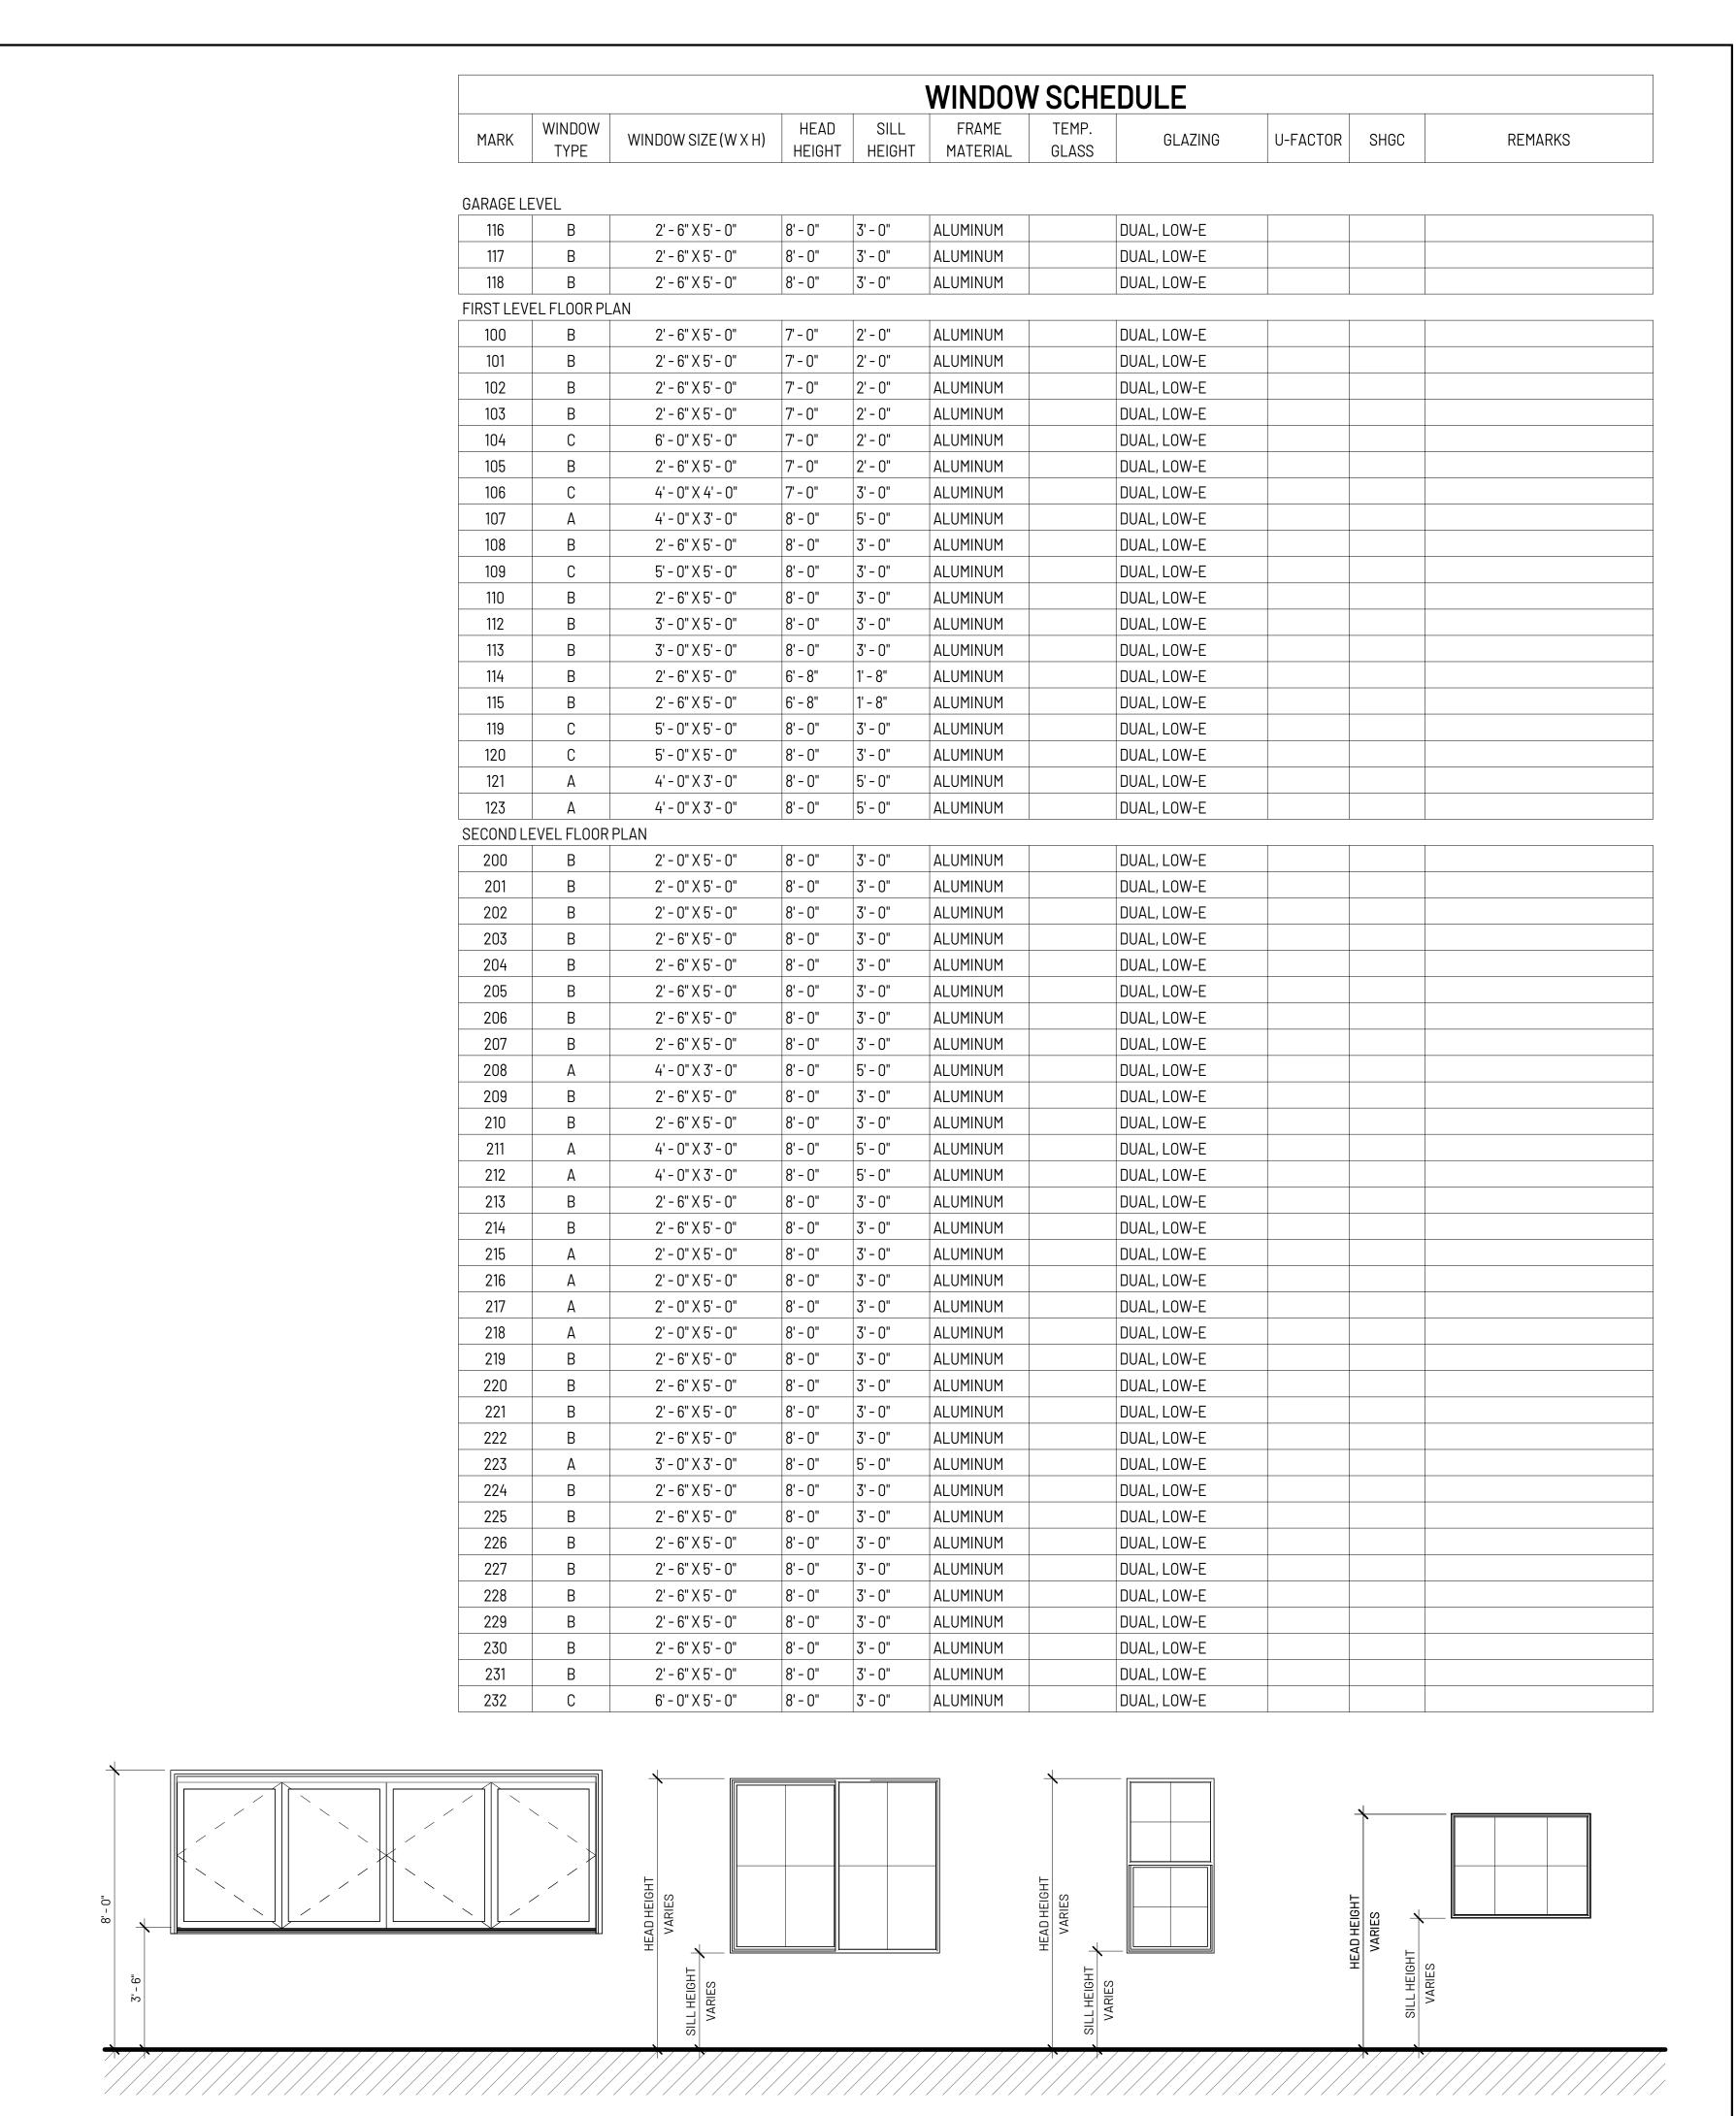

SINGLE SLIDER

4-PANEL ACCORDIAN



4195 CHINO HILLS PKWY, SUITE 599 CHINO HILLS, CA 91709

CONTACT: KEYUR MARU 714.390.0525 KMARU@SAJNIDESIGN.COM

CLIENT:

BARRY DADON

23939 PARK GRANADA, CALABASAS, CA 91302

TEL: 310.905.9943 EMAIL: BARRYDADON@GMAIL.COM

PROJECT:

DADON RESIDENCE

23939 PARK GRANADA, CALABASAS, CA 91302

MARK	DESCRIPTION	DAT

STAMP:



THIS DRAWING IS THE PROPERTY OF **sda** AND IS NOT TO BE REPRODUCED IN WHOLE OR IN PART. IT IS TO BE USED FOR THE PROJECT AND SITE SPECIFICALLY IDENTIFIED HEREIN AND IS NOT TO BE USED ON ANY OTHER PROJECT. THIS DRAWING IS TO BE RETURNED UPON THE WRITTEN REQUEST OF **sda**.

© COPYRIGHT 2022 SAJNI DESIGN & ARCHITECTURE

DRAWING DATA:

ALL RIGHTS RESERVED.

PROJECT NO	220625
ISSUE DATE	04.01.2022
SCALE	3/8" = 1'-0"
DRAWN BY	Author
SHEET SIZE	24" x 36"


IF SHEET IS LESS THAN SIZE INDICATED ABOVE, THIS IS A REDUCED PRINT. REDUCE SCALE ACCORDINGLY.

eet:

FIXED, PICTURE

SINGLE-HUNG


WINDOW SCHEDULE

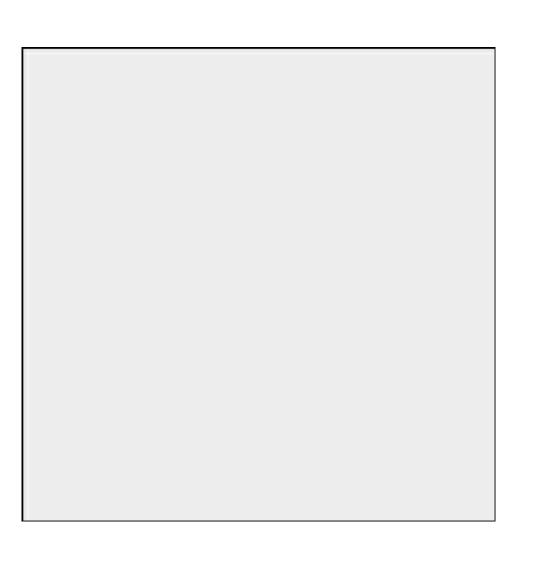


EXTERIOR STUCCO MATERIAL: STUCCO, ACRYLIC SMOOTH SAND-FINISH COLOR: BENJAMIN MOORE - CLOUD WHITE



INTERIOR FLOORING COLOR: WEATHERED OAK

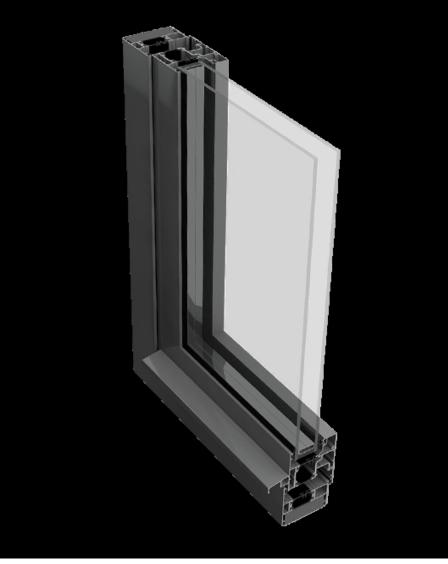


LOW-E, DUAL PANE GLASS **COLOR: MATTE BLACK METAL**

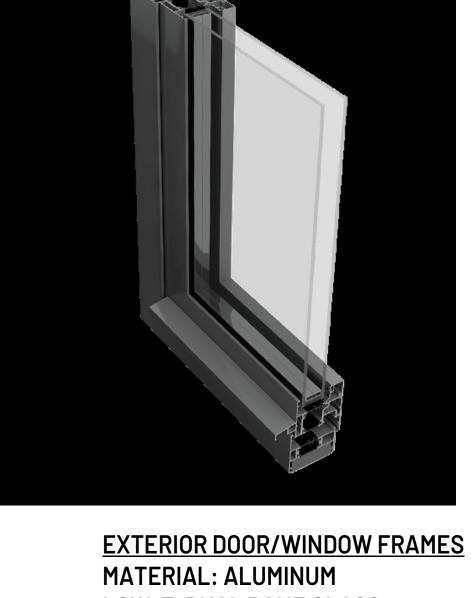

EXTERIOR GUTTERS & DOWNSPOUTS COLOR: BRONZE




RAILING BLACK METAL FRAME WITH TEMPERED GLASS PANELS COLOR: BLACK

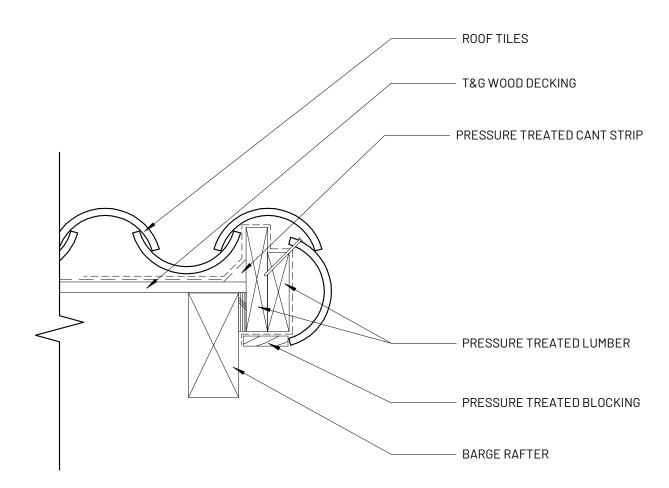

ROOF RAKE DETAIL



GARAGE DOOR & GATE SOLID WOOD STAINED & SEALED WEATHERED WOOD FINISH

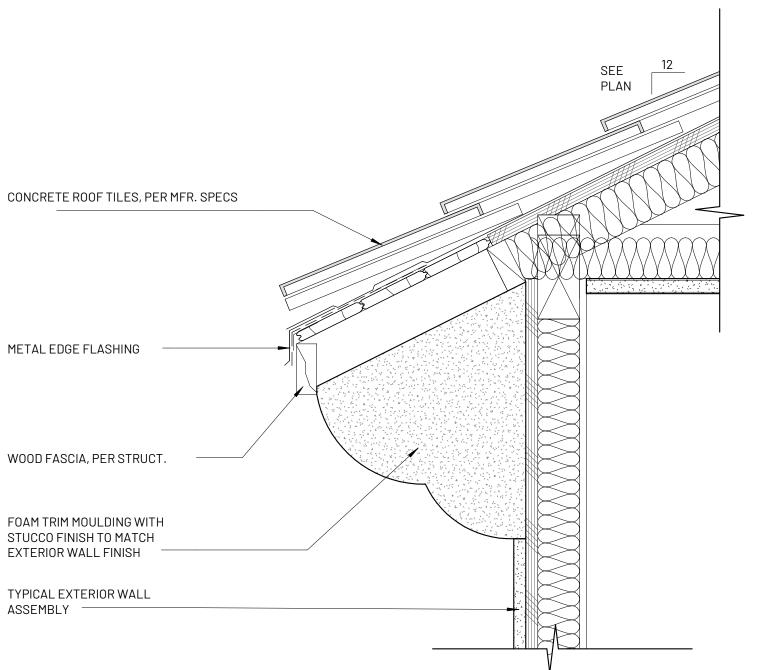

ROOF EAVE DETAIL

4195 CHINO HILLS PKWY, SUITE 599 CHINO HILLS, CA 91709

CONTACT: KEYUR MARU KMARU@SAJNIDESIGN.COM

BARRY DADON

23939 PARK GRANADA, CALABASAS, CA 91302

TEL: 310.905.9943 EMAIL: BARRYDADON@GMAIL.COM

PROJECT:

DADON RESIDENCE

23939 PARK GRANADA, CALABASAS, CA 91302

REVISION: MARK DESCRIPTION




THIS DRAWING IS THE PROPERTY OF **sda** AND IS NOT TO BE REPRODUCED IN WHOLE OR IN PART. IT IS TO BE USED FOR THE PROJECT AND SITE SPECIFICALLY IDENTIFIED HEREIN AND IS NOT TO BE USED ON ANY OTHER PROJECT. THIS DRAWING IS TO BE RETURNED UPON THE WRITTEN REQUEST OF **sda**. © COPYRIGHT 2022 SAJNI DESIGN & ARCHITECTURE ALL RIGHTS RESERVED.

DRAWING DATA:

PROJECT NO	220625
ISSUE DATE	04.01.2022
SCALE	3" = 1'-0"
DRAWN BY	Author
SHEET SIZE	24" x 36"

IF SHEET IS LESS THAN SIZE INDICATED ABOVE, THIS IS A REDUCED PRINT. REDUCE SCALE ACCORDINGLY.

COLOR AND MATERIAL BOARD

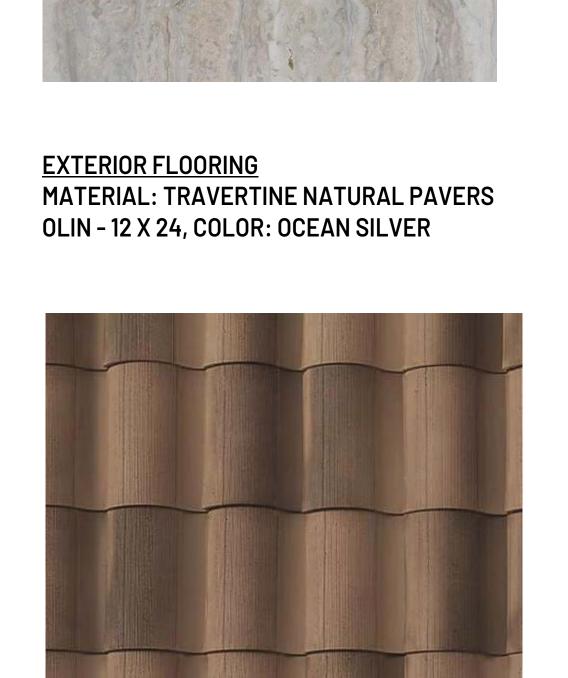

ROOFING MATERIAL: LIGHTWEIGHT CONCRETE TILE EAGLE ROOFING - CAPISTRANO PROFILE **CLASS A FIRE RATED** COLOR: LMC 8402: SANTA CRUZ BLEND



EXTERIOR LIGHTING WALL MOUNTED SCONCE COLOR: BLACK METAL FRAME WITH GLASS PANES