PROJECT

SHEET INDEX

ARCHITECTURAL

GENERAL NOTES

SITE PLAN

ELEVATIONS ELEVATIONS

SITE PICTURES
RENDERING

EXISTING SITE PLAN

EXISTING ROOF PLAN
PROPOSED ROOF PLAN
EXISTING ELEVATIONS
EXISTING ELEVATIONS

BUILDING SECTIONS

BUILDING MATERIALS

DOOR & WINDOW SCHEDULE

HOMES IN NEIGHBORHOOD (COMPARISON)

EXISTING VS. PROPOSED (COMPARISON)

SHEET INDEX, PROJECT SUMMARY

SITE COVERAGE CALCULATIONS
EXISTING FIRST FLOOR PLAN

EXISTING SECOND FLOOR PLAN

PROPOSED FIRST FLOOR PLAN
PROPOSED SECOND FLOOR PLAN

25510 PRADO DE AZUL CALABASAS, CA 91302

PROJECT SUN LEGAL INFORMATION 2019 CRC, CMC, CPC, CEC, CENC, CFC, CEBC BUILDING CODE: 2019 CALIFORNA GREEN BUILDING CODE ADDRESS / LEGAL CITY OF CALABASAS AMENDMENTS SITE ADDRESS 25510 PRADO DE AZUL RS **ZONING:** ZIP CODE R-3/U OCCUPANCY: PIN NUMBER LOT/PARCEL AREA 28,533 SQ FT EXISTING: 19.6% --- PROPOSED: 27.8% LOT COVERAGE: THOMAS BROTHERS GRID PAGE - - GRID ASSESSOR PARCEL NO. (APN) 2069100034 LOT AREA: 0.66 ACRE TR 35596-18 MAP REFERENCE BLOCK NONE PARKING SPACE PROVIDED: 4 PARKING SPACE ARB (LOT CUT REFERENCE) NONE NUMBER OF STORIES (SFD): 2 STORY ZONING (E) BUILDING AREA 6,745 SQFT 35'-0" -WITH ROOF SLOPE MORE THAN 25% BUILDING HEIGHT MAX PER CODE 9,914 SQ. FT. (N) BUILDING AREA BUILDING HEIGHT PROVIDED: 29'-5" -TO REQUIRED SETBACKS: 28,533.00 SQFT LOT SIZE FRONT SETBACK REQUIRED 20'-0" MIN SIDE SETBACK REQUIRED 10'-0" MIN EXISTING REAR SETBACK REQUIRED 20'-0" BUILDING FOOTPRINT 5,528.00 SQFT DRIVEWAY 696. 67 SQFT HARDSCAPE 5,861.99 SQFT EXISTING SETBACK: (E) FRONT SETBACK 33'-5" TOTAL EXISTING IMPERVIOUS SURFACES 12,086.66 SQFT (E) SIDE SETBACK: 10'-0", 14'-9" (E) REAR SETBACK 149'-4" PROPOSED PROPOSED SETBACK: ADDITION TO BUILDING FOOTPRINT 1,868.28 SQFT (N) FRONT SETBACK 23'-9" ADDITION TO DRIVEWAY 0 SQFT (E) SIDE SETBACK: 10'-0", 14'-9" (REMAINED THE SAME) 2,317.00 SQFT ADDITION TO HARDSCAPE (N) REAR SETBACK 115'-10" 369.93 SQ. FT. UNDER SEPARATE PERMIT TOTAL PROPOSED IMPERVIOUS SURFACES 4,555.21 SQFT TOTAL IMPERVIOUS SPACES: (E)12,086.66 SF + (N) 4,555.21 SF $\frac{1}{7}$ 16,641.87 SF TOTAL IMPERVIOUS TOTAL PERVIOUS SURFACES: 28,533.00 SQFT LOT SIZE - 16,641.87 TOTAL IMPERVIOUS = 11,892.00 SQFT TOTAL PERVIOUS 11,892.00 SQFT TOTAL PERVIOUS / 28,533.00 SQFT LOT SIZE = 41.7% PERVIOUS SURFACES THE OAKS HOA PERVIOUS SURFACE CREDIT = 72.8% SO THE PROPOSED PERVIOUS SURFACE PERCENTAGE IS OK. CONSULTANTS

MARY						
	SITE COVERAGE CALCULATION	SFD	SITE COVERAGE CALCULATION: LOT SQ. FT.= 28,533 X 35% = 9,986.55 EXISTING LOT COVERAGE= 5,582 SQ.FT. (19.6%) NEW PROVIDED LOT COVERAGE= 7,941 SQ.FT. (27.8%) 9,986.55 > 7,941 OK			
			7,700.33 7 7,7 II CIC			
	BUILDING AREA:	SFD	(E) SINGLE FAMILY DWELLING: 6,745.00 SF (N) ADDITION AREA: 3,169.00 SF			

2019 CALIFORNIA GREEN BUILDING STANDARDS CODE WITH CITY AMENDMENTS

TOTAL FLOOR AREA

(E) GARAGE AREA:

9,914.00 SF

852 SF

SCOPE OF WORK

- REMODEL AND ADDITION TO EXISTING SINGLE FAMILY DWELLING:

INTERIOR REMODEL (2,497 SQ. FT.)

DESCRIPTION (LOCATION)

EXISTING PATIO (BOTTOM)

EXISTING BALCONY (TOP REAR)

FIRST FLOOR KITCHEN/FAMILY ROOM (BOTTOM REAR)

SECOND FLOOR (TOP REAR)

EXTERIOR REMODEL (94 SQ. FT.)

DESCRIPTION (LOCATION)

FACADE (TOP FRONT)

ADDITION (3,169 SQ. FT.)

DESCRIPTION (LOCATION)

KITCHEN & FAMILY ROOM

MASTER BEDROOM/BATH

COVERED PATIO

NEW OFFICE

BEDROOM & FACADE

DEMOLITION (288 SQ. FT.)

DESCRIPTION (LOCATION)


COVERED PATIO (BOTTOM)


- RE-ROOF ENTIRE ROOF LINE. NEW 4:12 SLOPE



RON ROZILLIO 25510 PRADO DE AZUL, CALABASAS, CA 91302

VICINITY MAP

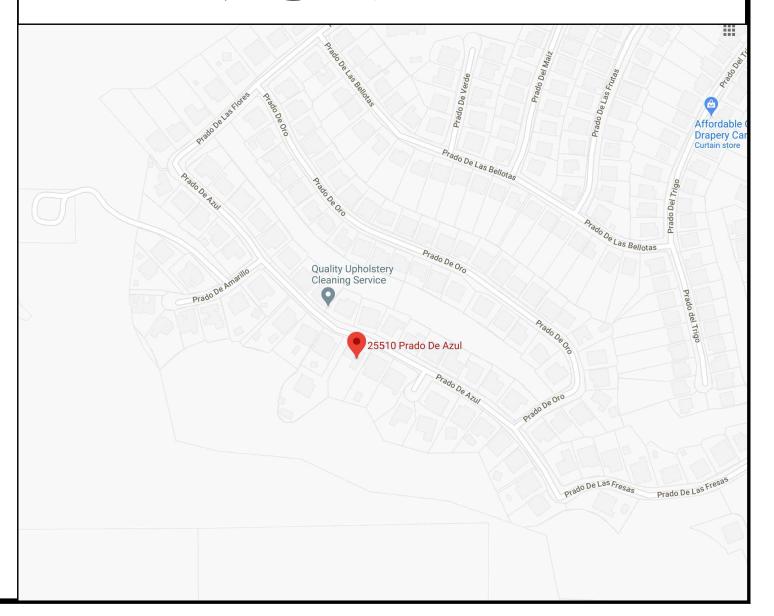

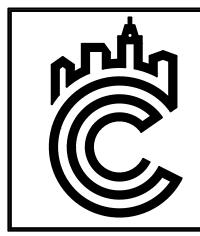

OLIVEIRA DESIGN 80 WILSHIRE BLVD, STE P04-1341 0S ANGELES, CA 90010 3-357-2151 FICCE@COLIVEIRADESIGN.COM

> 25510 PRADO DE AZUL, CALABASAS, CA 91302

COVER SHEET

A0

DECICNED

C-OLIVEIRA DESIGN INC.
3680 WILSHIRE BLVD, STE
P04-1341 LOS ANGELES,
CA 90010
213-357-2151

CA 90010 213-357-2151 OFFICE@COLIVEIRADESIGN.COM www.coliveiradesign.com

Provide anti-Graffiti finish within the first 9 feet, measured from grade, at exterior walls and

doors. Exception: Maintenance of building affidavit is recorded by the owner to covenant and agree with the City of Los Angeles to remove any graffiti within 7-days of the graffiti being

Mansionization Ordinance

If the ceiling height exceeds 14 ft, provide floor plans and clearly identify the areas which exceed the above thresholds (with hatching and dimension). The subject areas shall be included in the floor area calculations, except the first 100 sf of the ceiling over 14' need not be included.

Covered parking areas shall be included in the floor area, except the first 400 sf.

Attached porches, patios, and breezeways with sold roof shall be included in floor area calculations, except the first 250 s.f., when open at least two sides.

6. NOTE: Every space intended for human occupancy shall be provided with natural light by means of exterior glazed openings in accordance with Section 1205.2 or shall be provided with artificial light that is adequate to provide an average illumination of 10 footcandles over the area of the room at a height of 30 inches above the floor level. (1205.1 and 1205.3)

AREA AND OCCUPANCY

INTERIOR ENVIRONMENT

Under-floor ventilation shall be not less than 1/150 of under floor area. (2306)

3. Attic ventilation of 1/150 of the area of ventilated space (approximately 10 sq. in. for each 10 sq. ft. of attic area) is required. (1505.3)

K. GENERAL REQUIREMENTS

19. Show minimum $18'' \times 24''$ under floor access opening, 2306.3

20. Add note "Provide 70 inch high non-absorbent wall adjacent to shower and approved shatter-resistant materials for shower enclosure." (807.1.3, 2406.4(5), 1115B.9.6, 7, 8)

21. Provide 32" wide doors to all interior accessible rooms. (6304.1)

22. Add note "Water heater must be strapped to wall," (Sec. 507.3, UPC)

23. The following are required for attached U-1 occupancy garage /

Specify materials of one-hour fire-resistive construction on the garage side for walls and, when supporting an upper floor, ceilings, posts and beam of garage. (302.4 and T 3-B)

b. Doors to be self closing, 1 3/8" solid wood slab or 20 minute rated door assembly. (302.4)

*M. FIRE PROTECTION (LA CITY SPECIFIC)

approved by Plumbing Div. prior to installation." (12.21A17(d), 91.506)

Smoke detectors shall be provided as follows: (310.9.1.3,4)

In new construction smoke detectors shall receive their primary power source from the building wiring and shall be equipped with battery back up and low battery signal. Smoke detectors shall be located in each sleeping room & hallway or area giving access to a sleeping room, and on each story | I-. Unit Skylights shall be labeled by a LA City Approved Labeling and basement for dwellings with more than one story.

o. In existing construction smoke detectors may be battery operated, installed in location as specified in a) above.

Add note "Provide an approved spark arrester for the chimney of fireplace, stove, or barbecue." (L.A.M.C. 57.20.25)

B. VERY HIGH FIRE HAZARD SEVERITY ZONE (VHFHSZ) (701A.3.2, 7201.2, 7207)

1. Based on City maps, this project is located within Very High Fire Hazard Severity Zone (VHFHSZ). It shall Comply with requirements of Materials, systems & construction methods of Chapter 7A and Chapter 72.

a. Class A roof covering is required for all buildings. Wood shakes and shingles are not permitted. (7207.4, 1505)

Valley flashings shall be not less than 0.019-inch (0.48 mm) (No. 26 galvanized sheet gage) corrosion-resistant metal installed over a minimum 36-inch-wide (914mm) underlayment consisting of one layer of No. 72 ASTM cap sheet running the full length of the valley (704A.1.3)

Roof gutters shall be provided with the means to prevent the accumulation of leaves and debris in the gutter (704A.1.5)

(Roof) (Attic)(Exterior wall) vents shall resist the intrusion of flame and embers into the attic area of the structure, or shall be protected by corrosion-resistant, noncombustible wire mesh with 1/4 -inch (6 mm) openings or its equivalent. Vents shall not be installed

n eaves and cornices (704A.2.1, 704A3.2.1, 704A.2.2, 7207.3) Eaves and soffits shall meet the requirements of SFM 12-7A-3 or shall be protected by ignition-resistant materials or noncombustible construction | alterations, repairs, or additions, exceeding one thousand dollars on the exposed underside (704A.2.3)

Exterior walls shall be approved noncombustible or ignition-resistant material, heavy timber, or log wall construction or shall provide protection from the intrusion of flames and embers in accordance with standard SFM 12-7A-1 (704A.3.1)

c. Exterior wall coverings shall extend from the top of foundation to the the specific dwelling unit or sleeping unit for which the permit was roof, and terminate at 2-inch (50.8 mm) nominal solid wood blocking between rafters at all roof overhangs, or in the case of enclosed eaves, terminate at the enclosure (704A.3.2)

d. Exterior windows, window walls, glaze doors, and glazed openings within exterior doors shall be insulating- glass units with a minimum of one tempered pane, or glass block units, or have a fire- resistance rating of not less than 20 minutes, when tested according to ASTM E 2010, or conform level. (R303.1) to the performance requirements of SFM 12-7A-2 (704A.3.2.2)

Exterior door assemblies shall conform to the performance requirements be made available at the job site of standard SFM 12-7A-1 or shall be approved noncombustible construction, or solid core wood having stiles and rails not less than 1 3/8 inches thick with interior field panel thickness no less than 1 ¼ inches thick, or shall have a fire-resistance rating of not less than 20 minutes when tested according

to ASTM E 2074. (Exception: Noncombustible or exterior fire-retardant treated wood vehicle access doors) (704A.3.2.3)

Decking, surfaces, stair treads, risers, and landings of decks, porches, and balconies where any portion of such surface is within 10 feet (3048 mm) of the primary structure shall be constructed of heavy timber, non combustible or other approved materials per Sec.704A.4.1

The underside of cantilevered and overhanging appendages and floor projections shall maintain the ignition—resistant integrity of exterior walls, or the projection shall be enclosed to the grade (704A.4.2.1)

Buildings shall have all underfloor areas completely enclosed to the grade with construction as required for exterior walls (704A.4.2.2, 7207.1)

All utilities, pipes, furnances, water heaters or other mechanical devices located in an exposed under-floor area of a residential building shall be enclosed with materials as required for 1-hour fire-resistive construction.(7207.2)

The space between the roof covering and roof decking shall be constructed to prevent the intrusion of flames and embers and be fire stopped per 704A.1.2.

No trellis is permitted within 10 feet of the primary structure.

Trellis more than 10 feet from the primary structure shall be constructed of heavy timber or non combustible materials. Minimum of 4 inches spacing is required between the members. (Information Bulletin No. P/BC 2008-023).

BUILDING CODE REQUIREMENTS A. GENERAL REQUIREMENTS

A—. For residential pool show the pool enclosure on the plan. The top | C. BUILDING HEIGHT LIMITATION of the barrier shall be at least 60 inches above grade measured on the side of the barrier that faces away from the swimming pool. The max. vertical clearance between grade and the bottom of the barrier shall be two inches measured on the side of the barrier that faces away from the Swimming pool. The gate shall open outward away from the pool and shall be self-closing and self-latching. The latch to be minimum 4.5 ft above the ground. (3109.4.1, 6109.1)

B-. The construction shall not restrict a five-foot clear and unobstructed access to any water or power distribution facilities (Power poles, pull-boxes, transformers, vaults, pumps, valves, meters, appurtenances, etc.) or to the location of the hook-up. The construction shall not be within ten feet of any power lines-whether or not the lines are located on the property. Failure to comply may cause construction delays and/or additional expenses.

C-. An approved Seismic Gas Shutoff Valve will be installed on the fue 1.1. Provide 1-hr fire-resistance exterior walls if fire separation gas line on the down stream side of the utility meter and be rigidly | distance is: connected to the exterior of the building or structure containing the fuel gas piping." (Per Ordinance 170,158) (Includes Commercial additions and TI work over \$10,000.) Separate plumbing permit is required.

D-. Plumbing fixtures are required to be connected to a sanitary sewer or to an approved sewage disposal system (R306.3).

E-. Provide an alarm for doors to the dwelling that form a part of the pool enclosure. The alarm shall activate within 7 seconds and sound continuously for a min. of 30 seconds when the door is opened It shall automatically reset and be equipped with a manual means to deactivate (for 15 secs. max.) for a single opening. The deactivation switch shall be at least 54" above the floor. (3109.4.1.8)

F-. Suction outlets shall be designed and installed in accordance with ANSI / APSP-7 (3109.5)

G-. Provide ultra low flush water closets for all new construction. Existing shower heads and toilets must be adapted for low water

H-. Provide 70 inch high non-absorbent wall adjacent to shower and approved shatter-resistant materials for shower enclosure." (1115B.2 and 2406.3(5)

Agency. Such label shall state the approved labeling agency name, product designation and performance grade rating (research report not regulred). 2405.5

J-. Water heater must be strapped to wall (Sec. 507.3, UPC)

K-. For new pool on site, provide an alarm for doors to the dwelling that form a part of the pool enclosure. The alarm shall sound continuously for a min. of 30 seconds when the door is opened. It shall automatically reset and be equipped with a manual means to deactivate (for 15 secs. Max.) For a single opening. The deactivation switch shall be at least 54" above the floor. P/BC 2008- 014

L-. For new pool on site, provide ant-enetrapment cover meeting the current ASTM or ASME is required for the suction outlets of the swimming pool, toddler pool and spa for single family dwellings per the 2. Assembly Bill (AB) No. 2977 M. Kitchen sinks, lavatories, bathtubs, showers, bidets, laundry tubs and copy of listing on the plans.(R302.4.1) and washing machine outlets shall be provided with hot and cold water

Bathtub and shower floors, walls above bathtubs with a showerhead, and shower compartments shall be finished with a nonabsorbent surface. Such wall surfaces shall extend to a height of not less than 6 feet above the floor (R307.2)

and connected to an approved water supply (R306.4)

D. Plumbing fixtures are required to be connected to a sanitary sewer or to an approved sewage disposal system (R306.3) P. Automatic garage door openers, if provided, shall be listed in accordance with UL 325.

Smoke detectors shall be provided for all dwelling units intended for human occupancy, upon the owner's application for a permit for (\$1,000). (R314.6.2)

Where a permit is required for alterations, repairs or additions exceeding one thousand dollars (\$1,000), existing dwellings or sleeping units that have attached garages or fuel-burning appliances shall be provided with a carbon monoxide alarm in accordance with Section R315.1. Carbon monoxide alarms shall only be required in obtained. (R315.2)

natural light by means of exterior glazed openings in accordance with Section R303.1 or shall be provided with artificial light that is adequate to provide an average illumination of 6 foot-candles over the area of the room at a height of 30 inches above the floor | basements. (R315)

A copy of the evaluation report and/or conditions of listing shall

B. OCCUPANCY CLASSIFICATION

Doors between garage and the dwelling unit shall be self-closing alatching, solid wood or solid or honeycomb core steel not less than inches thick, or have a minimum fire protection rating of 20 minutes.

The proposed building is a Garage and not a carport since it is not open

Openings from a private garage directly into a room used for sleeping purposes are not permitted (R302.5.1).

Doors between garage and the dwelling unit shall be self-closing and self-latching, solid wood or solid or honeycomb core steel not less than 1 3/8 inches thick, or have a minimum fire protection rating of 20 minutes. (R302.5.1)

4. The garage shall be separated from the dwelling and its attic area in accordance with Table R302.6 (R302.6)

5. Ducts penetrating the walls or ceilings separating the dwelling from the garage shall be constructed of a minimum No. 26 gage sheet steel or other approved material and there shall be no openings from the ducts into the garage (R302.5.2).

Other penetrations of garage/dwelling ceilings and walls are to be protected as required by Section R302.11, Item 4 (R302.5.3).

Garage floor surfaces shall be of an approved noncombustible material, and the area used to park vehicles shall be sloped to a drain or toward the main vehicle entry (R309.1).

PART III

Provide calculations for establishing grade plane as per Section R201. Attach calculations and identify established grade planes on elevations plans site plan. (R201)

Show maximum height of the structure (in feet and stories) from Average height of highest roof surface to grade plane on all elevation views.(R201)

Lowest level is determined not to be a basement. This level is considered as 1st story above grade plane. Include this story in total building height.

FIRE-RESISTANCE RATED CONSTRUCTION

Less than 5'[T- R302.1 (1)], or

Less than 3'if the building is equipped throughout with an automatic residential fire sprinkler system installed in accordance with section R313. [T- R302.1

1.1. Provide 1-hr fire-resistance exterior walls for R3/U occupancy less than 5' from property line or assumed property line (T602). Provide complete details per Section 704.5

. Show how 1- hr fire- resistance is being provided.

Openings are not allowed within 3'/ 5' fire separation distance. T-R302.1(1) & T- R302.1(2)]

Maximum 25% opening area are allowed when the fire separation distance is >3 and ≤ 5 . (T-302.1(1))

5. Projections beyond the exterior wall shall comply with Table R302.1 and shall not extend:

To a point closer than 2 feet from interior lot line.

More than 4 inches at the roof eave for detached garages accessory to a dwelling when located within 2 feet of a lot line.

c. Over the lot line for accessory structures that are exempt from permits.

In combustible construction, fire blocking shall be provided to cut off all concealed draft openings (both vertical and horizontal) and to form an effective fire barrier between stories, and between a top story and the roof space. (R302.11)

In combustible construction where there is usable space both above and below the concealed space of a floor/ceiling assembly, draftstops shall be installed so that the area of the concealed space does not exceed 1,000 square feet. Draftstopping shall divide the concealed space into approximately equal areas. (R302.12)

Through penetrations of fire-resistance-rated wall or floor assemblies shall comply with Section R302.4.1.1 or R302.4.1.2. Provide detail 2. Every dwelling unit shall be provided with a water closet, lavatory, bathtub or shower, and kitchen

Membrane penetrations shall comply with Section R302.4.1. Where walls are required to have a fire-resistance rating, recessed fixtures Section R308.3 (see exceptions) (R308.4): shall be installed so that the required fire-resistance rating will not | be reduced. (R302.4.2)

FIRE PROTECTION

The building shall be equipped with an automatic residential fire sprinkler system in accordance with section R313.3 or NFPA13D. (R313, 12.21A17(d)>

The Sprinkler System shall be approved by Plumbing Div. prior to installation.

An approved smoke alarms shall be installed in each sleeping room & hallway or area giving access to a sleeping room, and on each story and basement for dwellings with more than one story. Smoke alarms shall be interconnected so that actuation of one alarm will activate all the alarms within the individual dwelling unit. In new construction smoke alarms shall receive their primary power source from the building wiring and shall be equipped with battery back up and low | battery signal. (R314)

4. An approved carbon monoxide alarm shall be installed in dwelling units and in sleeping units within which fuel-burning appliances are Every space intended for human occupancy shall be provided with installed and in dwelling units that have attached garages. Carbon monoxide alarm shall be provided outside of each separate dwelling unit sleeping area in the immediate vicinity of the bedroom(s) and on every level of a dwelling unit including

MEANS OF EGRESS

Provide emergency egress from sleeping rooms. Show details on plans. Min.- 24" clear ht, 20" clear width, 5.7 sq.ft min area (5.0 sq ft at grade level) & 44" max to sill. (R310.1)

Provide minimum 9 sq.ft. window wells (with fixed ladder) at escape and rescue opening windows below grade. (R310.2)

At least one door shall be 36" wide by 80" high (R311.2)

Provide 32" wide doors to all interior accessible rooms. (6304.1)

Providing the door does not swing over the landing. Landing shall be not more than 7.75" below the threshold. Storm and screen doors are permitted to swing over all exterior stairs and landings.(R311.3.1)

The entry /exit door must open over a landing not more than 1.5" below the threshold. Exception

Landing at a door shall have a length measured in the direction of travel of no less than 36". (R311.3)

A landing shall be provided at the top and bottom of stairways. Exception for top of an interior flight of stairs and stairs in an enclosed garage (R311.7.5).

Stairway details: a.7.75" rise & min. 10" run. (R311.7.4)

b.Min. 6'-8" headroom clearance. (R311.7.2)

c.Min. (36") clear width. (R311.7.1)

d.Handrails 34" to 38" high above tread nosing (R311.7.7.1)

e.Handgrip portion of handrail shall not be less than 1.25" and no more than 2" crosssectional dimension having a smooth surface with no sharp corners. (R311.7.7.3)

f.Max 4" clear spacing opening between rails. (R312.3)

Enclosed accessible space under stairs shall have walls, under-stair surface and any soffits protected on the enclosed side with 1/2 inch gypsum board. (R302.7)

All interior and exterior stairways shall be illuminated (R303.6).

Winder treads shall comply with Section R311.7.3.

Spiral stairs shall comply with Section R311.7.9.1.

Ramp slopes shall not exceed 1:12 (8%).(R311.7.3) Provide 42" high guards with max 4" clear spacing opening between rails at (

For glass handrails and guards, the panels and their support system shall be designed to withstand the loads specified in Chapter 16. A safety factor of four

shall be used. The minimum nominal thickness of the glass shall be 1/4 inch. (2407)

INTERIOR ENVIRONMENT

The minimum ceiling height for habitable space, hallways, bathrooms, toilet rooms, laundry rooms and portions of basements containing these spaces shall be not less than 7 feet (R305.1).

Under-floor ventilation shall be not less than 1/150 of under floor area.

Show minimum 18" x 24" under floor access opening. (R408.4)

Attic ventilation of 1/150 of the area of ventilated space (approximately 10 sq. in. for each 10 sq. fi of attic area) is required.(R806.2)

Attic area having a clear headroom of 30" must have an access opening (20" x 30" min). (R807.1

Provide 15" min. between the center of water closet to any side wall. (Calif. Plumb. Code 407.6)

Bathrooms, water closet compartments and other similar rooms shall be provided natural and

Provide 24" clear space in front of any water closet. (Calif. Plumb. Code 407.6)

mechanical ventilation capable of 50 cfm exhausted directly to the outside (R303.3)

Heater shall be capable of maintaining a minimum room temperature of 68°F at a point 3 feet above the floor and 2 feet from exterior walls in all habitable rooms at the design temperature. (R303.8)

27. For new construction, addition or major remodel to any One-Family Dwelling or Accessory Building on a lot in R1, RS, RE, or RA Zones and designated Hillside Area (12.21C.10.):

ZONING:

All portions of required front yard not used for necessary driveways and walkways, including decorative walkways shall be used for planting and shall not be paved. (12.21C10(a)(5))

On lots fronting a Substandard Hillside Limited Street, open unenclosed stairways, porches, platforms and landing places not covered by a roof or canopy shall not project or extend into the front yard. (12.21C10(a)(10)(ii))

BUILDING ENVELOPE

Provide a class A, B or C fire-retardant roof covering per Section R902.1

(R306.1 and R306.2).

Glazing in the following locations shall be safety glazing conforming to the human impact loads

Fixed and operable panels of swinging, sliding and bifold door assemblies.

Glazing in an individual fixed or operable panel adjacent to a door where the nearest vertical edge is within a 24-inch arc of the door in a closed position and whose bottom edge is less than 60 inches

above the floor or walking surface.

Glazing in an individual fixed or operable panel that meets all of the following conditions:

Top edge greater than 36 inches above the floor.

Exposed area of an individual pane greater than 9 square feet. Bottom edge less than 18 inches above the floor.

One or more walking surfaces within 36 inches horizontally of the glazing.

inches within the first 10 feet (R401.3)

Glazing in enclosures for or walls facing hot tubs, whirlpools, saunas, steam rooms, bathtubs and showers where the bottom edge of the glazing is less than 60 inches measured vertically above any

Glazing in walls and fences adjacent to indoor and outdoor swimming pools, hot tubs and spas where the bottom edge of the glazing is less than 60 inches above a walking surface and within 60 inches, measured horizontally and in a straight line, of the water's edge.

Glazing adjacent to stairways, landings and ramps within 36 inches horizontally of a walking surface when the surface of the glazing is less than 60 inches above the plane of the adjacent walking

Glazing adjacent to stairways within 60 inches horizontally of the bottom tread of a stairway in any direction when the exposed surface of the glazing is less than 60 inches above the nose of the tread.

Lots shall be graded to drain surface water away from foundation walls with a minimum fall of 6

Dampproofing, where required, shall be installed with materials and as required in Section R406.1

preservative and end use. Preservatives shall be listed in Section 4 of AWPA U1.

Vehicular access doors shall comply with Section R612.7. Buildings shall have approved address numbers, building numbers or approved building identification placed in a position that is plainly legible and visible from the street or road fronting the

Protection of wood and wood based products from decay shall be provided in the locations specified per Section R317.1 by the use of naturally durable wood or wood that is preservative-treated in accordance with AWPA U1 for the species, product,

Ш SIGN BLVD, STE CA 90010

SULIVEIRA DES 30 WILSHIRE ES ANGELES, C 3-357-2151


NOTE A ENER

09/27/2020 DATE:

SCALE NTS **REVISION:**

PROJECT #: 19-XXX

DRAWN BY: MS

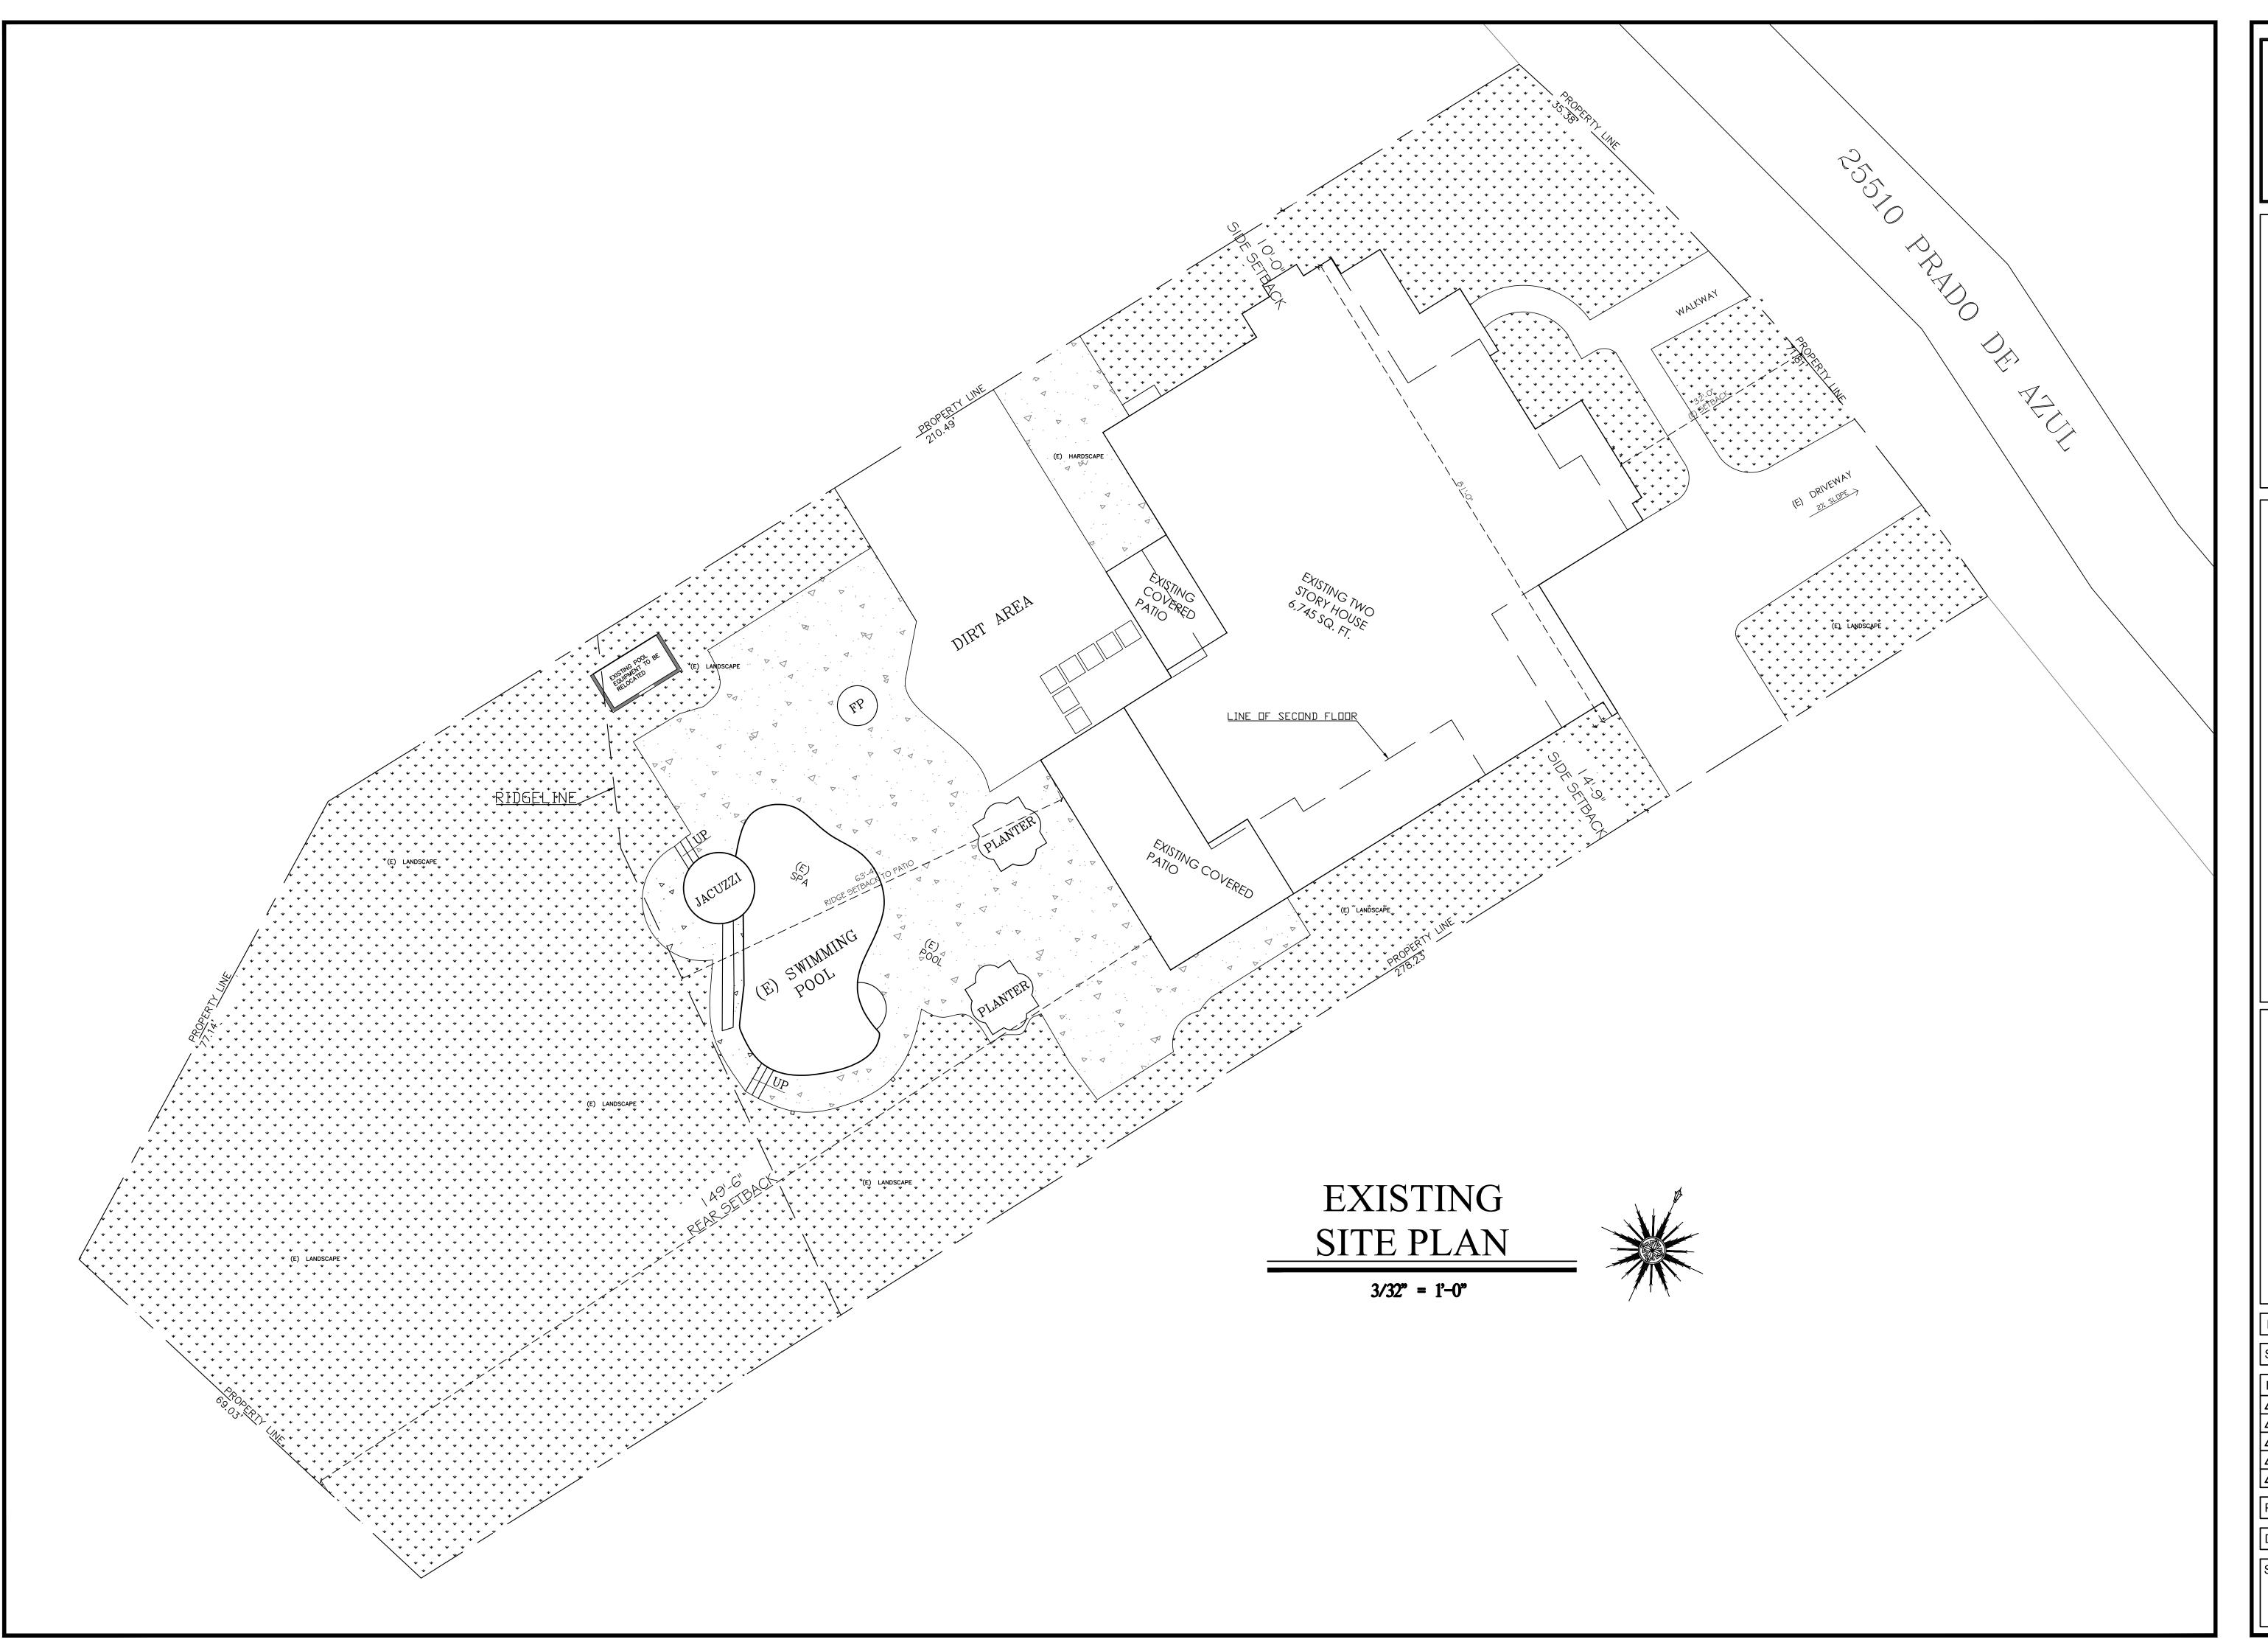



AZUL, 91302

25510 PRADO | CALABASAS, (

DESIGN IRE BLVD, STE P04-1341 ES, CA 90010

DATE: 09/29/2020

SCALE: 3/32" = 1'-0"

REVISION:


A


A

本点点かかPROJECT #: 19-XXX

DRAWN BY: MS

ET **Δ1**

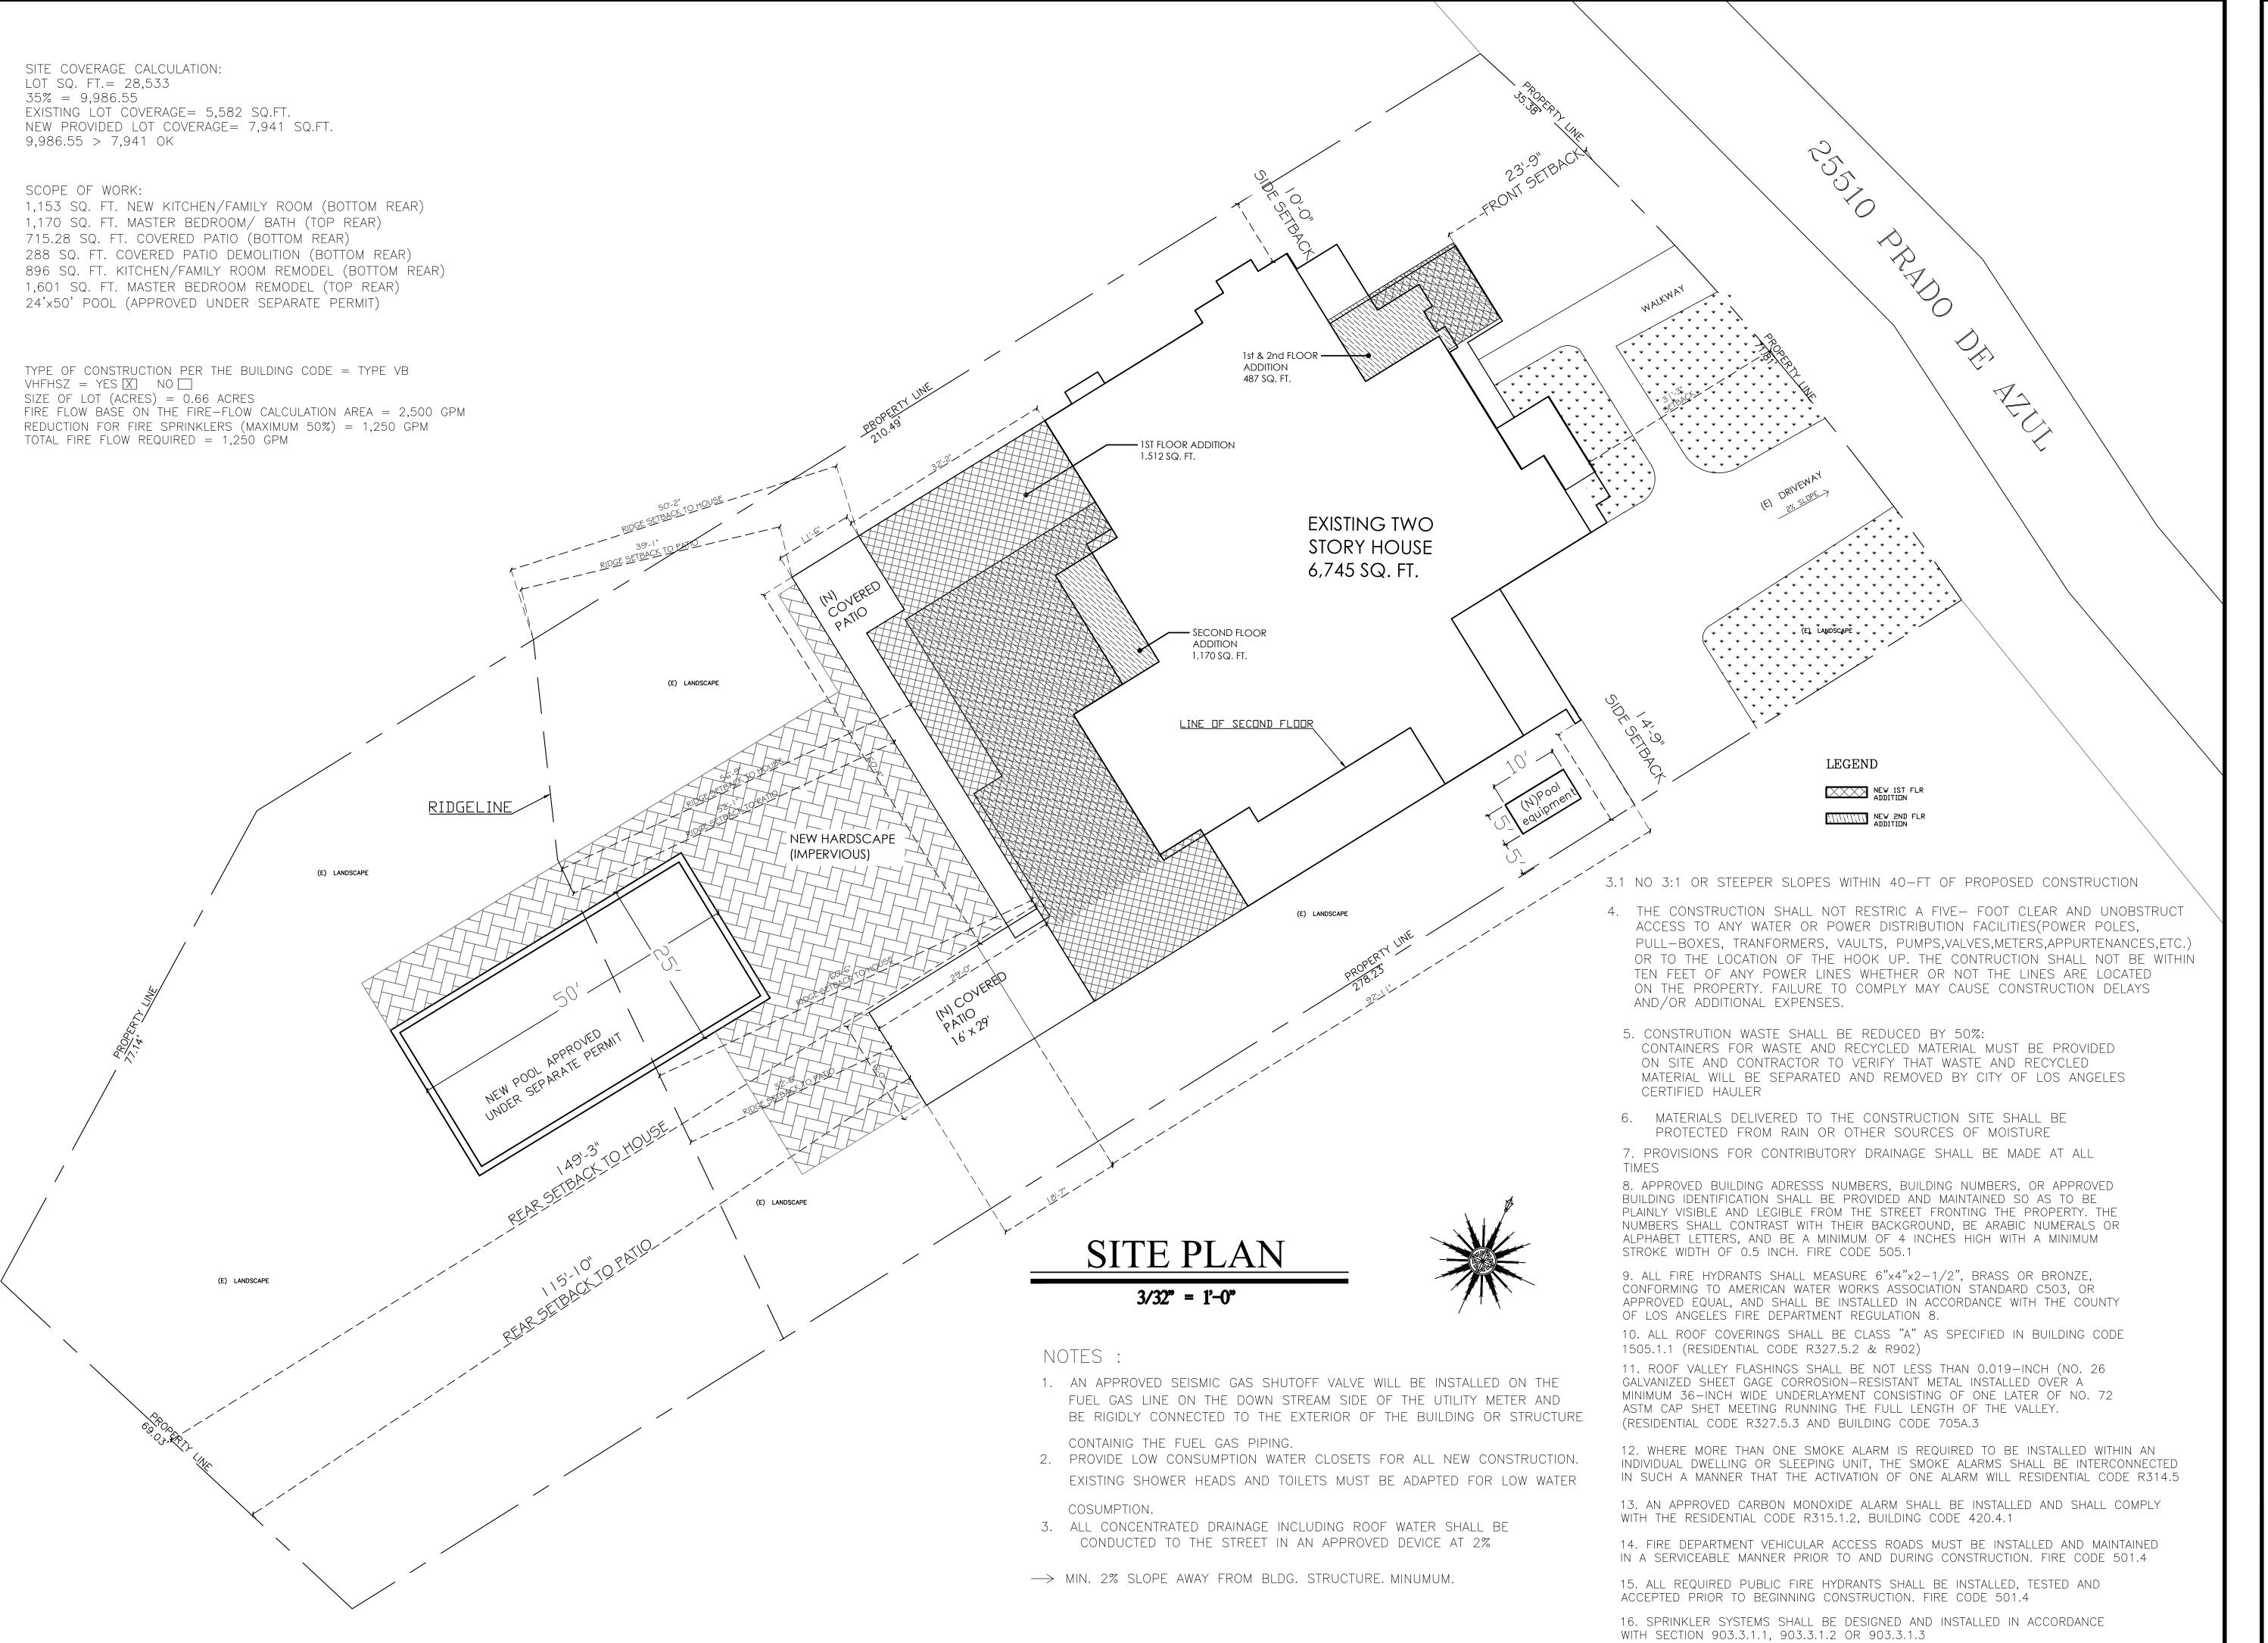

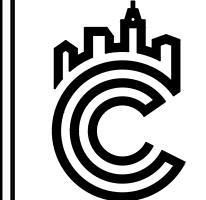

DLIVEIRA DESIGN 30 WILSHIRE BLVD, STE P04-13 S ANGELES, CA 90010 3-357-2151 ICCE@COLIVEIRADESIGN.COI

> 5510 PRADO DE AZUL, ALABASAS, CA 91302

25 C/

SITE PLAN

ATE: 09/29/2020

SCALE: 3/32" = 1'-0"

REVISION:

A

A

A

A

A


A

A

PROJECT #: 19-XXX

DRAWN BY: MS

A1.1

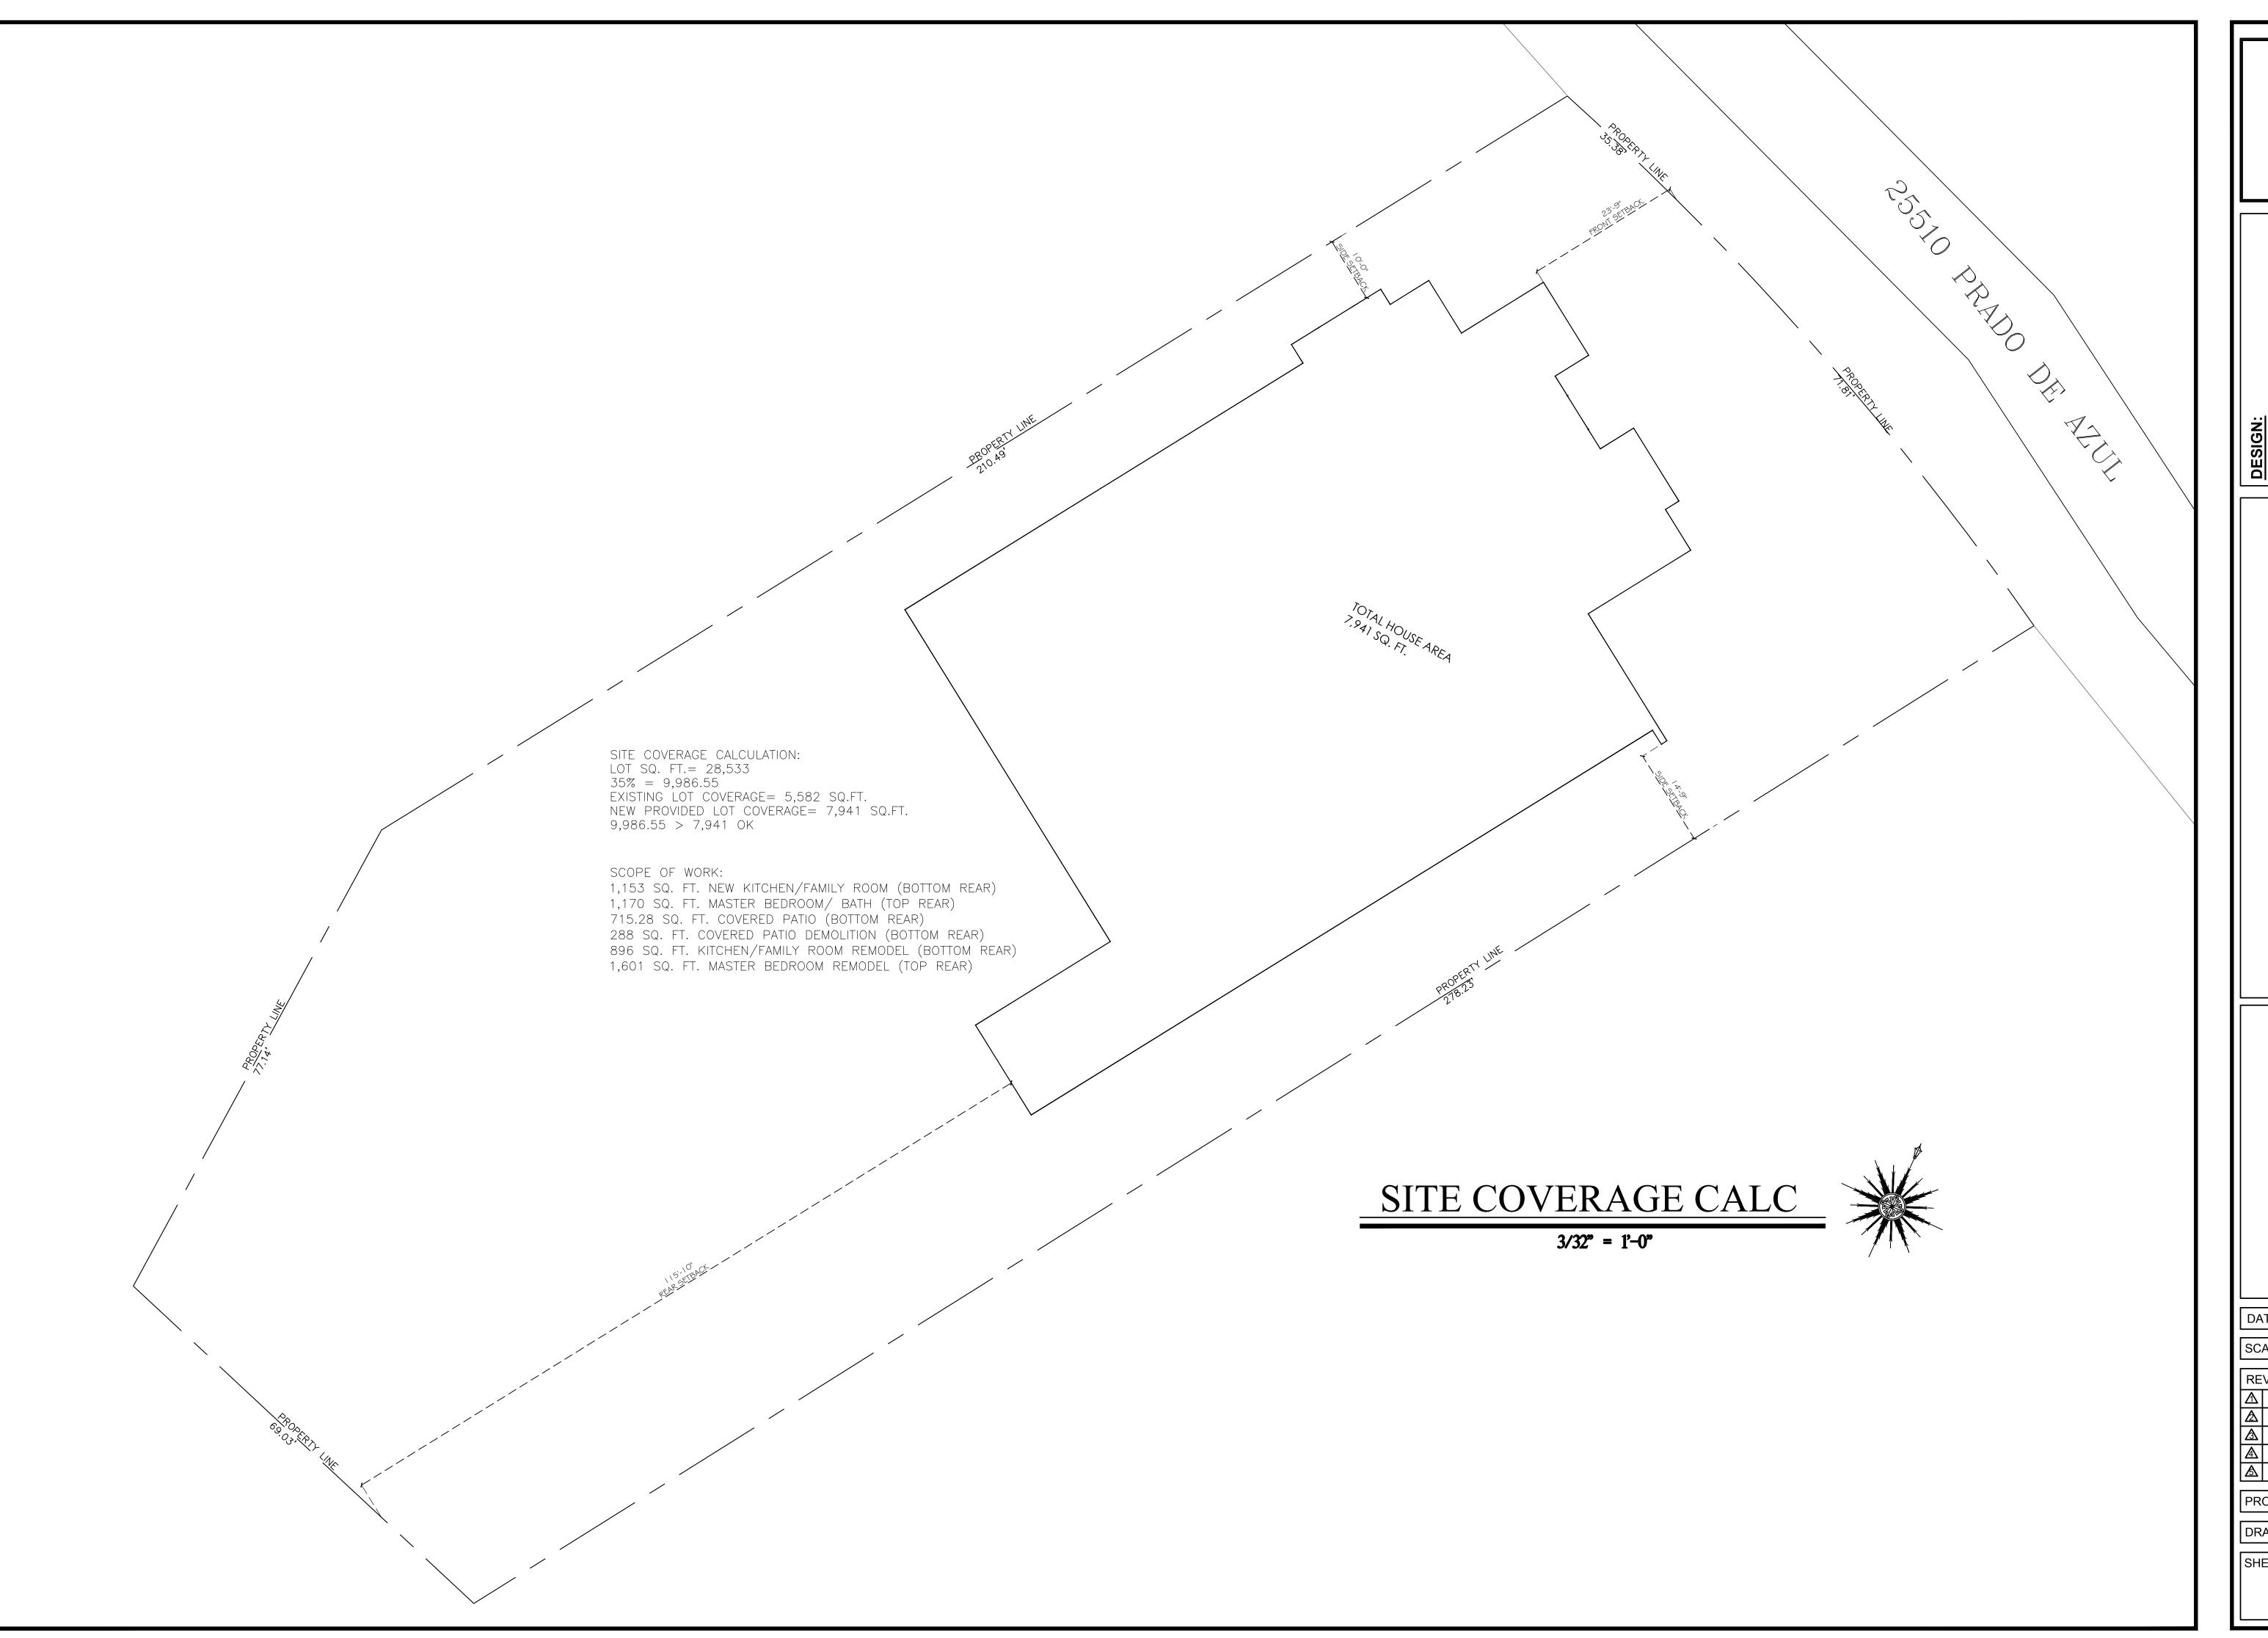




DESIGN:
C-OLIVEIRA DESIGN
3680 WILSHIRE BLVD, STE P04-1341
LOS ANGELES, CA 90010
213-357-2151
OFICCE@COLIVEIRADESIGN.COM
www.coliveiradesign.com

AZUL, 91302 CA CA 25510 PRADO | CALABASAS, (

02/17/2021 SCALE: 3/32" = 1'-0"

PROJECT #: 19-XXX

DRAWN BY: CO

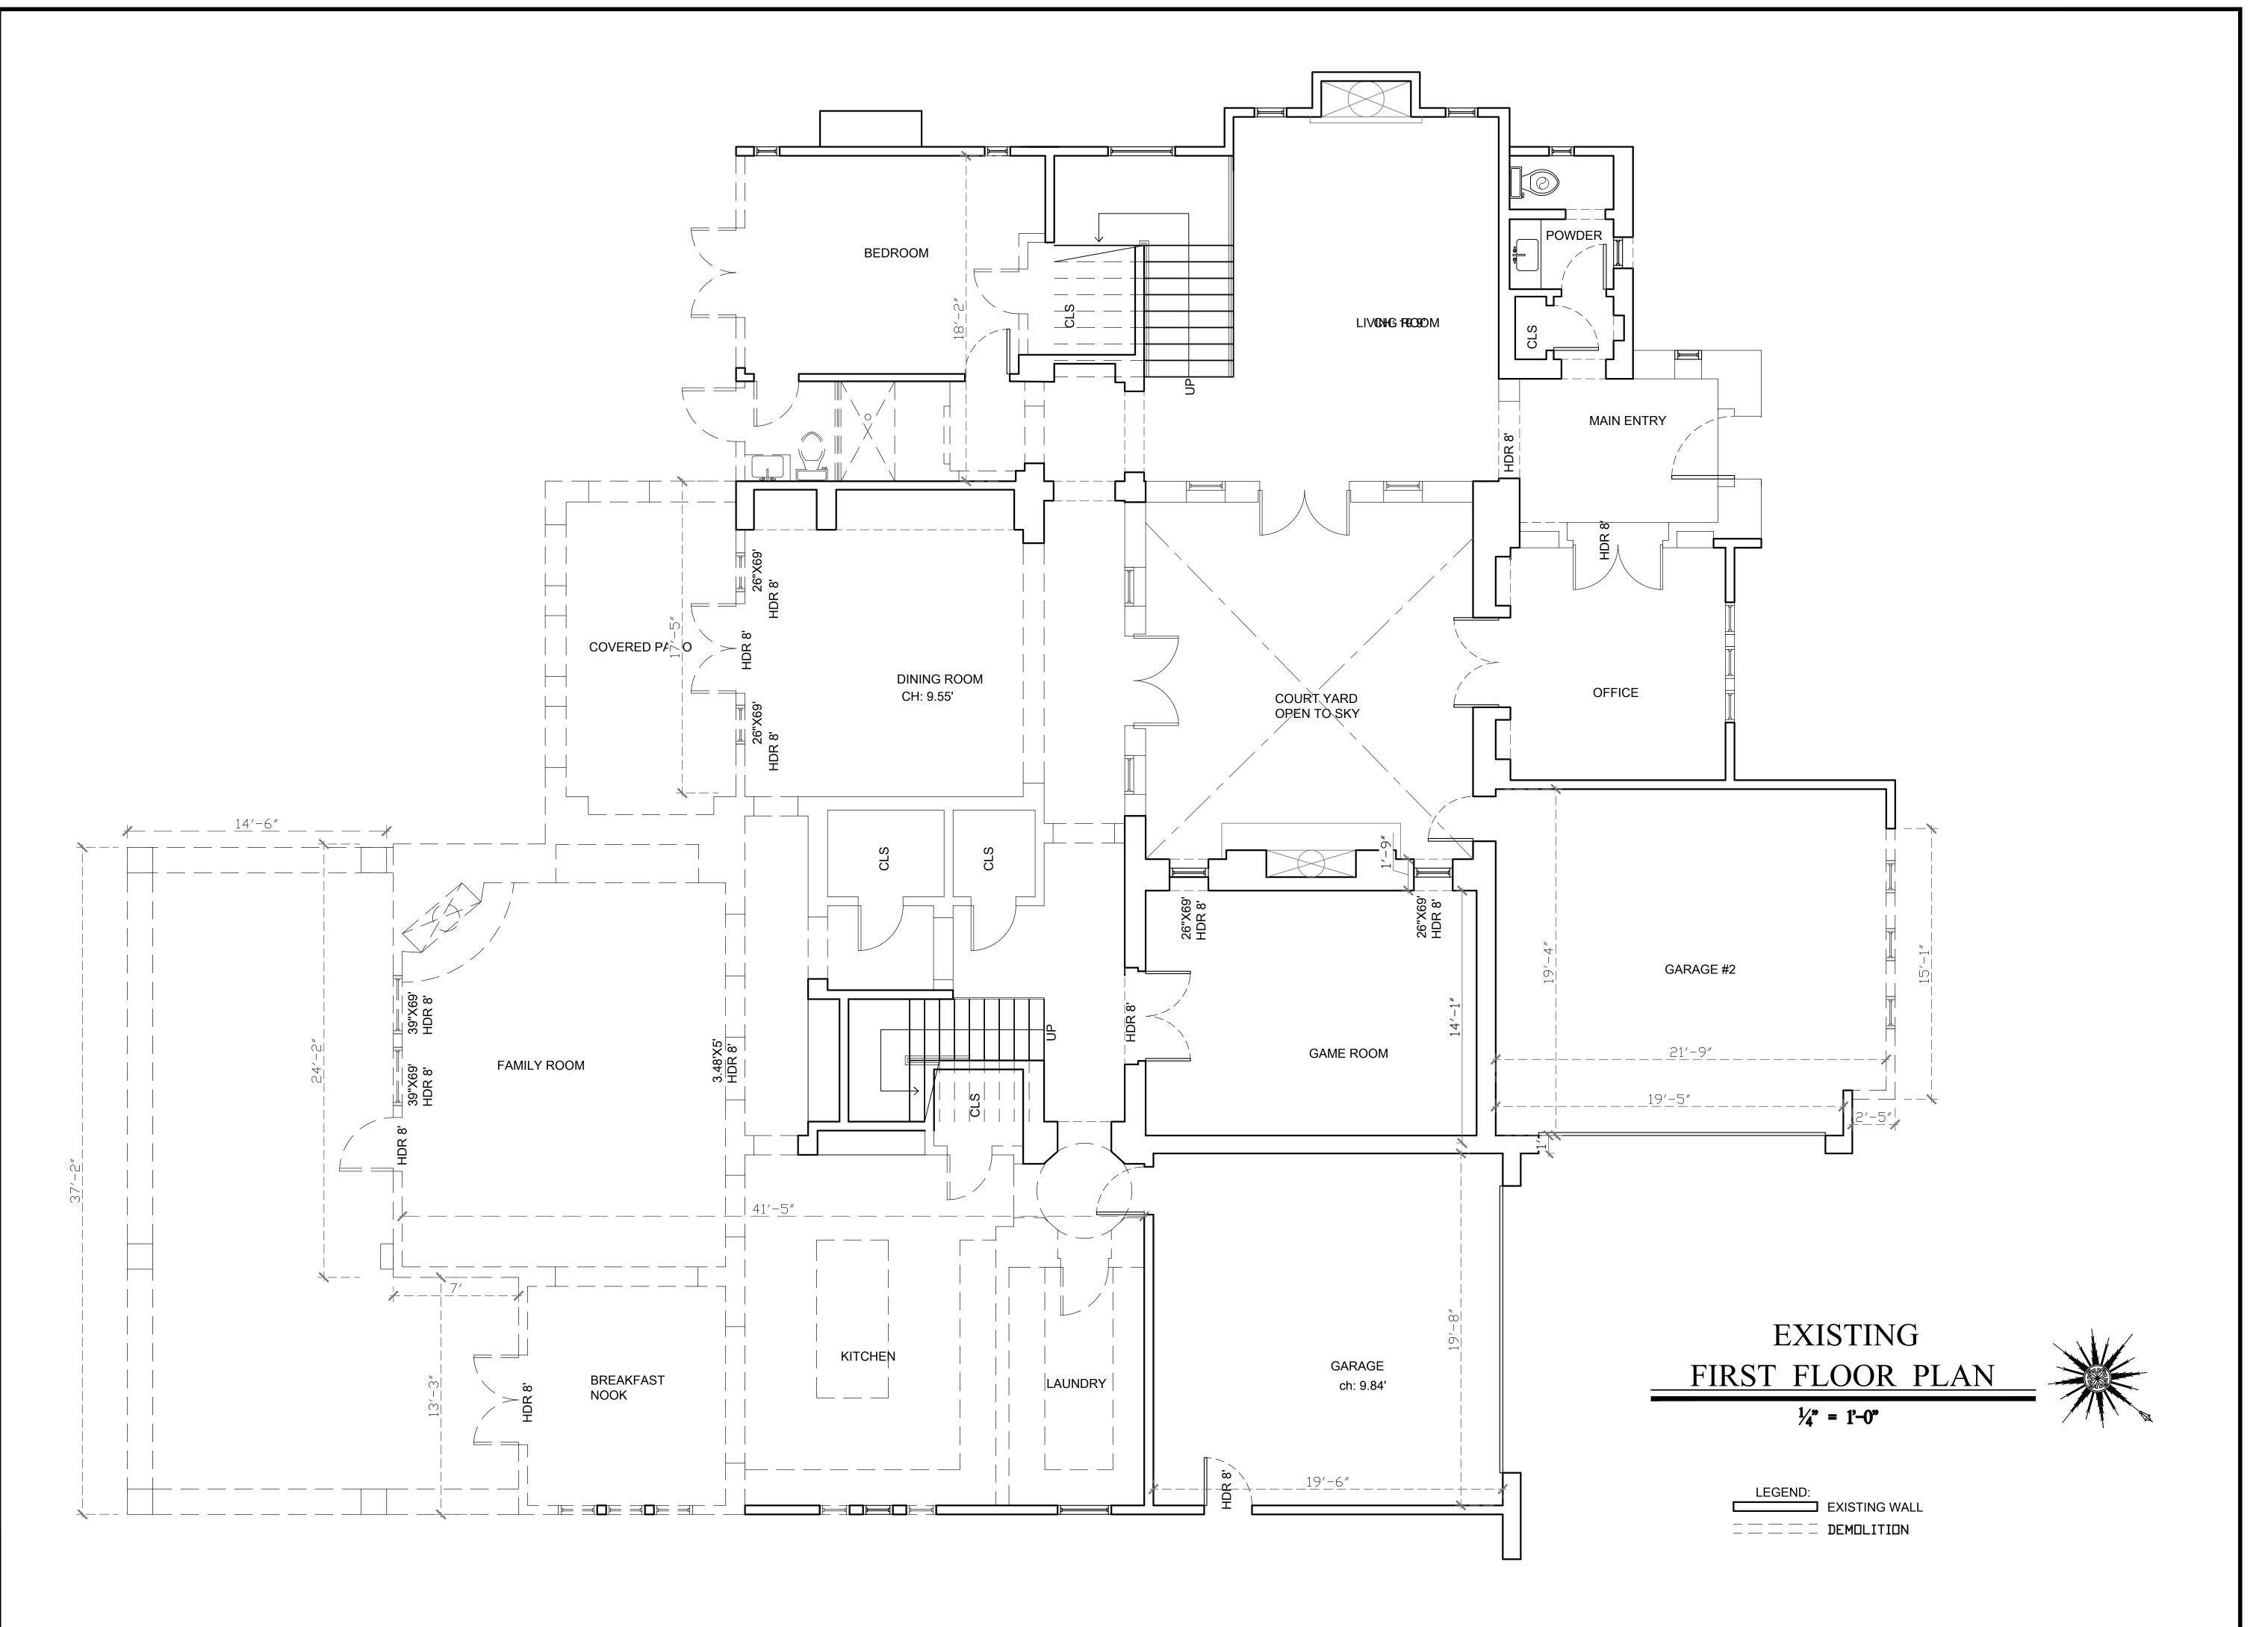



AZUL, 91302

25510 PRADO CALABASAS, (


EXISTING FIRST FLOOR PLAN

DATE: 09/27/2020

SCALE: 1/4" = 1'-0" REVISION:

PROJECT #: 19-XXX

DRAWN BY: CO

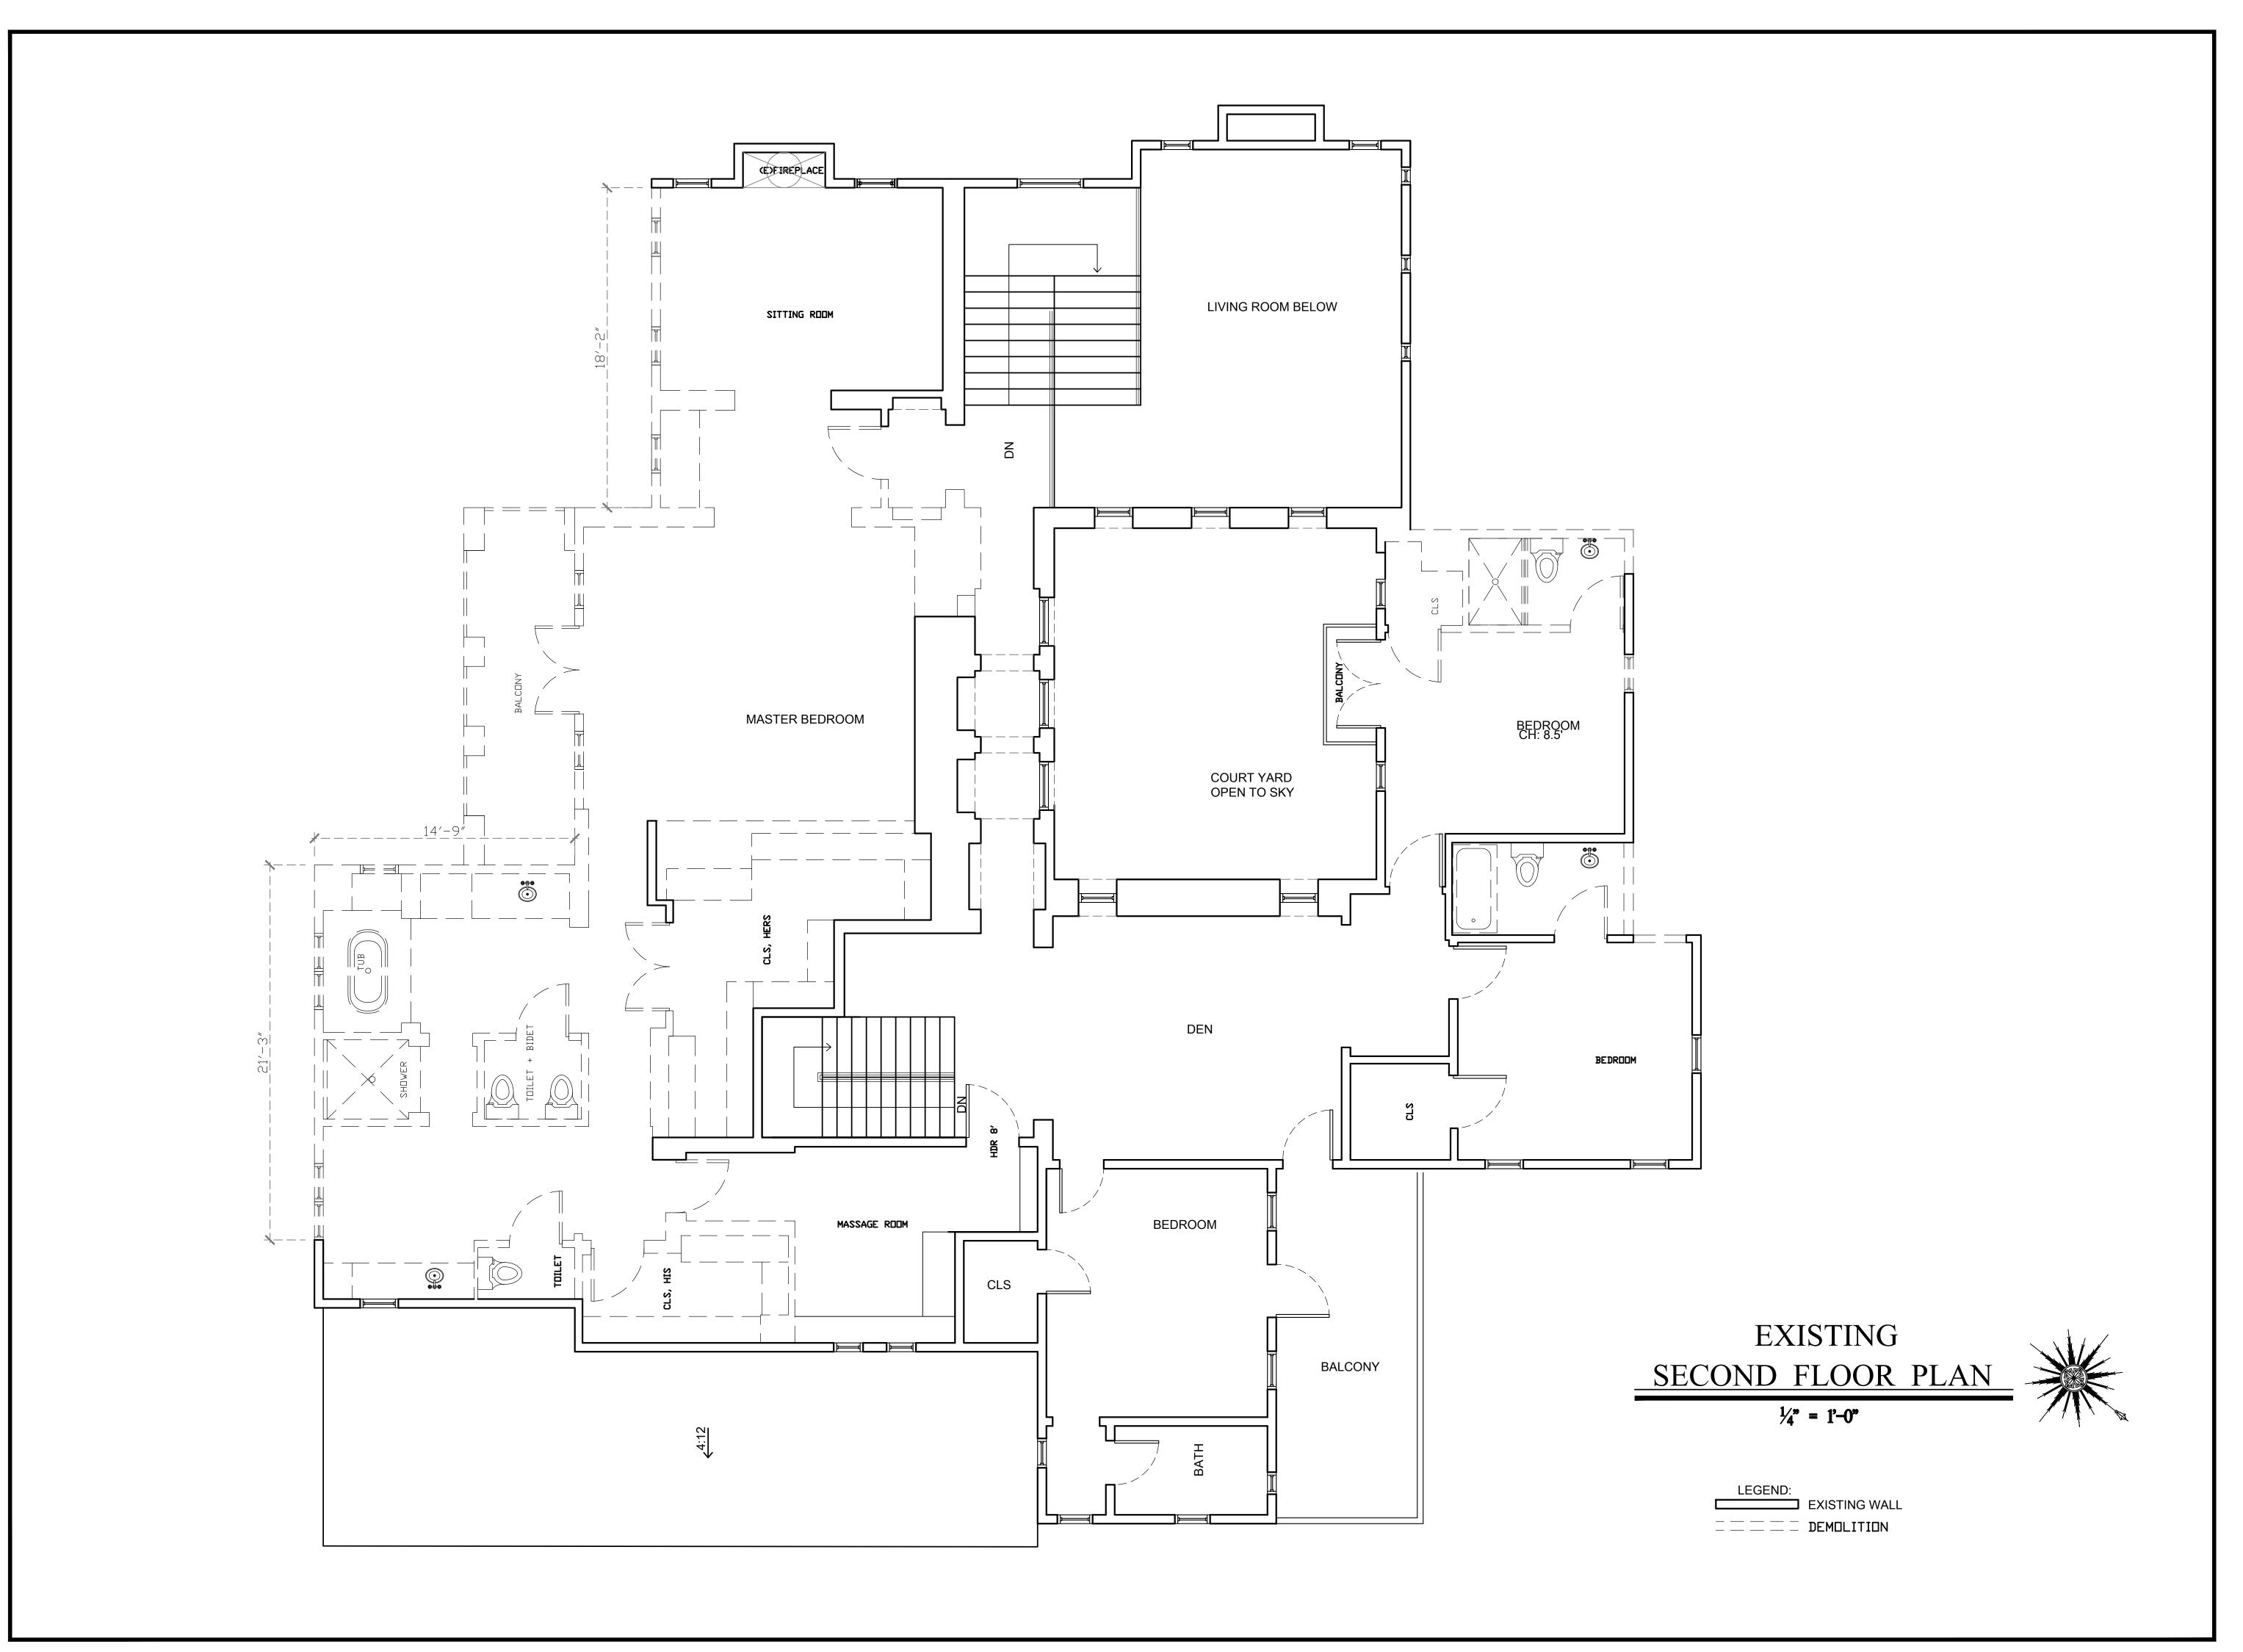




AZUL, 91302


25510 PRADO | CALABASAS, (

09/27/2020 SCALE: 1/4" = 1'-0"

REVISION: PROJECT #: 19-XXX

DRAWN BY: CO

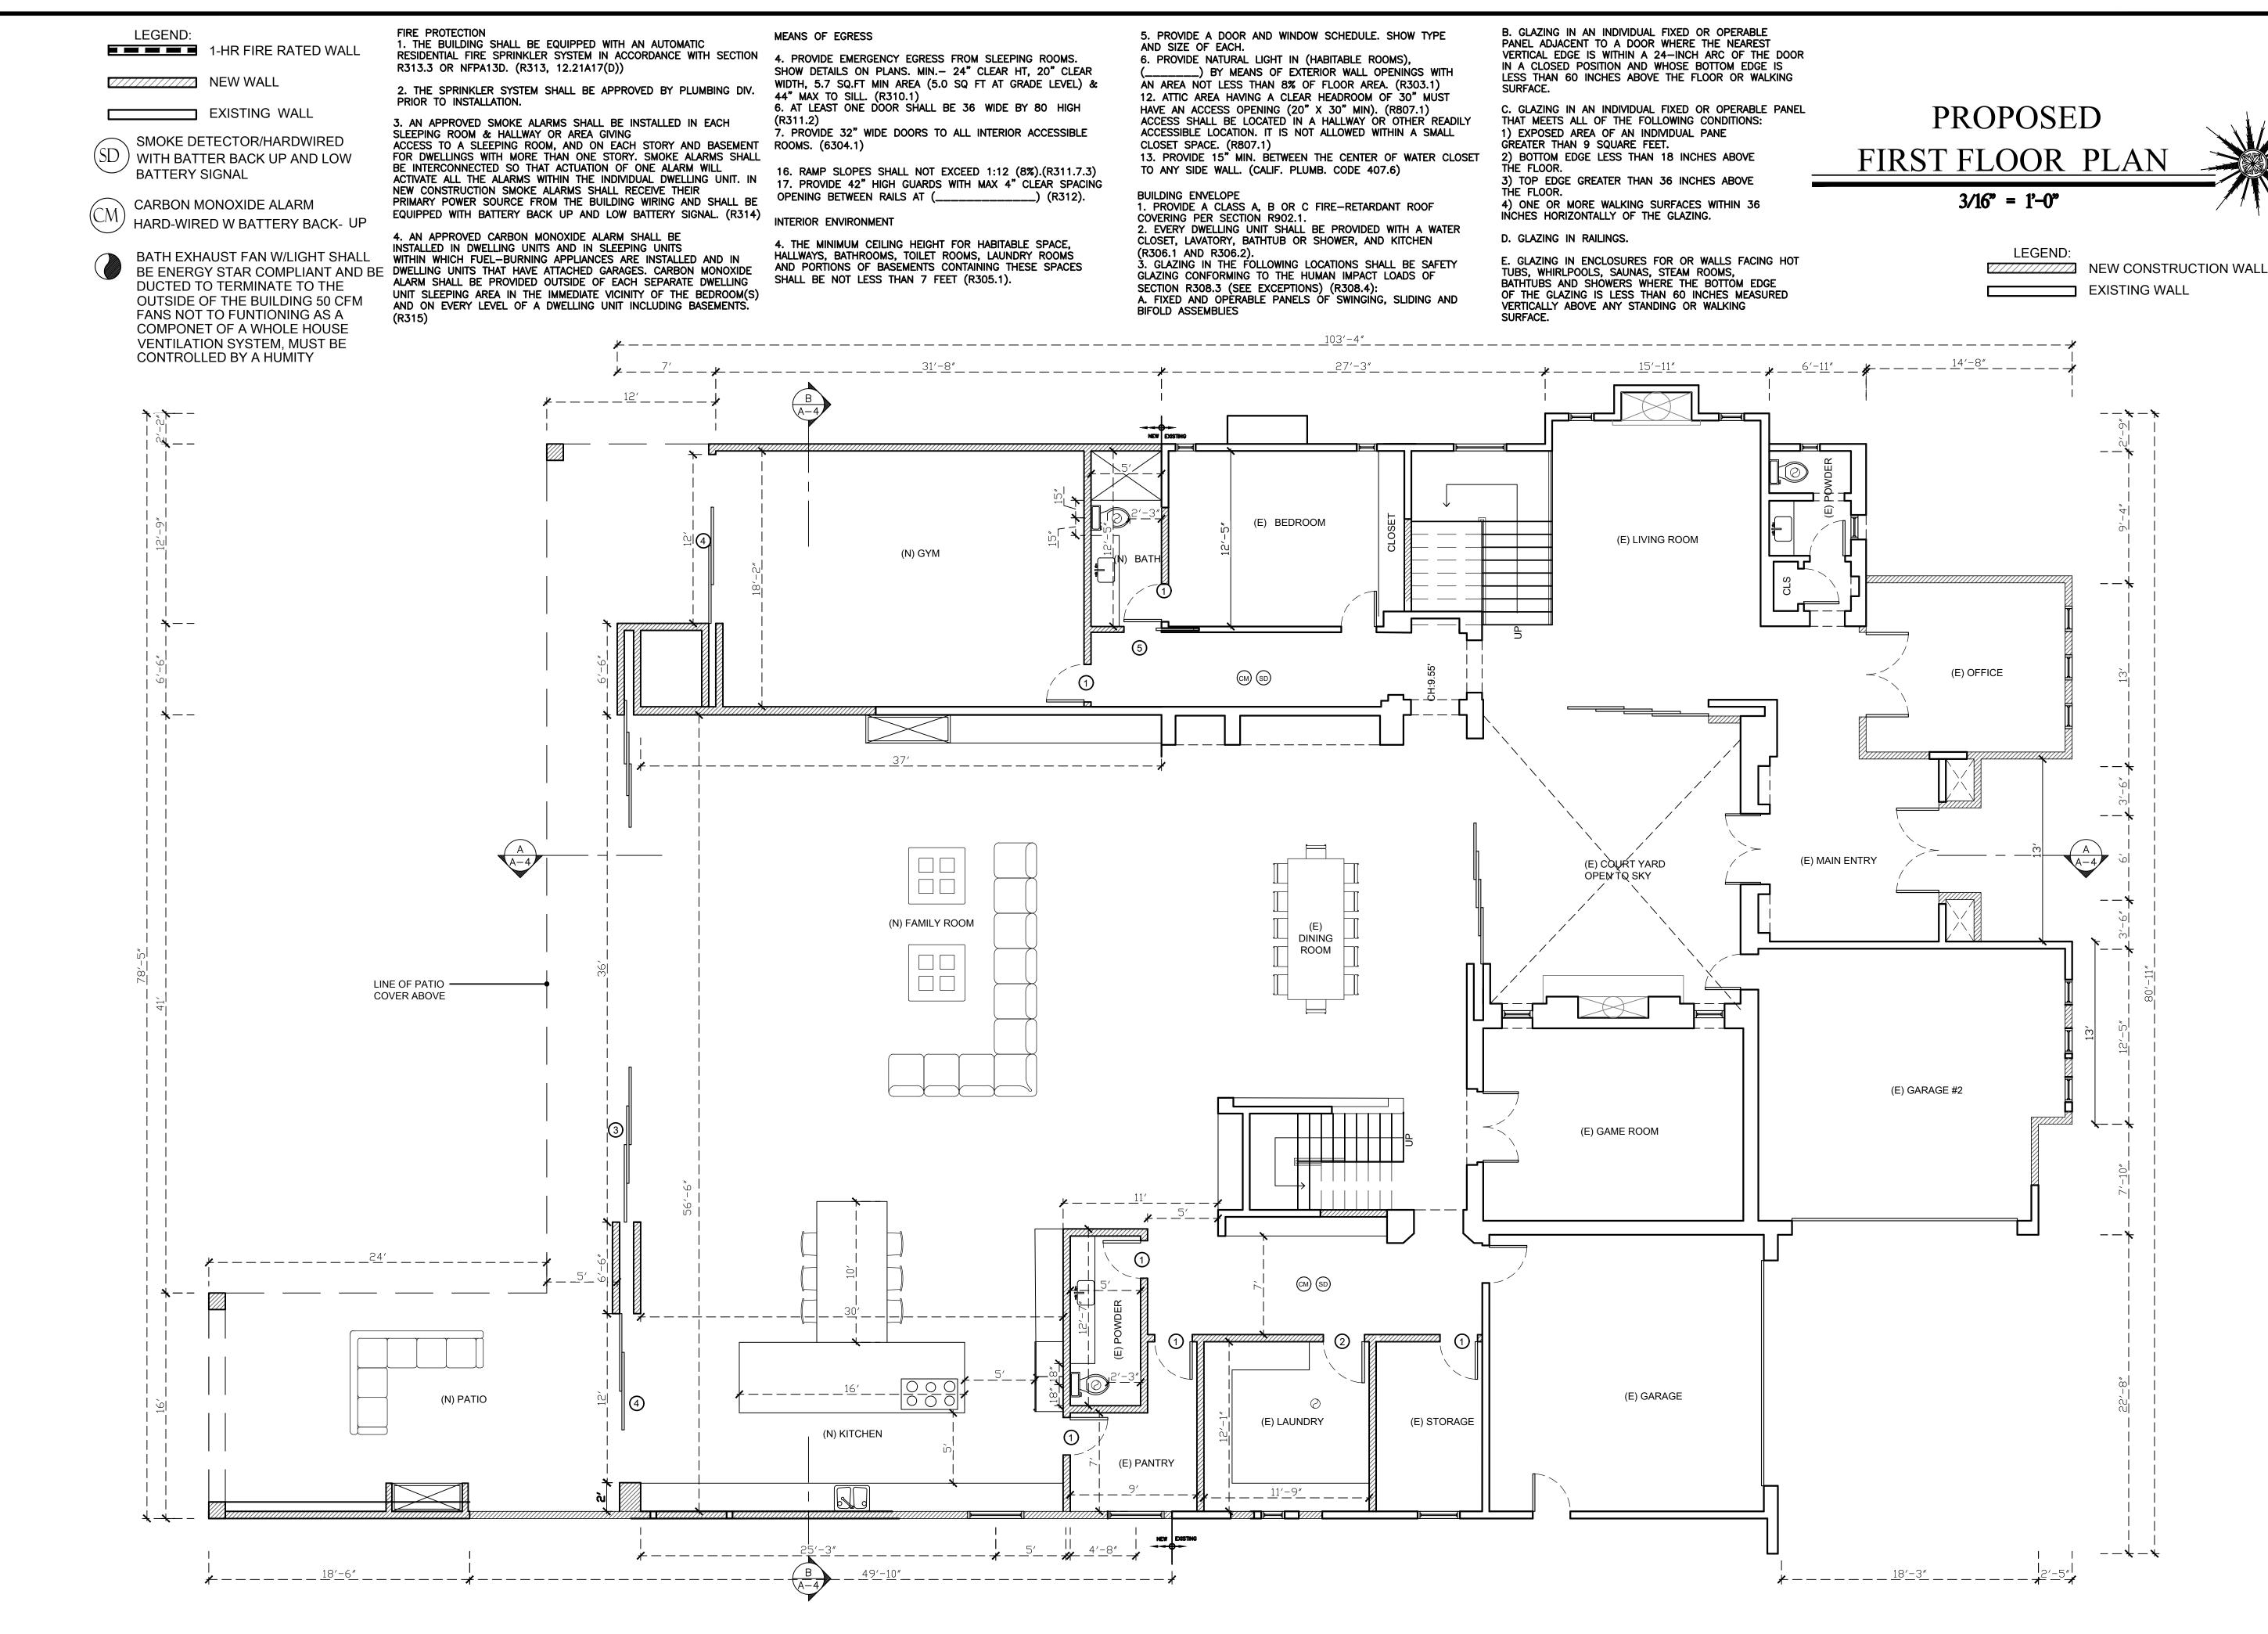

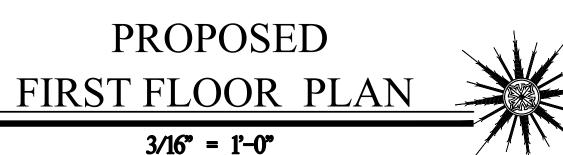

SIGN BLVD, STE CA 90010 EIRA DES ILSHIRE | GELES, (

> ZUL 302 0

1

0

2551 CAL

 \mathbf{m}

DATE: 09/27/2020 3/16" = 1'-0" SCALE:

REVISION:

PROJECT #: 19-XXX DRAWN BY: MS

SMOKE DETECTOR/HARDWIRED (SD) WITH BATTER BACK UP AND LOW BATTERY SIGNAL

CARBON MONOXIDE ALARM HARD-WIRED W BATTERY BACK-

BATH EXHAUST FAN W/LIGHT SHALL BE ENERGY STAR COMPLIANT AND BE DUCTED TO TERMINATE TO THE OUTSIDE OF THE BUILDING 50 CFM FANS NOT TO FUNTIONING AS A COMPONET OF A WHOLE HOUSE VENTILATION SYSTEM, MUST BE

F. GLAZING IN WALLS AND FENCES ADJACENT TO INDOOR AND OUTDOOR SWIMMING POOLS, HOT TUBS AND SPAS WHERE THE BOTTOM EDGE OF THE GLAZING IS LESS THAN 60 INCHES ABOVE A WALKING SURFACE AND WITHIN 60 INCHES, MEASURED HORIZONTALLY AND IN A STRAIGHT LINE, OF THE WATER S EDGE.

G. GLAZING ADJACENT TO STAIRWAYS, LANDINGS AND RAMPS WITHIN 36 INCHES HORIZONTALLY OF A WALKING SURFACE WHEN THE SURFACE OF THE GLAZING IS LESS THAN 60 INCHES ABOVE THE PLANE OF THE ADJACENT WALKING SURFACE.

H. GLAZING ADJACENT TO STAIRWAYS WITHIN 60 INCHES OF AWPA U1.
HORIZONTALLY OF THE BOTTOM TREAD OF A STAIRWAY IN ANY DIRECTION WHEN THE EXPOSED SURFACE OF THE GLAZING IS LESS THAN 60 INCHES ABOVE THE NOSE OF THE TREAD.

4. SKYLIGHTS AND SLOPED GLAZING SHALL COMPLY WITH

8. BUILDINGS SHALL HAVE APPROVED ADDRESS NUMBERS, BUILDING NUMBERS OR APPROVED BUILDING IDENTIFICATION PLACED IN A POSITION THAT IS PLAINLY LEGIBLE AND VISIBLE FROM THE STREET OR ROAD FRONTING THE PROPERTY. (R319)

9. PROTECTION OF WOOD AND WOOD BASED PRODUCTS FROM DECAY SHALL BE PROVIDED IN THE LOCATIONS SPECIFIED PER SECTION R317.1 BY THE USE OF NATURALLY DURABLE WOOD OR WOOD THAT IS PRESERVATIVE—TREATED IN ACCORDANCE WITH AWPA U1 FOR THE SPECIES, PRODUCT, PRESERVATIVE AND END USE. PRESERVATIVES SHALL BE LISTED IN SECTION 4

10. PROVIDE ANTI-GRAFFITI FINISH WITHIN THE FIRST 9 FEET, MEASURED FROM GRADE, AT EXTERIOR WALLS AND DOORS. EXCEPTION: MAINTENANCE OF BUILDING AFFIDAVIT IS
RECORDED BY THE OWNER TO COVENANT AND
AGREE WITH THE CITY OF LOS ANGELES TO
REMOVE ANY GRAFFITI WITHIN 7-DAYS OF THE GRAFFITI BEING APPLIED. (6306)


> MEW CONSTRUCTION WALL ☐ EXISTING WALL

PROPOSED SECOND FLOOR PLAN

 $3/16^{\circ} = 1'-0^{\circ}$





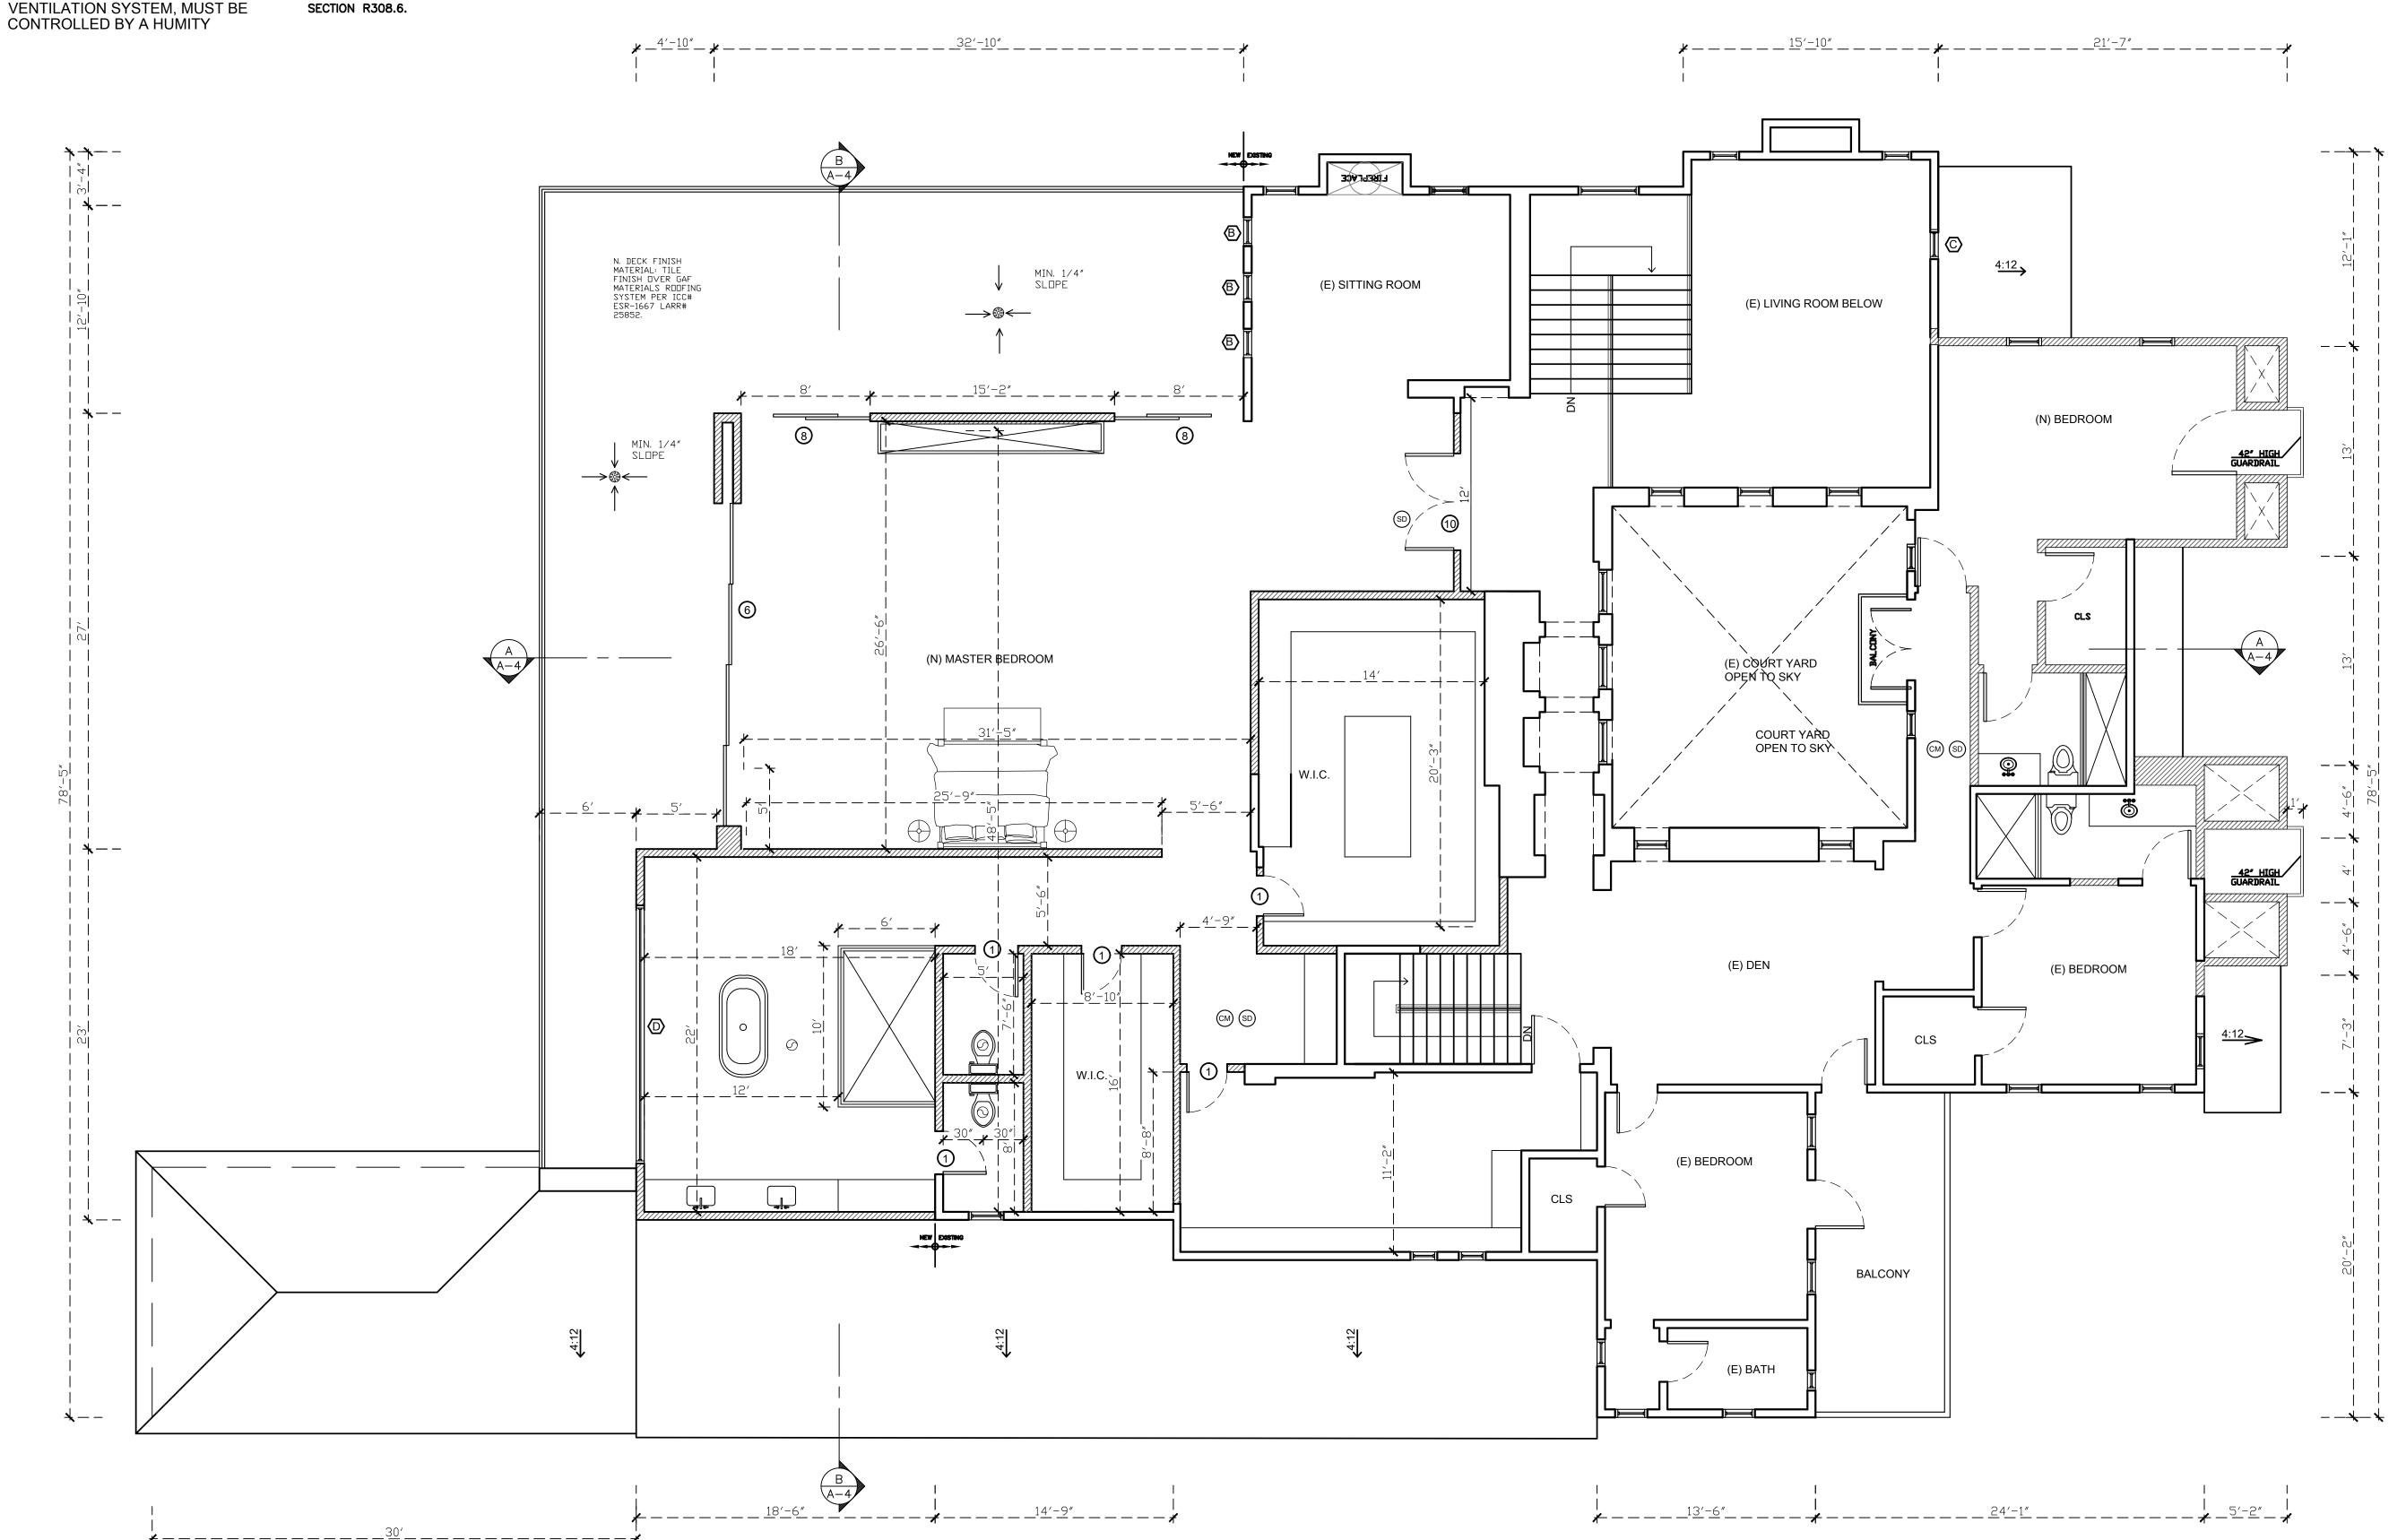



A DESIGN HIRE BLVD, STE ELES, CA 90010

AZUL, 91302 PR \Box 0 2551 CAL


09/27/2020 SCALE: 3/16" = 1'-0" REVISION: PROJECT #: 19-XXX DRAWN BY: MS

Note:

- 1. MINIMUM ROOF SLOPE OF 3/8" PER FOOT SHALL BE PROVIDED AT ANY POINT OF THE ROOF. PROVIDE UNIFORM SLOPE TOWARD DOWNSPOUTS AND/OR SCUPPERS AS INDICATED ON ROOF PLAN. (REFER TO DETAILS FOR DOWNSPOUTS AND SCUPPERS INCLUDED IN THIS DRAWINGS.)
- 2. INSULATIONS SHALL BE INSTALLED AT BOTTOM OF JOISTS OR FRAMING UNDER ENTIRE ROOF. USE R-30 INSULATION WITH VAPOR BARRIER.
- 3. CHECH & VERIFY LOCATIONS & EXACT SIZES OF ALL A/C EQUIPMENT, REQUIRED OPENINGS & SUPPORTS WITH A/C CONTRACTORS BEFORE FRAMING BEGINS. ANY REWORKING REQUIRED TO ACCOMODATE EQUIPMENT IN QUESTION SHALL BE DONE AT NO ADDITIONAL COST TO THE OWNER.
- 4. PAINT ALL ROOF EQUIPMENTS. ALL ROOF METAL SHALL RECEIVE TWO (2) COATS OF EXTERIOR SEMI GLOSS PAINT. VERIFY COLOR W/ARCHITECT.
- 5. TELEVISION ANTENNA CROSSARMS OR OTHER ROOF OBSTRUCTIONS SHALL BE LOCATED 20'-0" MIN. FROM EDGE OF ROOF & 7'-0" MIN. ABOVE ROOF.
- 6. PROVIDE ATTIC DRAFT STOPS AS REQUIRED (SEE ROOF PLAN & DETAILS). DRAFT STOPS SHALL DIVIDE ATTIC SPACES INTO AREAS NOT TO EXCEED 3,000 SQ. FT. PER UBC SEC.3205 (8). SEE DETAILS FOR WOOD & GYP. BOARD DRAFT STOPS. PROVIDE 2" X ___ WOOD FRAMING AS REQUIRED TO COMPLETE ITS CONSTRUCTION.
- 7. PROVIDE AN APPROVED SPARK ARRESTER FOR THE CHIMNEY OF A FIREPLACE, STOVE OR BARBECUE.
- 8. PROVIDE GRAVITY TYPE ATTIC VENTILATORS AT ROOF IF TRUSSES ARE NOT OF SOLID WEB CONSTRUCTION. WHEN ATTIC DRAFT STOP ARE REQUIRED PROVIDE TWO (2) ROOF GRAVITY VENTILATORS FOR EACH DIVISION.
- 9. CONTRACTOR TO CONFIRM THAT ALL AREAS ARE PROVIDED WITH POSITIVE DRAINAGE PRIOR TO SHEATHING THE ROOF.
- 10. CRICKET WITH 1/2" PLYWOOD OVER 2" X ___" SLEEPERS TYPICAL.
- 11. THE ROOFS FOR THE MAIN BUILDING AND THE EXISTING BUILDING ARE SPECIALIST TO VERIFY THAT:
- ALL EXISTING ROOFING MATERIALS AND INSTALLATION METHODS.
 ASSOCIATED FLASHINGS AND SHEET METAL HAVE BEEN
 PROPERLY INSTALLED
- THE ROOFS ARE TO BE FLOOD TESTED IN A MANNER APPROPIATE TO THE TYPE EXISTING ROOFING. SEE NOTE 12 BELOW.

 ANY DEFICIENCIES OR LEAK CONDITIONS ARE TO BE
- ANY DEFICIENCIES OR LEAK CONDITIONS ARE TO BE CORRECTED. A PERIOD OF ONE YEAR FROM THE TIME OF PROJECT ACCEPTANCE BY THE TENANT.
- 12. ROOF FLOOD TEST TO BE CONDUCTED IN THE PRESENCE OF THE BULDING OWNER AND THE TENANT. CONTRACTOR PROVIDE MIN. 96 HRS. NOTICE TO BOTH PARTIES.
- 13. ATTIC NET VENTILATION AREA RATIO IS 1/150 OF ATTIC AREA, VENTS WITH THE BALANCE OF THE REQUIRED VENTILATION PROVIDED BY THE EAVE VENTS. OPENINGS SHALL HAVE 1/4 INCH CORROSION RESISTANT METAL MESH COVERING.
- 14. ATTIC AREA HAVING A CLEAR HEADROOM OF 30" MUST HAVE AN ACCESS OPENING (20"X30" MIN). (R807.1)
 - *PROVIDE RAIN GUTTERS AND CONVEY RAIN WATER TO THE STREET.

 *1/2" CDX PLY W/8D @ 6"/6"/12" WITH RADIANT BARRIER (COMMON NAILS).
- 15. CLASS A ROOF COVERING IS REQUIRED FOR ALL BUILDINGS. WOOD SHAKES AND SHINGLES ARE NOT PERMITTED. (7207.4, 1505)
- 16. VALLEY FLASHINGS SHALL NOT BE LESS THAN 0.019-INCH (0.48MM) (NO. 26 GALVANIZED SHEET GAGE) CORROSION-RESISTANT METAL INSTALLED OVER A MINIMUM 36-INCH-WIDE (914MM) UNDERLAYMENT CONSISTING OF ONE LAYER OF NO. 72 ASTM CAP SHEET RUNNING THE FULL LENGHT OF THE VALLEY (705A.3)
- 17. ROOF GUTTERS SHALL BE PROVIDED WITH THE MEANS TO PREVENT THE ACCUMULATION OF LEAVES AND DEBRIS IN THE GUTTER. (705A.4)
- 18. (ROOF) (ATTIC) (EXTERIOR WALL) VENTS SHALL RESIST THE INTRUSION OF FLAME AND EMBERS INTO THE ATTIC AREA OF THE STRUCTURE, OR SHALL BE PROTECTED BY CORROSION— RESISTANT, NONCOMBUSTIBLE WIRE MESH WITH 1/4—INCH (6MM) OPENINGS OR ITS EQUIVALENT. VENTS SHALL NOT BE INSTALLED IN EAVES AND CORNICES (706A.1, 706A.2, 706A.3, 7207.3).

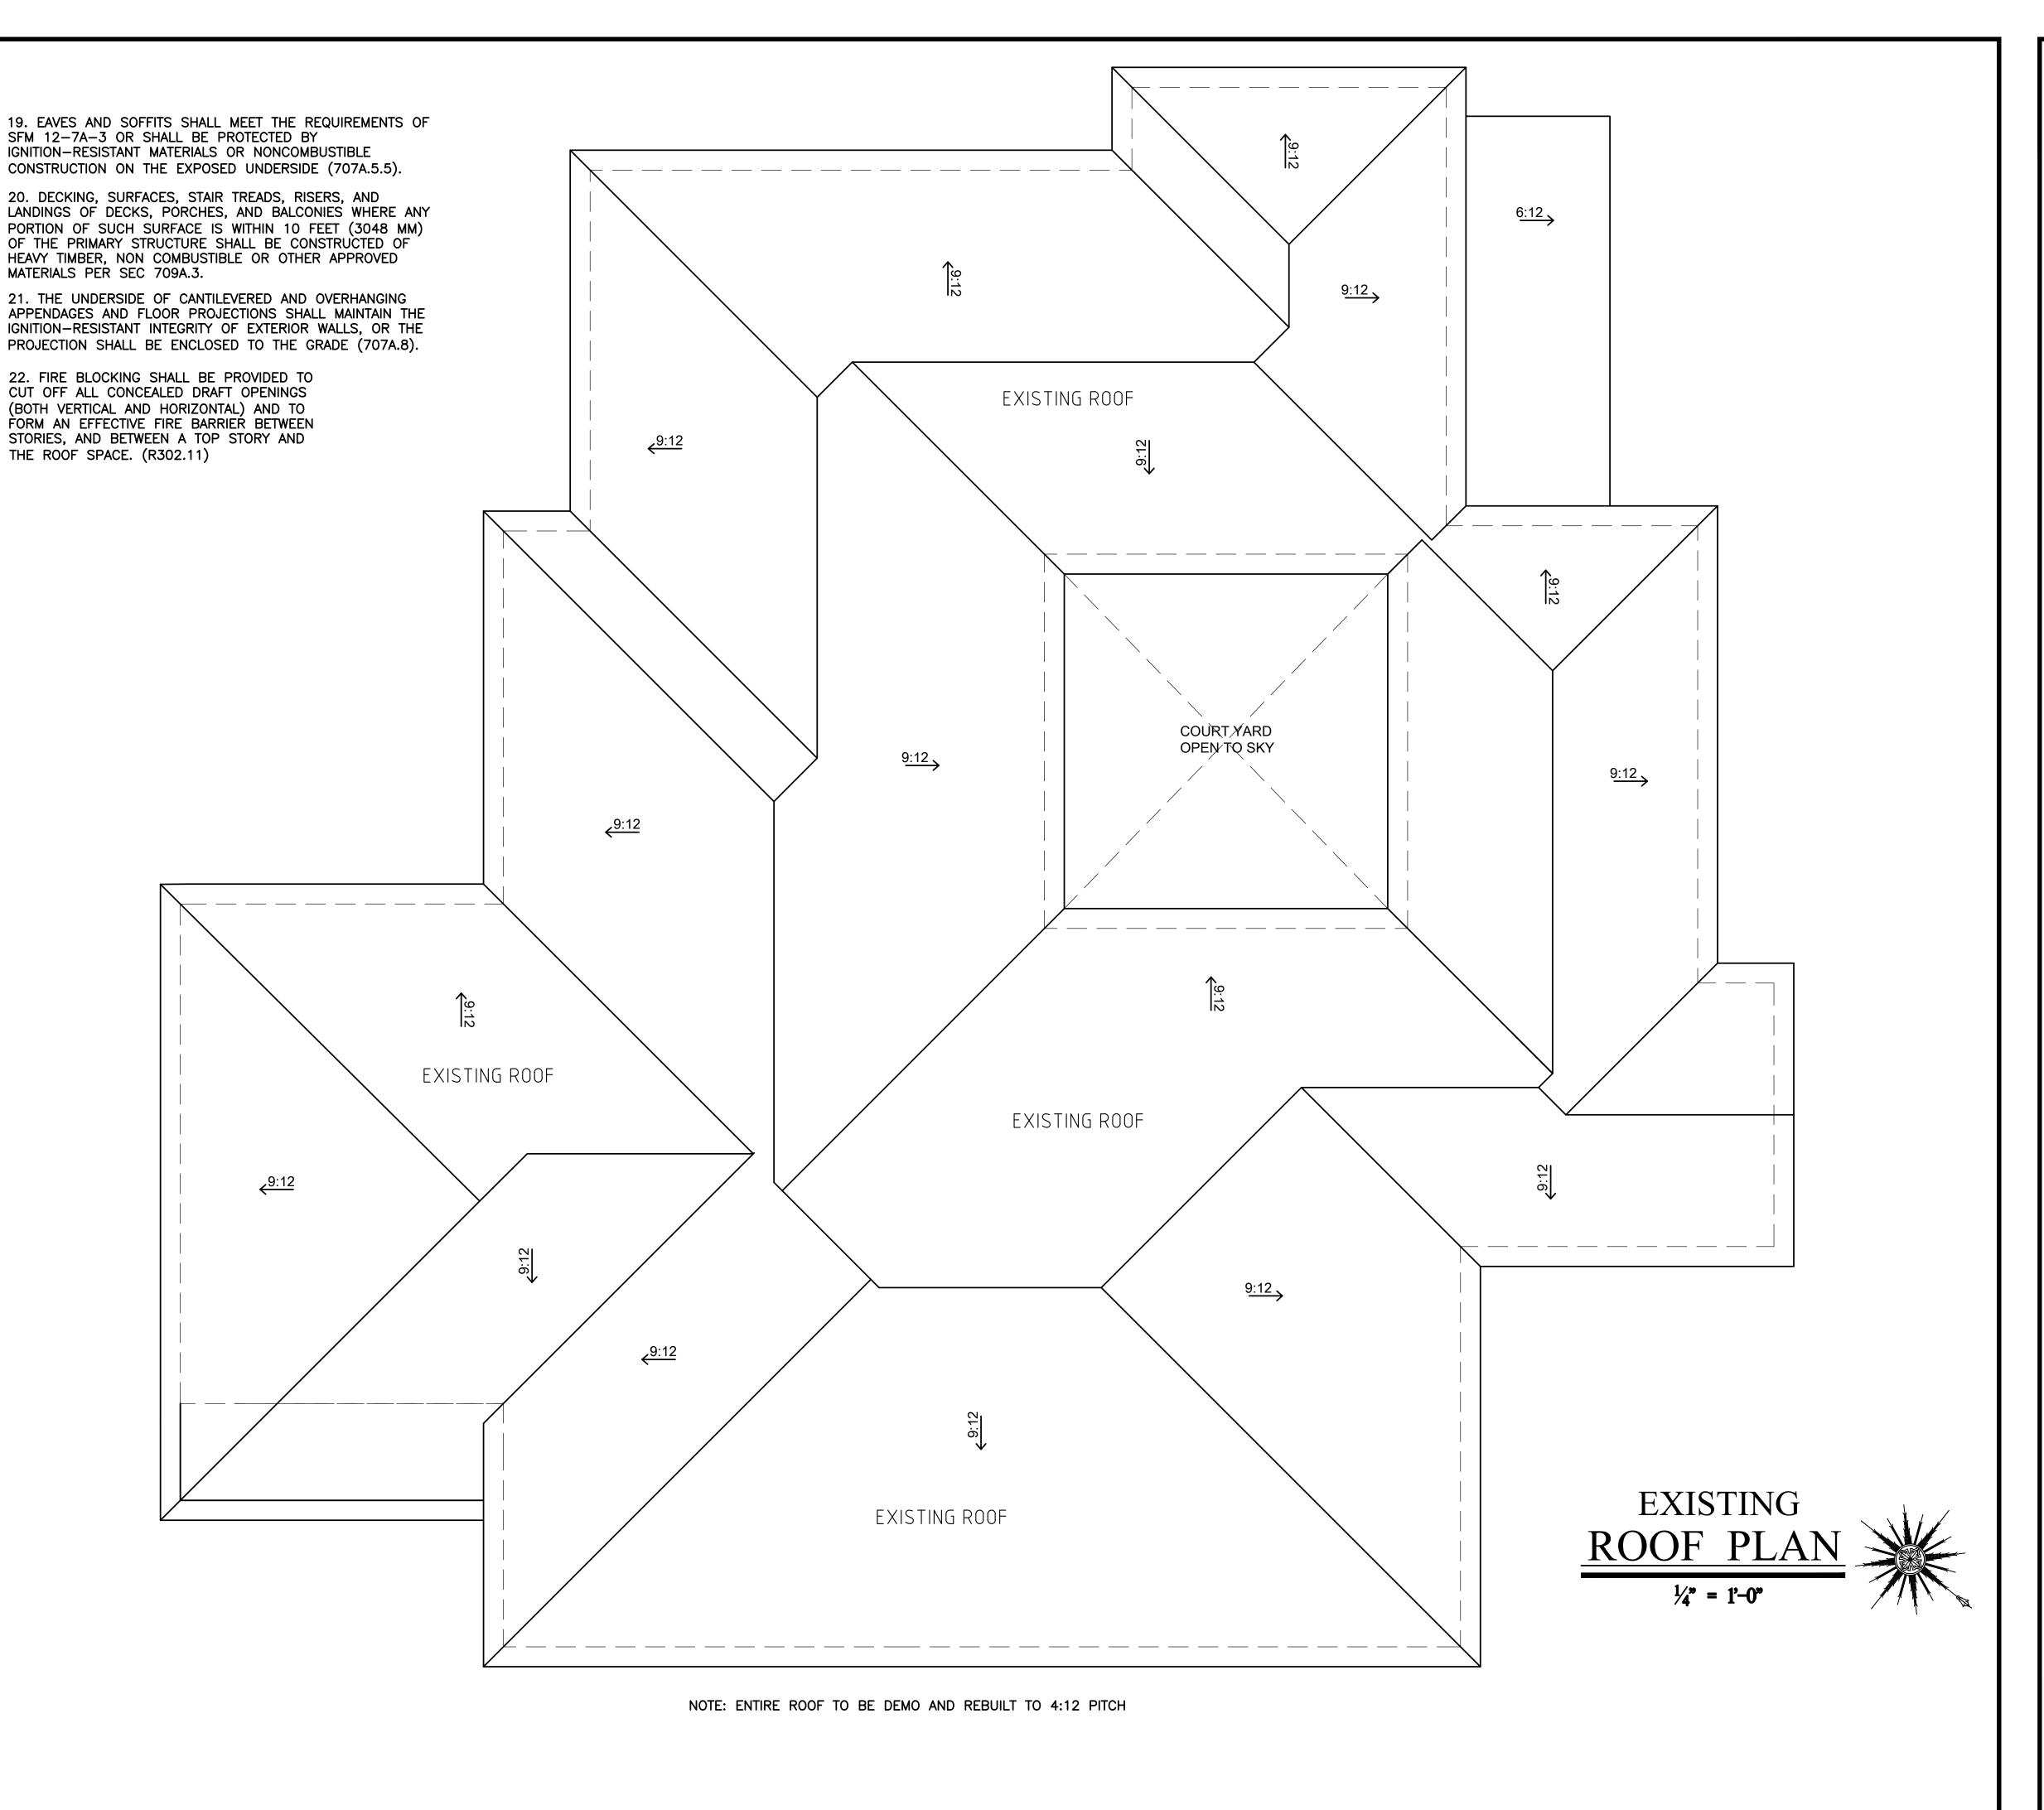



RA DESIGN SHIRE BLVD, STE P04-13 ELES, CA 90010 151 COLIVEIRADESIGN.CON

DESIGN:
C-OLIVEIRA DESIG
3680 WILSHIRE BL
LOS ANGELES, CA
213-357-2151
OFICCE@COLIVEI

25510 PRADO DE AZUL CALABASAS, CA 91302

EXISTING ROOF PLAN

DATE:	02/17/2021
SCALE:	1/4" = 1'-0"

DRAWN BY: CO

SHEET

A3

2. INSULATIONS SHALL BE INSTALLED AT BOTTOM OF JOISTS OR FRAMING UNDER ENTIRE ROOF. USE R-30 INSULATION WITH VAPOR BARRIER.

3. CHECH & VERIFY LOCATIONS & EXACT SIZES OF ALL A/C EQUIPMENT, REQUIRED OPENINGS & SUPPORTS WITH A/C CONTRACTORS BEFORE FRAMING BEGINS. ANY REWORKING REQUIRED TO ACCOMODATE EQUIPMENT IN QUESTION SHALL BE DONE AT NO ADDITIONAL COST TO THE OWNER.

4. PAINT ALL ROOF EQUIPMENTS. ALL ROOF METAL SHALL RECEIVE TWO (2) COATS OF EXTERIOR SEMI GLOSS PAINT. VERIFY COLOR W/ARCHITECT.

5. TELEVISION ANTENNA CROSSARMS OR OTHER ROOF OBSTRUCTIONS SHALL BE LOCATED 20'-0" MIN. FROM EDGE OF ROOF & 7'-0" MIN. ABOVE ROOF.

6. PROVIDE ATTIC DRAFT STOPS AS REQUIRED (SEE ROOF PLAN & DETAILS). DRAFT STOPS SHALL DIVIDE ATTIC SPACES INTO AREAS NOT TO EXCEED 3,000 SQ. FT. PER UBC SEC.3205 (8). SEE DETAILS FOR WOOD & GYP. BOARD DRAFT STOPS. PROVIDE 2" X ___ WOOD FRAMING AS REQUIRED TO COMPLETE ITS CONSTRUCTION.

7. PROVIDE AN APPROVED SPARK ARRESTER FOR THE CHIMNEY OF A FIREPLACE, STOVE OR BARBECUE.

8. PROVIDE GRAVITY TYPE ATTIC VENTILATORS AT ROOF IF TRUSSES ARE NOT OF SOLID WEB CONSTRUCTION. WHEN ATTIC DRAFT STOP ARE REQUIRED PROVIDE TWO (2) ROOF GRAVITY VENTILATORS FOR EACH DIVISION.

9. CONTRACTOR TO CONFIRM THAT ALL AREAS ARE PROVIDED WITH POSITIVE DRAINAGE PRIOR TO SHEATHING THE ROOF.

10. CRICKET WITH 1/2" PLYWOOD OVER 2" X ___" SLEEPERS TYPICAL.

11. THE ROOFS FOR THE MAIN BUILDING AND THE EXISTING BUILDING ARE SPECIALIST TO VERIFY THAT:

ALL EXISTING ROOFING MATERIALS AND INSTALLATION METHODS.
ASSOCIATED FLASHINGS AND SHEET METAL HAVE BEEN
PROPERLY INSTALLED

THE ROOFS ARE TO BE FLOOD TESTED IN A MANNER APPROPIATE TO THE TYPE EXISTING ROOFING. SEE NOTE 12 BELOW.

ANY DEFICIENCIES OR LEAK CONDITIONS ARE TO BE CORRECTED. A PERIOD OF ONE YEAR FROM THE TIME OF PROJECT ACCEPTANCE BY THE TENANT.

12. ROOF FLOOD TEST TO BE CONDUCTED IN THE PRESENCE OF THE BULDING OWNER AND THE TENANT. CONTRACTOR PROVIDE MIN. 96 HRS. NOTICE TO BOTH PARTIES.

13. ATTIC NET VENTILATION AREA RATIO IS 1/150 OF ATTIC AREA, VENTS WITH THE BALANCE OF THE REQUIRED VENTILATION PROVIDED BY THE EAVE VENTS. OPENINGS SHALL HAVE 1/4 INCH CORROSION RESISTANT METAL MESH COVERING.

14. ATTIC AREA HAVING A CLEAR HEADROOM OF 30" MUST HAVE AN ACCESS OPENING (20"X30" MIN). (R807.1)

*PROVIDE RAIN GUTTERS AND CONVEY RAIN WATER TO THE STREET.


*1/2" CDX PLY W/8D @ 6"/6"/12" WITH RADIANT BARRIER (COMMON NAILS).


19. EAVES AND SOFFITS SHALL MEET THE REQUIREMENTS OF SFM 12-7A-3 OR SHALL BE PROTECTED BY IGNITION—RESISTANT MATERIALS OR NONCOMBUSTIBLE CONSTRUCTION ON THE EXPOSED UNDERSIDE (707A.5.5).

20. DECKING, SURFACES, STAIR TREADS, RISERS, AND LANDINGS OF DECKS, PORCHES, AND BALCONIES WHERE ANY PORTION OF SUCH SURFACE IS WITHIN 10 FEET (3048 MM) OF THE PRIMARY STRUCTURE SHALL BE CONSTRUCTED OF HEAVY TIMBER, NON COMBUSTIBLE OR OTHER APPROVED MATERIALS PER SEC 709A.3.

21. THE UNDERSIDE OF CANTILEVERED AND OVERHANGING APPENDAGES AND FLOOR PROJECTIONS SHALL MAINTAIN THE IGNITION—RESISTANT INTEGRITY OF EXTERIOR WALLS, OR THE PROJECTION SHALL BE ENCLOSED TO THE GRADE (707A.8).

22. FIRE BLOCKING SHALL BE PROVIDED TO CUT OFF ALL CONCEALED DRAFT OPENINGS (BOTH VERTICAL AND HORIZONTAL) AND TO FORM AN EFFECTIVE FIRE BARRIER BETWEEN STORIES, AND BETWEEN A TOP STORY AND THE ROOF SPACE. (R302.11)

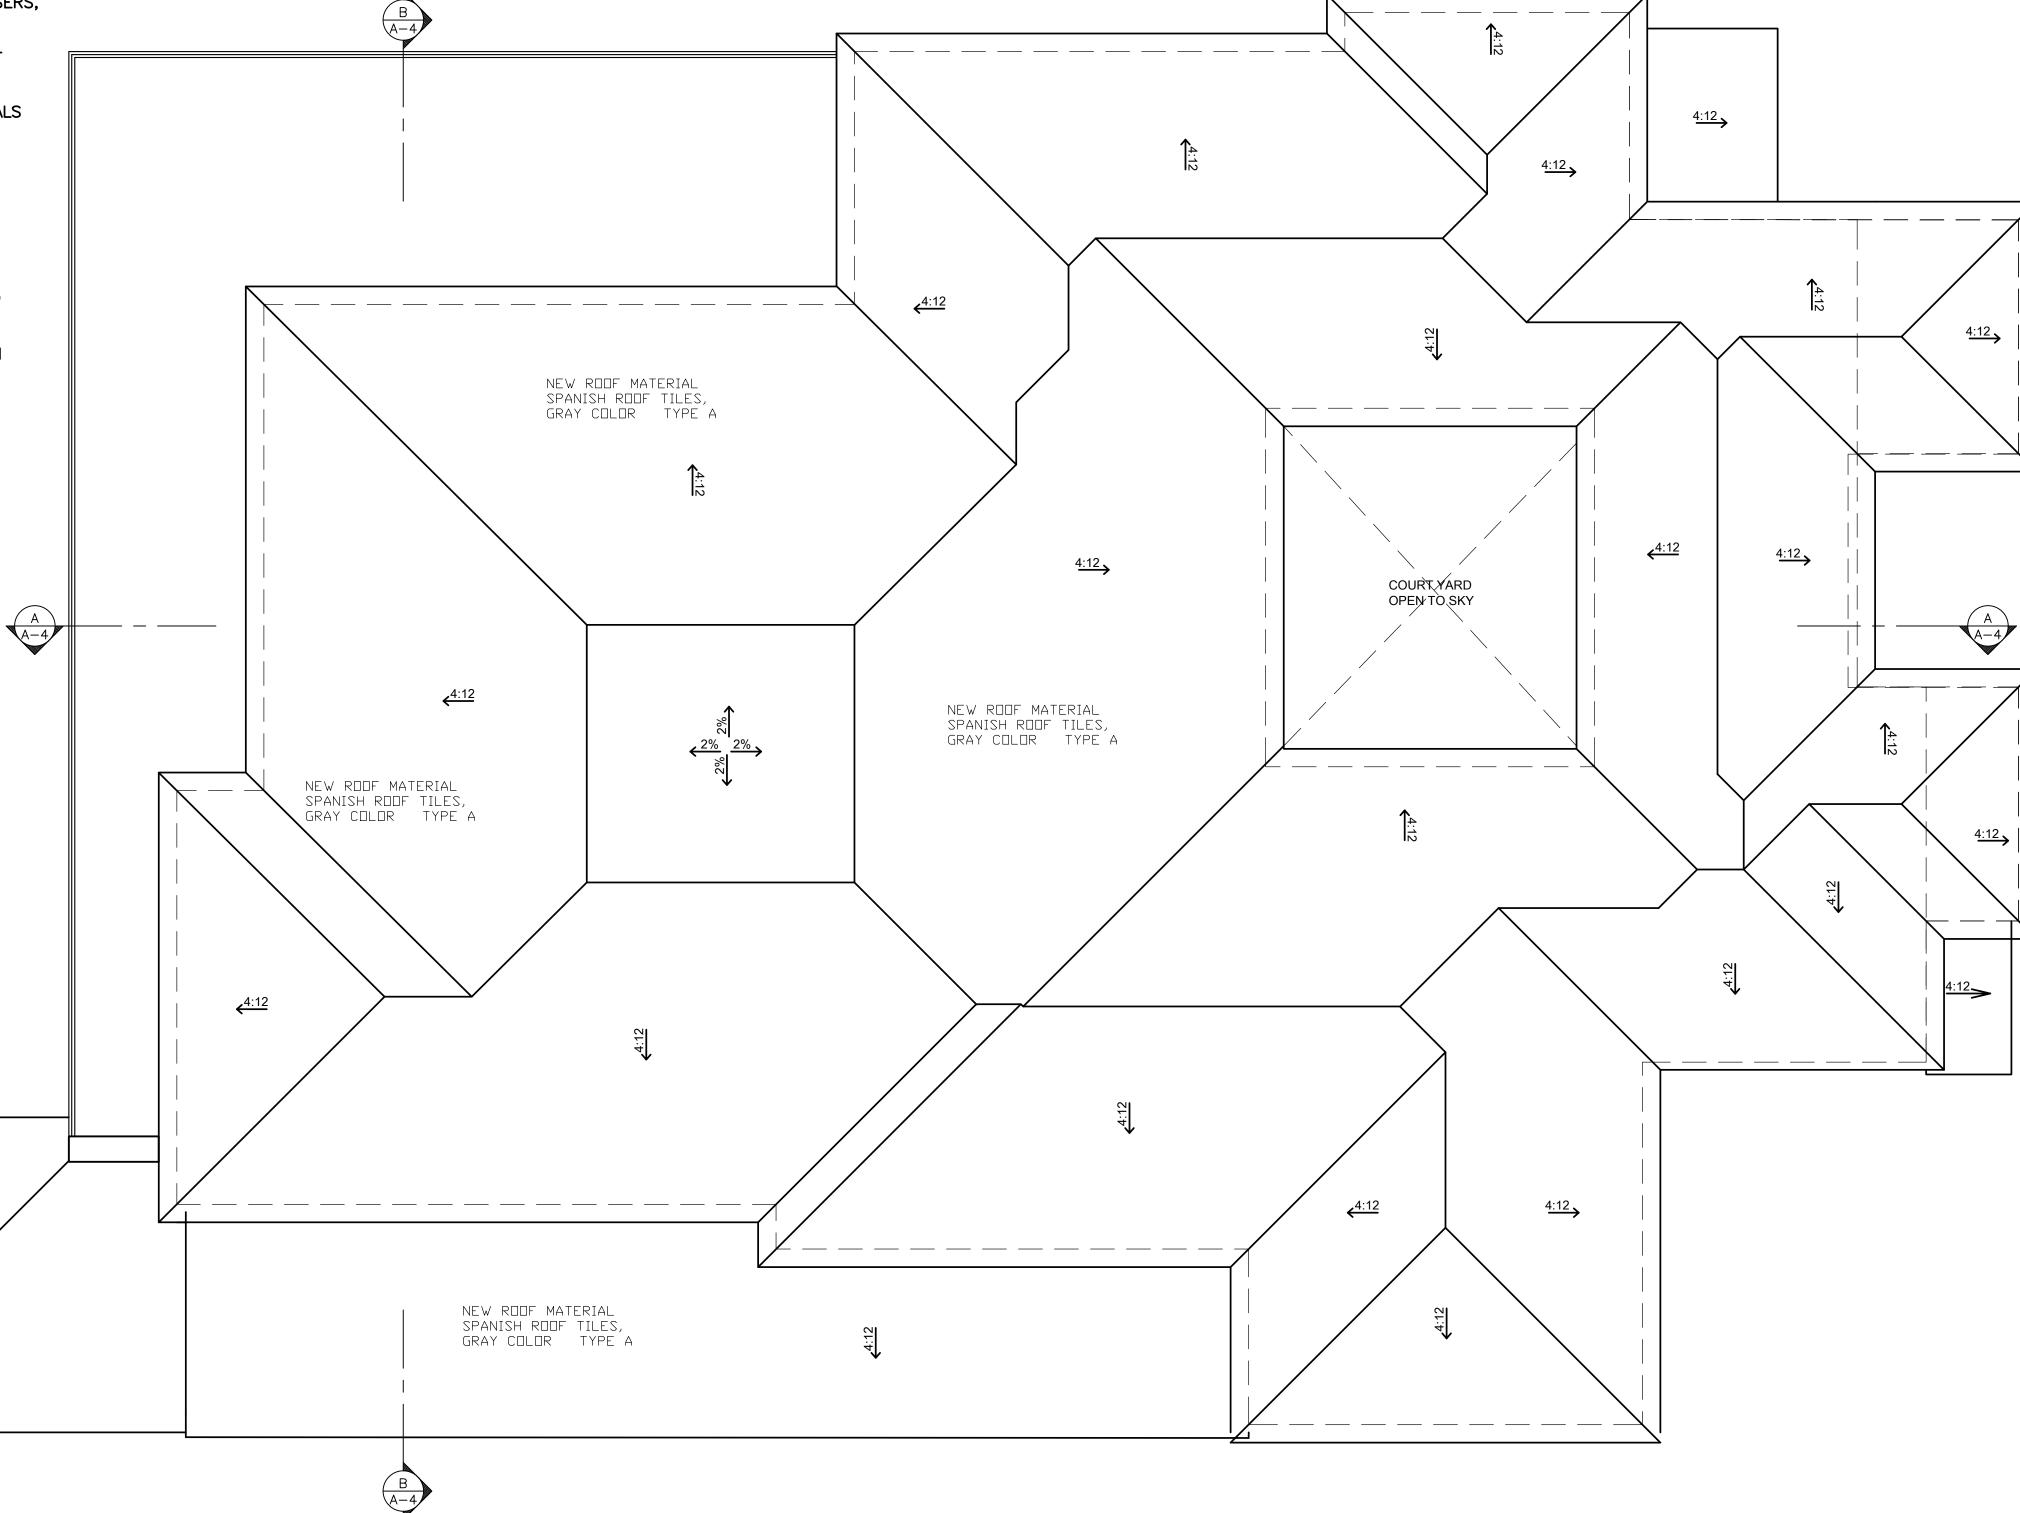

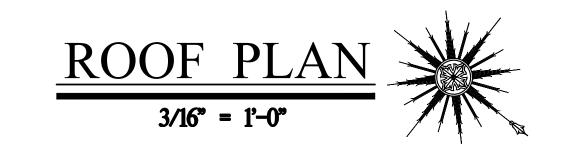



A DESIGN HIRE BLVD, STE P04-134 LES, CA 90010 51 COLIVEIRADESIGN.COM

DESIGN:
C-OLIVEIRA DESIGN
3680 WILSHIRE BLVC
LOS ANGELES, CA 90
213-357-2151
OFICCE@COLIVEIRA
www.coliveiradesign.ca

25510 PRADO DE AZUL CALABASAS, CA 91302

ROOF PLAN

DATE: 09/27/2020 SCALE: 3/16" = 1'-0"

REVISION:

A

A

A

PROJECT #: 19-XXX

DRAWN BY: MS

SHEET A3.



C-OLIVEIRA DESIGN
3680 WILSHIRE BLVD, STE P04-3680 ANGELES, CA 90010
213-357-2151
OFICCE@COLIVEIRADESIGN.CO

25510 PRADO DE AZUL, CALABASAS, CA 91302

EXISTING ELEVATIONS





SO WILSHIRE BLVD, STE P04-1341 S ANGELES, CA 90010 3-357-2151 ICCE@COLIVEIRADESIGN.COM w.coliveiradesign.com

25510 PRADO DE AZUL, CALABASAS, CA 91302

EXISTING ELEVATIONS

DATE: 02/17/2021

SCALE: 1/4" = 1'-0"

REVISION:

REVISION:

A

A

A

A

A

A

PROJECT #: 19-XXX

DRAWN BY: CO

A4.1







/EIRA DESIGN /ILSHIRE BLVD, STE F \GELES, CA 90010 7-2151

AZUL, 91302 DE CA 25510 PRADO | CALABASAS, (

PROPOSED ELEVATIONS

DA	TE:	09/27/2020					
SC	ALE:	1/4" = 1'-0"					
RE	VISION:						
Λ							
◬							
⅓							
A							
⋬							
PR	OJECT #:	19	9-XXX				
DR	AWN BY:	M	IS				

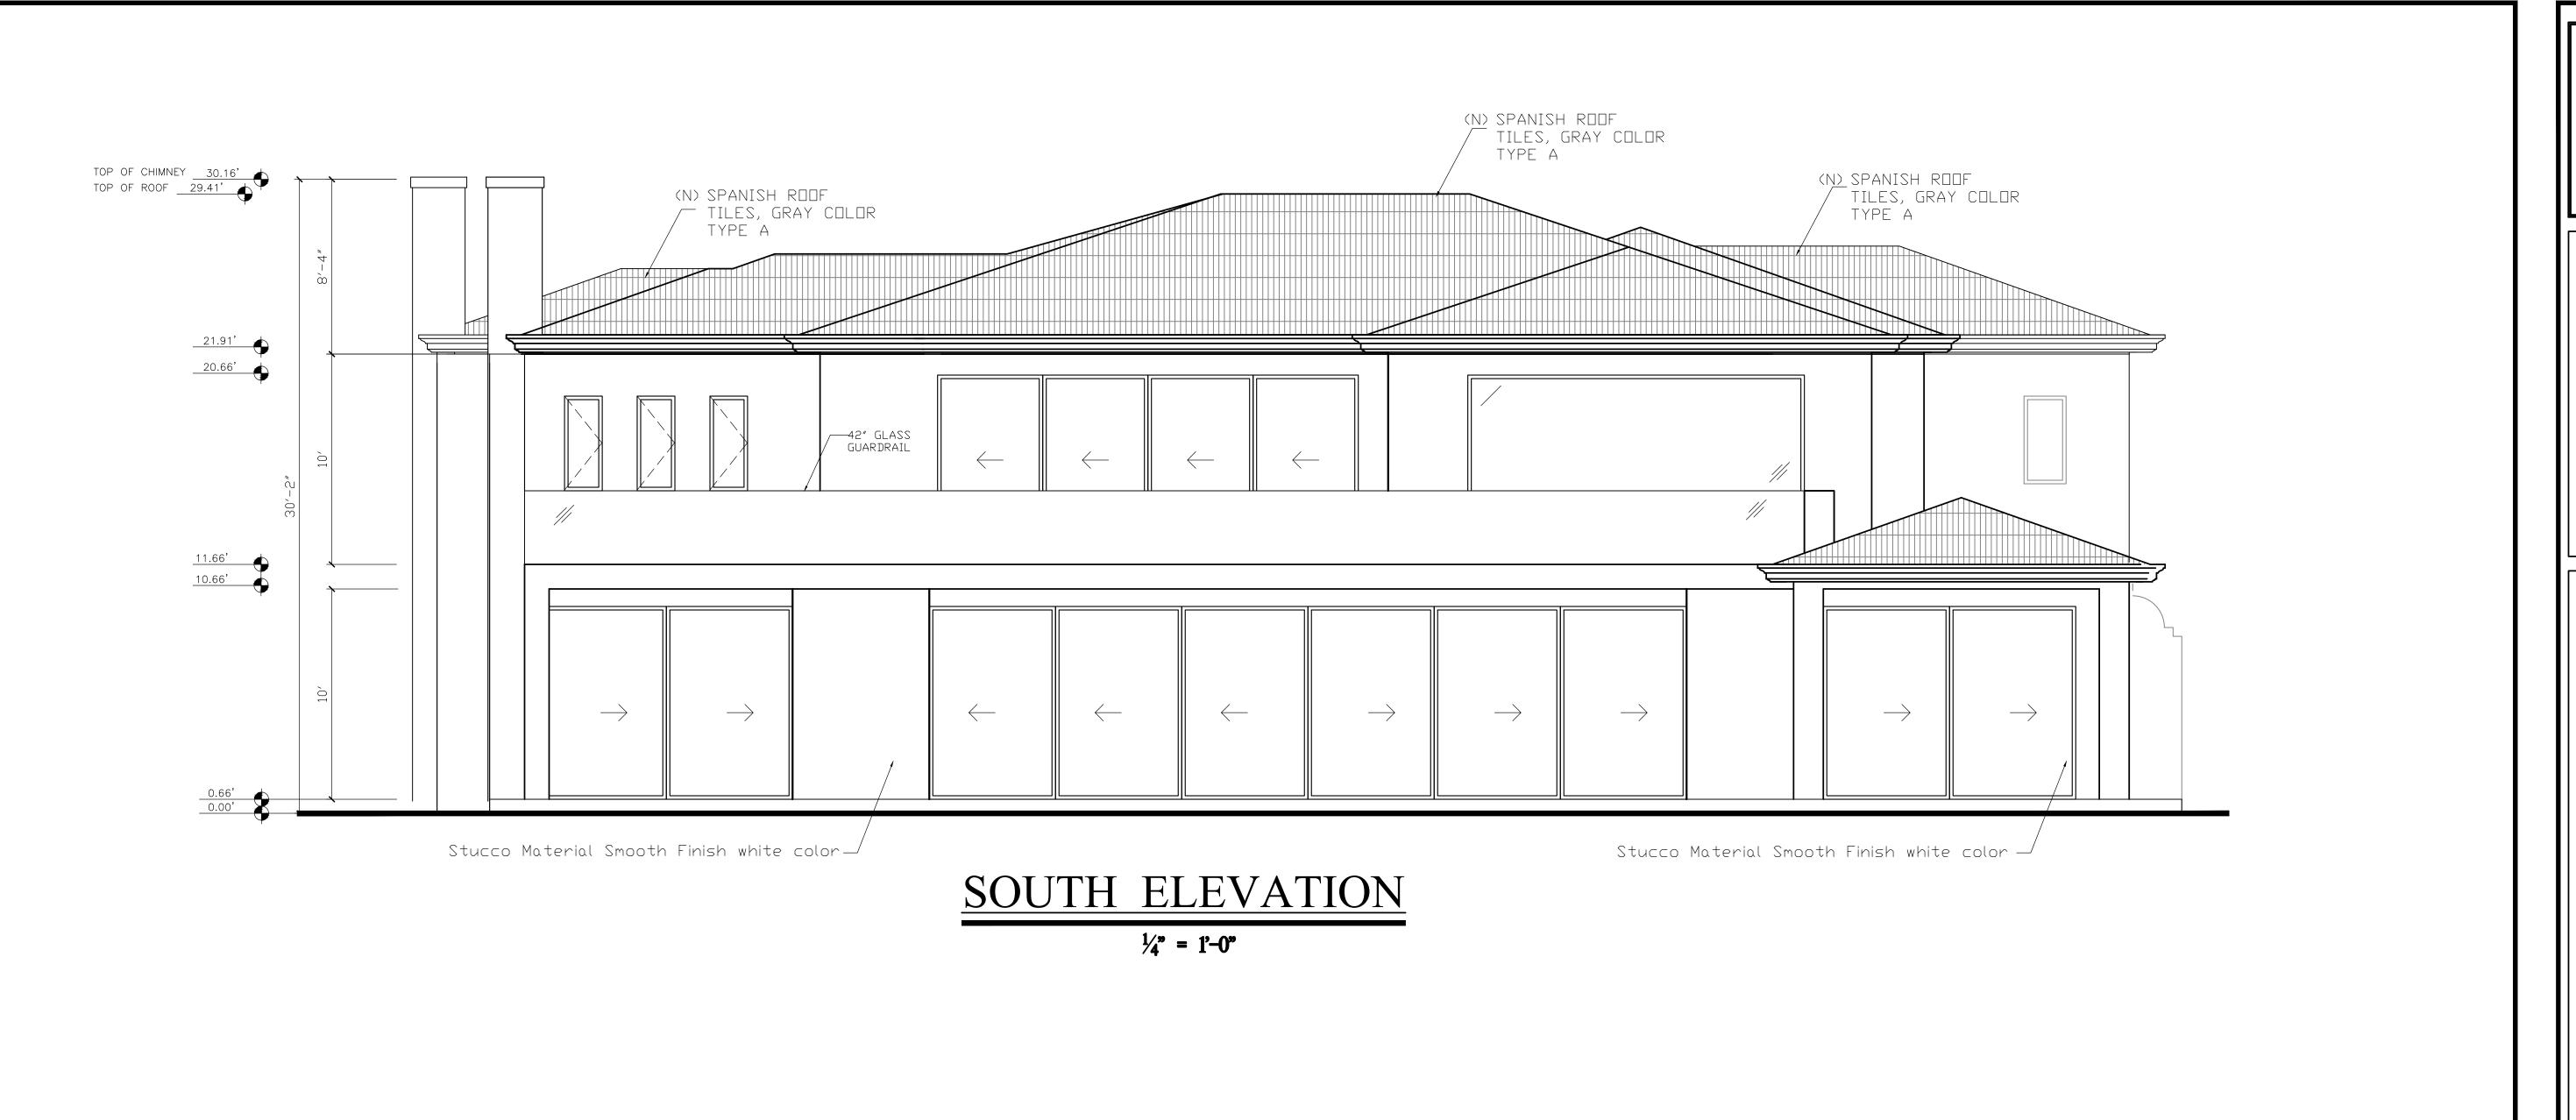

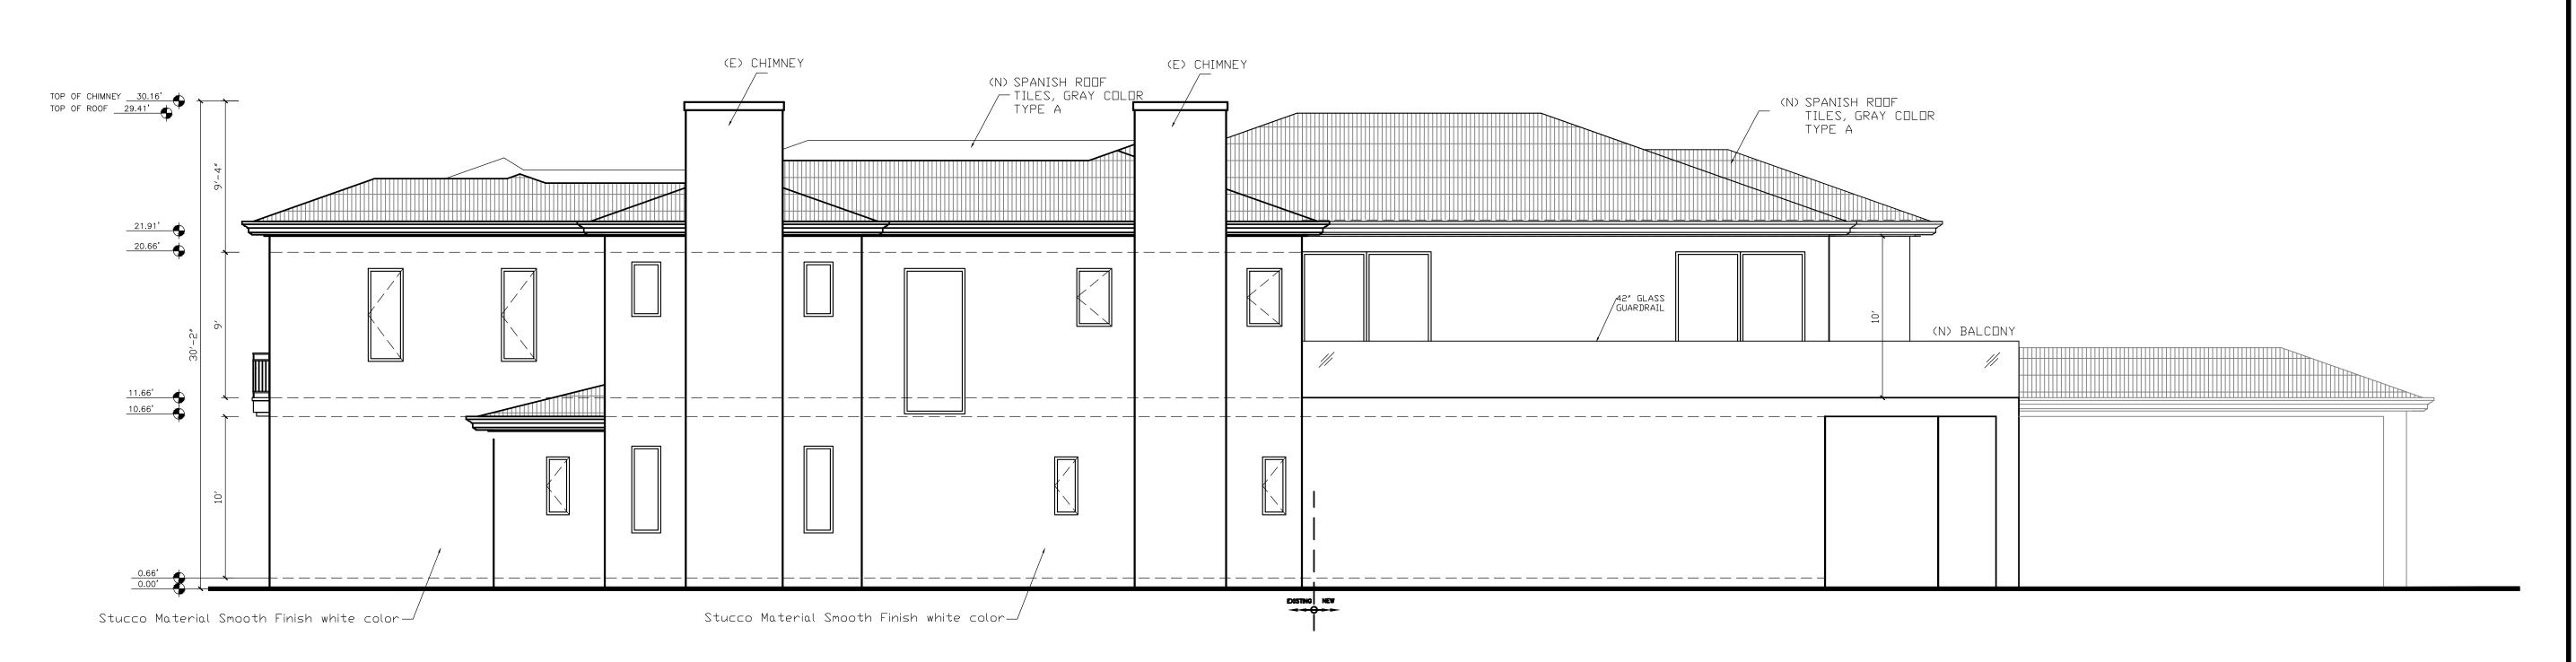

WEST ELEVATION

3/16° = 1'-0°



IVEIRA DESIGN WILSHIRE BLVD, STE P04-1341 ANGELES, CA 90010

AZUL, 91302 DE CA 25510 PRADO | CALABASAS, (

PROPOSED ELEVATIONS

09/27/2020 SCALE: 1/4" = 1'-0" REVISION:

PROJECT #: 19-XXX DRAWN BY: MS





AZUL, 91302

DE CA

25510 PRADO | CALABASAS, (

/EIRA DESIGN VILSHIRE BLVD, STE P04-1341 NGELES, CA 90010


2/17/2021 1/4" = 1'-0" SCALE: REVISION:

SECTIONS

PROJECT #: 19-XXX

DRAWN BY: CO

A6

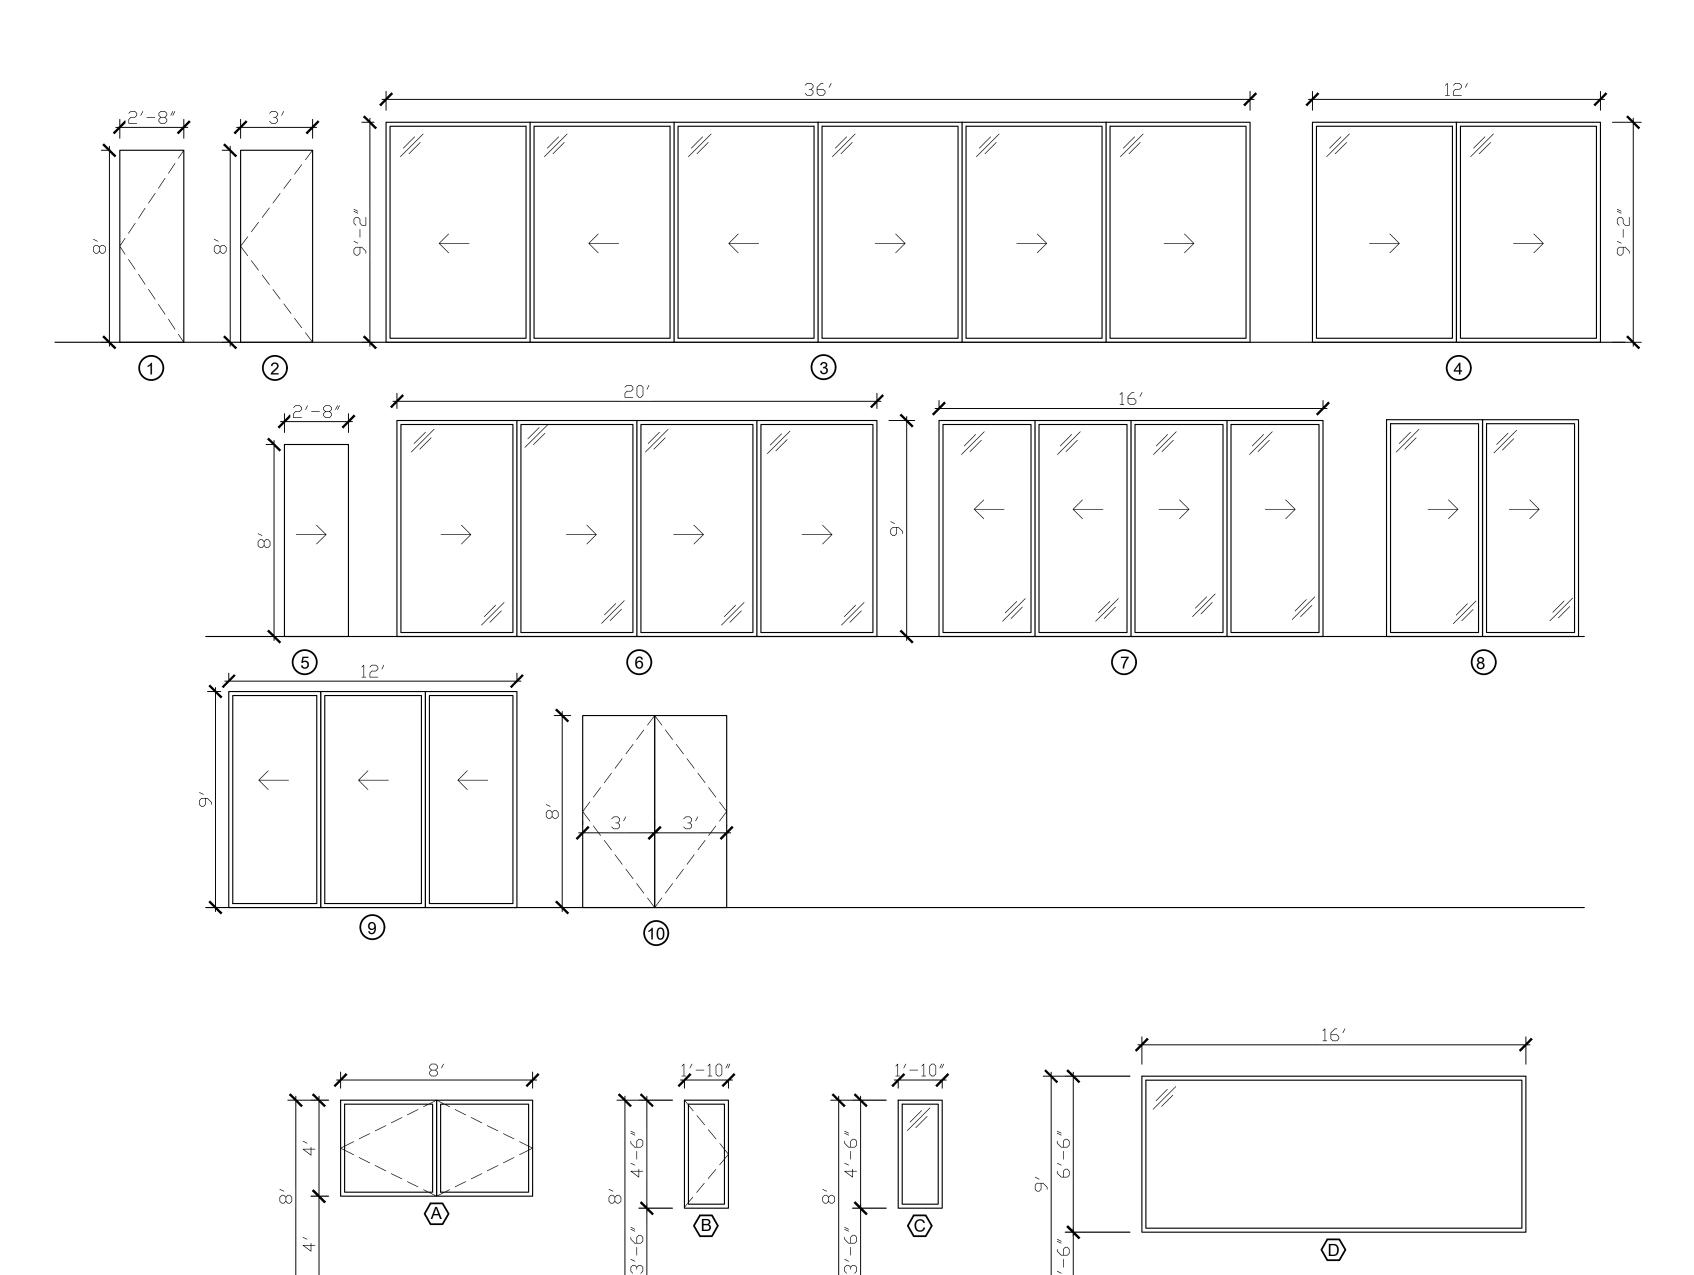

11)								
12								
					•			
		\) I II F		
		VVIIV		v 50	CHEC	JULE	_	
SYM.	TYPE	SI	ZE	FRAME	GLAZING	HEAD HT.	REM	ARKS
		WIDTH	HEIGHT					
A	CASEMENT	8'-0"	4'-0"	ALUM.	DBL/TEMP.	8'-0"		
B	CASEMENT	1'-10"	4'-6"	ALUM.	DBL/TEMP.	8'-0"		
©	FIXED	1'-10"	4'-6"	ALUM.	DBL/TEMP.	8'-0"		
©	FIXED	16'-0"	6'-6"	ALUM.	DBL/TEMP.	9'-0"		

DOOR SCHEDULE								
	SIZ	ZE	THK.	CONST.	FACE	FRAME	GLASS	REMARKS
	WIDTH	HEIGHT						
	2'-8"	8'-0"	1 ¾"	S.C.	PAINTED	WOOD		INTERIOR
	3'-0"	8'-0"	1 3/4"	S.C.	PAINTED	WOOD		INTERIOR
	36'-0"	9'-2"	1 3/4"	S.C.	PAINTED	ALUM.		EXTERIOR/SLIDER/TEMP.
	12'-0"	9'-2"	1 3/4"	S.C.	PAINTED	ALUM.		EXTERIOR/SLIDER/TEMP.
	2'-8"	8'-0"	1 3/4"	S.C.	PAINTED	WOOD		INTERIOR/ POCKET
	20'-0"	9'-0"	1 3/4"	S.C.	PAINTED	ALUM.		EXTERIOR/SLIDER/TEMP.
	16'-0"	9'-0"	1 3/4"	S.C.	PAINTED	ALUM.		EXTERIOR/SLIDER/TEMP.
	8'-0"	9'-0"	1 3/4"	S.C.	PAINTED	ALUM.		EXTERIOR/SLIDER/TEMP.
	12'-0"	9'-0"	1 3/4"	S.C.	PAINTED	ALUM.		EXTERIOR/SLIDER/TEMP.
	6'-0"	8'-0"	1 3/4"	S.C.	PAINTED	WOOD		INTERIOR
		WIDTH 2'-8" 3'-0" 12'-0" 2'-8" 20'-0" 16'-0" 8'-0"	2'-8" 8'-0" 3'-0" 9'-2" 12'-0" 9'-2" 2'-8" 8'-0" 20'-0" 9'-0" 16'-0" 9'-0" 12'-0" 9'-0"	SIZE THK. WIDTH HEIGHT 2'-8" 8'-0" 1 ¾" 3'-0" 8'-0" 1 ¾" 36'-0" 9'-2" 1 ¾" 12'-0" 9'-2" 1 ¾" 2'-8" 8'-0" 1 ¾" 20'-0" 9'-0" 1 ¾" 8'-0" 9'-0" 1 ¾" 8'-0" 9'-0" 1 ¾" 12'-0" 9'-0" 1 ¾"	SIZE THK. CONST. WIDTH HEIGHT 1 ¾" S.C. 3'-0" 8'-0" 1 ¾" S.C. 36'-0" 9'-2" 1 ¾" S.C. 12'-0" 9'-2" 1 ¾" S.C. 2'-8" 8'-0" 1 ¾" S.C. 20'-0" 9'-0" 1 ¾" S.C. 16'-0" 9'-0" 1 ¾" S.C. 8'-0" 9'-0" 1 ¾" S.C. 12'-0" 9'-0" 1 ¾" S.C.	SIZE	SIZE	SIZE

	25510 PRADO I	CALABASAS, (
WINDOW & DOOR	SCHEDULE		

DATE:

SCALE:

REVISION:

PROJECT #: 19-XXX

DRAWN BY: MS

2/17/2021


1/4" = 1'-0"


DE AZUL, CA 91302

DESIGN:
C-OLIVEIRA DESIGN
3680 WILSHIRE BLVD, STE P04-1341
LOS ANGELES, CA 90010
213-357-2151
OFICCE@COLIVEIRADESIGN.COM
www.coliveiradesign.com



EXISTING BACKYARD

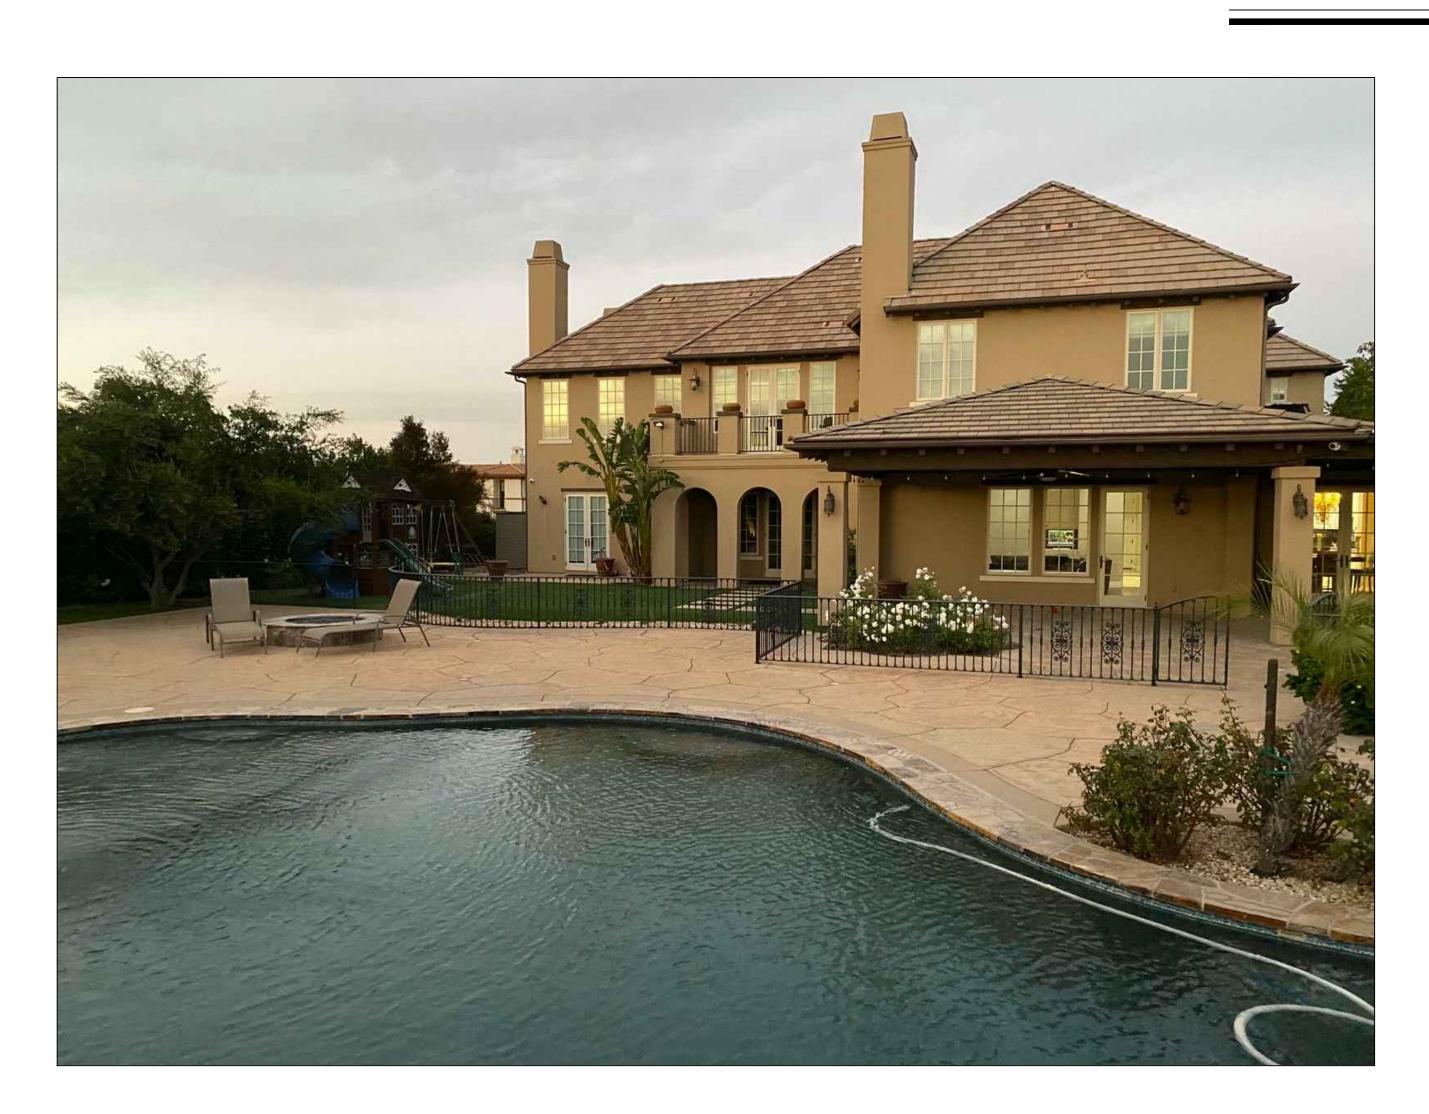

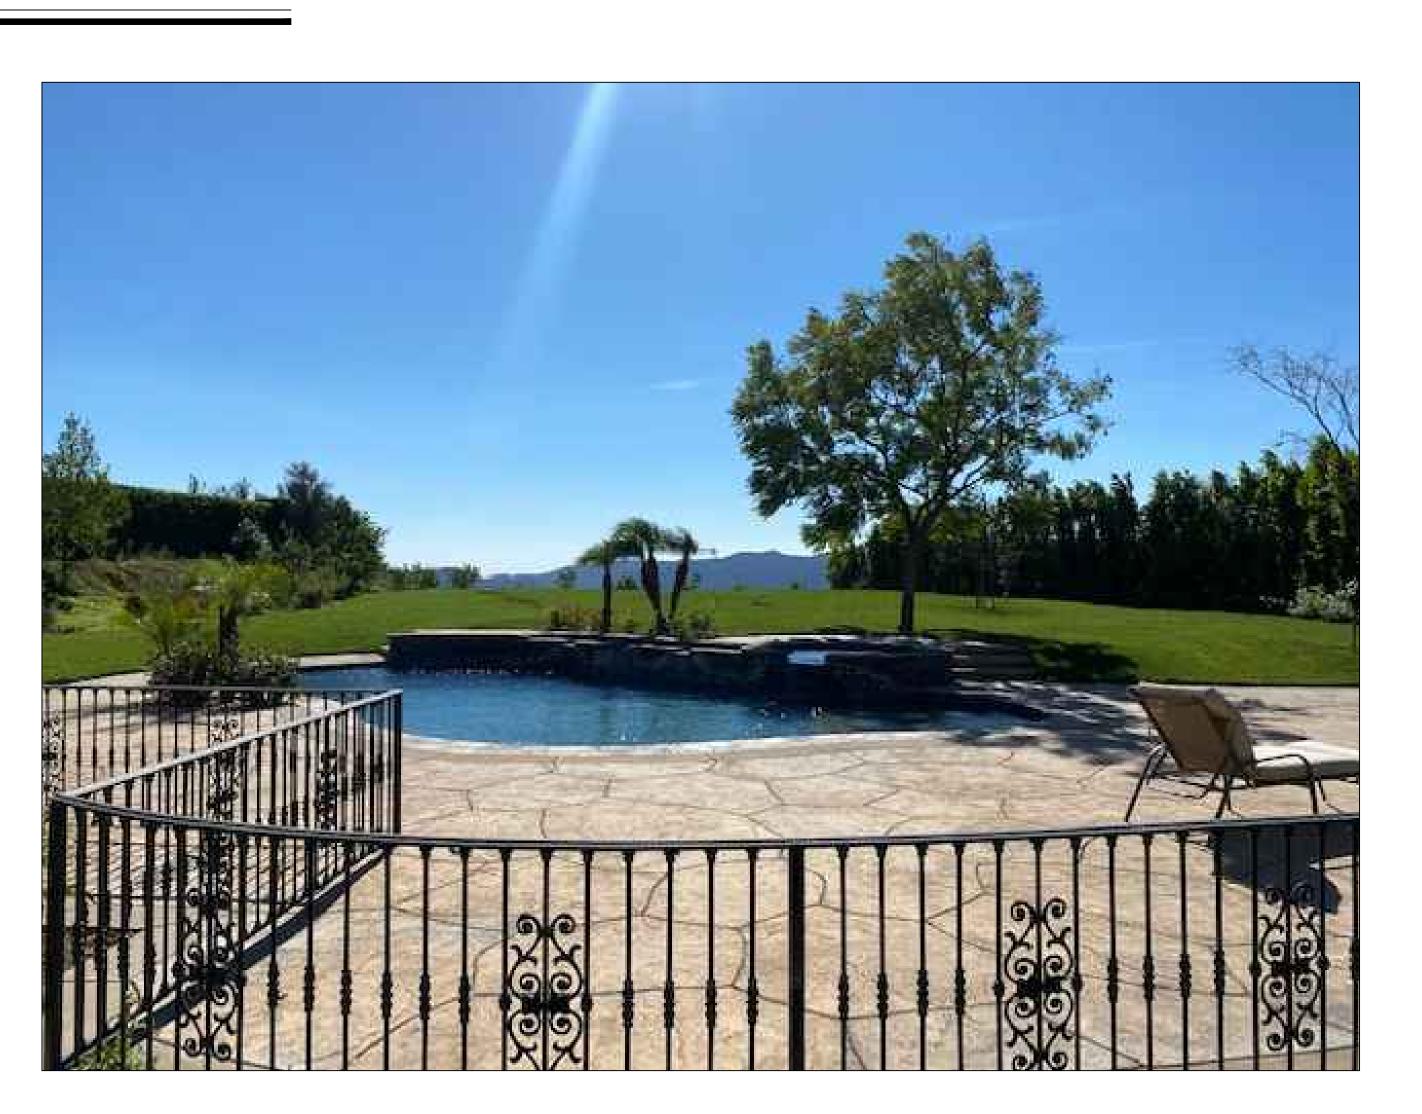

AZUL, 91302 CA S 10 PRADO | LABASAS, (

REVISION:






PROPOSED BACKYARD



FRONT RENDERING

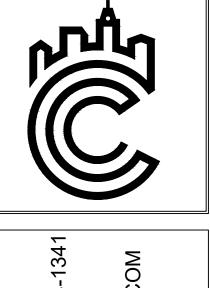

2551 CAL

PROPOSED

SCALE: AS SHOWN REVISION: PROJECT #: 19-XXX

DRAWN BY: MS



3D RENDER

EXTERIOR PAINT MANUFACTURER: DUNN EDWARDS COLOR: COOL DECEMBER MODEL #: DEW383






MANUFACTURER: EAGLE ROOFING COLOR: 3679 LIGHT GRAY PROFILE: CAPISTRANO STYLE: HIGH S STYLE SEMI CYLINDRICAL SPANISH TILE

GLASS WALL SYSTEM/DOORS MANUFACTURER: FLEETWOOD COLOR: BLACK OPERATION: SLIDING GLASS DOOR

EXTERIOR TRIM MANUFACTURER: DUNN EDWARDS COLOR: LEGENDARY GRAY MODEL #: DE6369



WINDOWS MANUFACTURER: ANDERSON WINDOWS COLOR: BLACK STYLE: E-SERIES OPERATION: CASEMENT

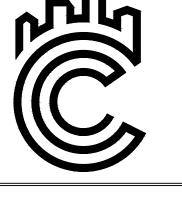

AZUL, 91302 25510 PRADO | CALABASAS, (

3D RENDER

DATE:	09/2	09/27/2020			
SCALE:	AS S	AS SHOWN			
REVISION	ON:				
A					
2					
<u> </u>					
4					
<u>\$</u>					
PROJEC	PROJECT #: 19-XXX				
DRAWN	I BY: N	IS			



25541 PRADO DE AZUL (ACROSS THE STREET - 3 DOORS AWAY) Building Area: 6,745 SF. Lot Area: 14,465 SF. FAR: 0.47



25521 PRADO DE AZUL (ACROSS THE STREET - 2 DOORS AWAY) Building Area: 6,797 SF. Lot Area: 17,224 SF. FAR: 0.39



25471 PRADO DE AZUL (ACROSS THE STREET - 4 DOORS AWAY) Building Area: 6,745 SF. Lot Area: 14,299 SF. FAR: 0.47





25500 PRADO DE AZUL (HOUSE TO THE LEFT) Building Area: 5,858 SF. Lot Area: 27,869 SF. FAR: 0.21



25510 PRADO DE AZUL (PROPOSED HOUSE) Proposed Building Area: 9,914 SF. Lot Area: 28,533 SF. Proposed FAR: 0.35



25520 PRADO DE AZUL (HOUSE TO THE RIGHT) Building Area: 5,802 SF. Lot Area: 20,956 SF. FAR: 0.27



AZUL, 91302 DE CA 2551 CAL

DA	TE:	DATE					
SC	ALE:	SCALE					
RE	:VISION:						
A							
2							
3							
4							
\$							
PR	OJECT #:	19-XXX					
DR	AWN BY:	MS					


FRONT NEIGHBOR COMPARABLE to PROPOSED



25521 PRADO DE AZUL (ACROSS THE STREET - 2 DOORS AWAY)

COMPARABLE HEIGHT: 30'-2" (SAME)

COMPARABLE WIDTH: 78'-5" (SAME)

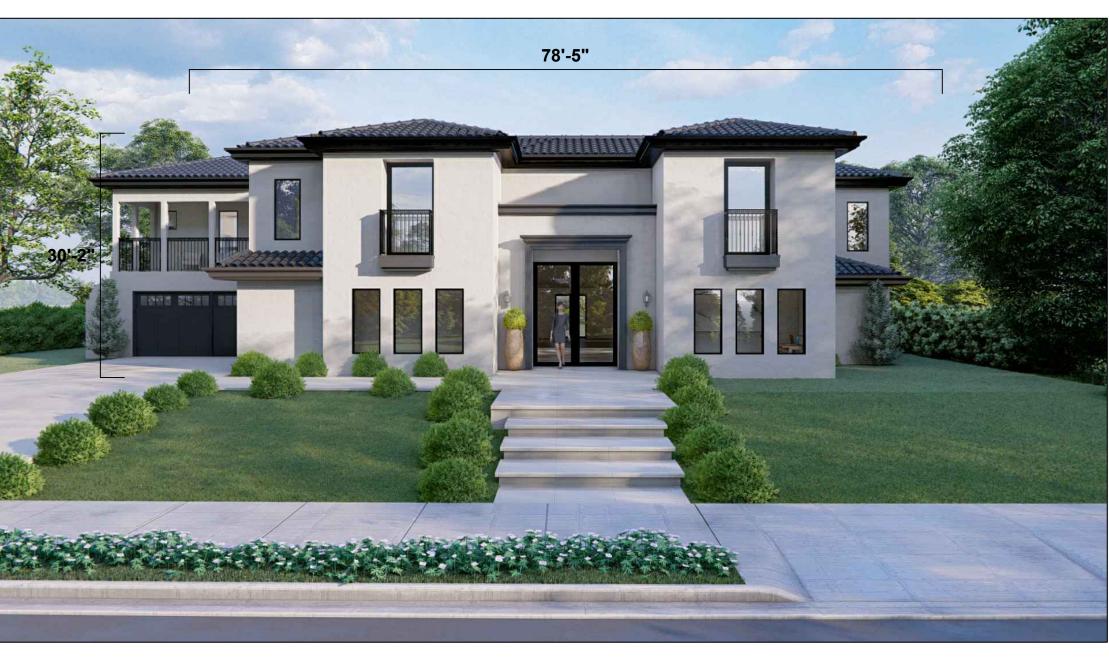

25510 PRADO DE AZUL (PROPOSED FRONT ELEVATION)


REAR EXISTING COMPARABLE to PROPOSED




25510 PRADO DE AZUL (EXISTING REAR ELEVATION)

COMPARABLE HEIGHT: (E) 34'-7" (N) 30'-2" (REDUCED)

COMPARABLE WIDTH: 78'-5" (SAME)

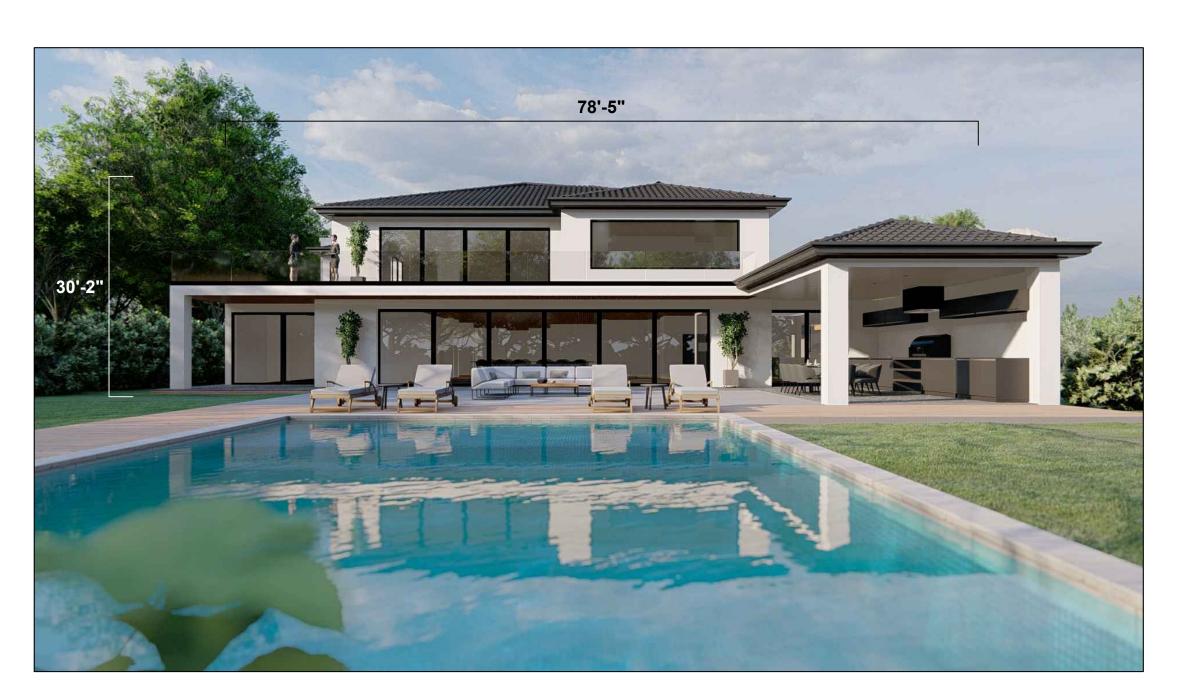

25510 PRADO DE AZUL (PROPOSED REAR ELEVATION)

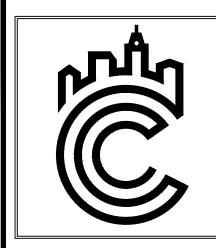

VILSHIRE BLVD, STE P04-134 VILSHIRE BLVD, STE P04-134 VGELES, CA 90010 7-2151 E@COLIVEIRADESIGN.COM

213-357-2151
OFICCE@COLIVEIR

25510 PRADO DE AZUL, CALABASAS, CA 91302

EXISTING VS. PROPOSED

DATE:	DATE
SCALE:	SCALE
REVISION:	
<u> </u>	
◬	
PROJECT #:	19-XXX

SHEET ____

D5